



PLANNING SUBMISSION DRAWING

NOTES:
1- ALL DIMENSIONS TO BE CHECKED ON SITE ANY
DISCREPANCY BROUGHT TO THE ATTENTION
IMMEDIATELY

2- ALL STRUCTURAL WORKS TO BE CARRIED OUT TO ENGINEERS DESIGN AND STRICTLY UNDER HIS SUPERVISION

3- CONTRACTOR TO TAKE FULL RESPONSIBILITY FOR ALL DESIGN, ERECTION AND TEMPORARY WORKS

EXISTING FIRST FLOOR PLAN

SCALE 1:100
A3

ADDITIONS ALTERATION TO:
32 CHURCH STREET
CROYDON CRO 1RB

Mr. Shakeel

FOR:


DWG NO N/02


Planning Additions Ltd

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DRAINAGE:

1-THE SYSTEM SHOULD BE DESIGNED AND INSTALED TO RETAIN WATER SEALS IN TRAPS UNDER WORKING CONDITIONS

2-EACH FITTING SHOULD BE PROVIDED WITH75MM DEEP-SEAL TUBULAR TRAP (EXCEPT TO W.C WITH 50MM TRAP)

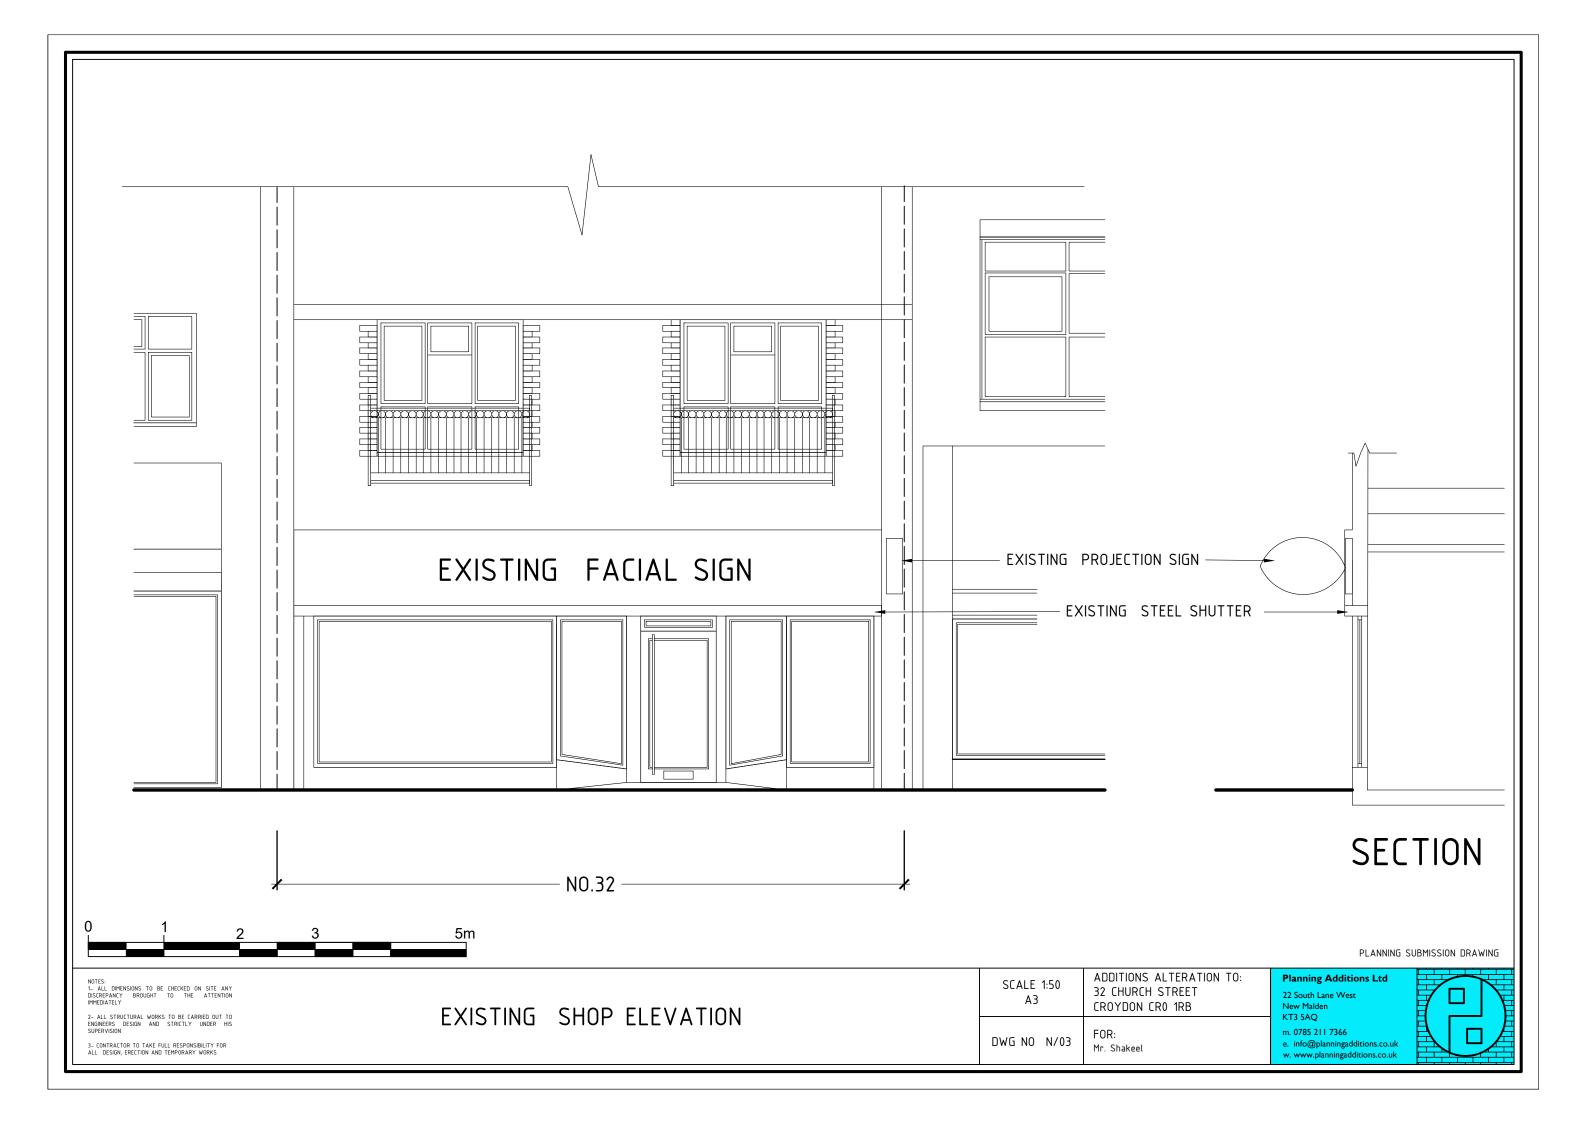3-WHERE FITTINGS CANOT BE CONECTED TO THE SVP INDIVIDUALY, A COMMON PIPE IS ACCEPTABLE PROVIDED:

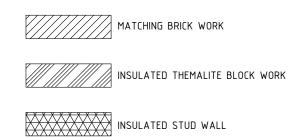A-LAVATORY BASINS AND OTHER HIGH LEVEL FITTINGS BE SEPERATELY DRAINED FROM SHOWERS, BATHS AND OTHER LOW LEVEL FITTINGS

B-INDIVIDUAL PIPES SHPULD DISCHARGE INTO THE UPPER 1/3rd OF THEPERIMETER OF THE COMMON PIPE

C-THE DIAMETER OF THE COMMONPIPE SHOULD BE DEPENDENT UPON THE NUMBER OF FITTINGS DISCHARGEING INTO AND THE LENGTH AND NUMBER OF BENDS IN THE PIPE AND NOT LESS THAN 50MM DIAMETER

D-VENTING TO THE END OF THE PIPE IS REQUIRED. WHERE IT DISCHARGES

INTO A NATURALLY VENTED SVP, THE COMMON PIPE CAN BE VENTED WITH AN AAV

E-PIPE WORK SHOULD BE SECURELY CLIPPED
TO THE BUILDING STRUCTURE, AND SET TO FALL
AT 1 1/4DEG TOWARDS 2 1/2 DEG TOWARDS THE
POINT OF DISCHARGE F-THE SVP SHOULD

TERMINATE TO ATMOSPHERE WITH A DURABLE CAGE SET ATLEAST 900MM ABOVE ANY OPENING INTO A BUILDING WITH 3.00M

EXTRACT FAN

SMOKE DETECTOR MAINS OPERATED COMPLETE WITH SOUNDER BASE

HEAT DETECTOR MAINS OPERATED COMPLETE WITH SOUNDER BASE

P65 RATED DOWNLIGHT LUMINAIRE

F FIRE EXTINGUISHES


EMERGENCY LIGHT

F.E FIRE EXIT (APPROVED SOUNDERS TO MAINS AS PER FIRE OFFICERS APPROVAL

FIRE ALARM BREAK GLASS TO BE PROVIDED ADJACENT TO FINAL EXISTS


FAD FIRE ALARM CONTROL PENAL

CCTV CAMERA

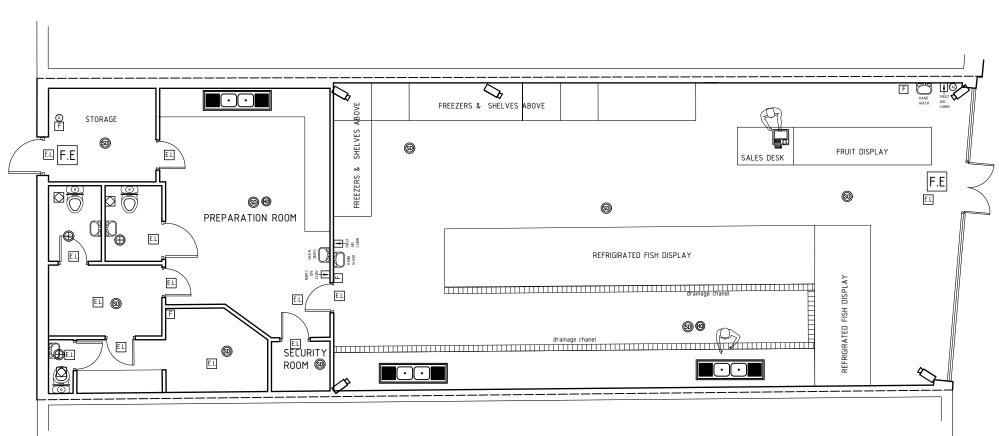

- ALL LIGHTING AND ELECTRICAL WORK WILL
 BE DESIGNED, INSTALLED INSPECTED AND
 TESTED IN ACCORDANCE TO THE
 REQUIREMENTS A SELF CERTIFICATION
 CERTIFICATE IS TO BE SEND TO THE
 LOCAL AUTHORITY WITH IN 30 DAYS OF
 COMPLETION OF THE ELECTRICAL
 WORKS.THE CLIENT MUST RECEIVE BOTH A
 COPY OF THE SELF CERTIFICATION
 CERTIFICATE AND A BS 7671 ELECTRICAL
 INSTALLATION TEST CERTIFICATE AND
 FORWARD COPIES TO BUILDING CONTROL
- SMOKE ALARMS: PROVIDE SMOKE
 DETECTORS BASED ON A LINKED SMOKE
 ALARM SYSTEM TO EXISTING MAINS
 SUPPLIES TO BUILDING STANDARDS
- TREES IN THE VICINITY TO BE NOTED AND IMPLICATION TO THE FOUNDATION OF THE EXTENSION CONFIRMED WITH BUILDING INSPECTOR
- MANHOLES/SEWAGE PIPES LOCATIONS TO BE CONFIRMED AND REPOSITIONED AS PER THAMES WATER REQUIREMENTS AND TO THE BUILDING INSPECTORS APPROVAL.
- SEWARAGE PIPE TO BE BRIDGED OVER BY CONCRETE LINTEL TO AVOID LOAD TRANSFER ON TO PIPE
- PROVIDE RODDING EYES AT DRAINAGE JUNCTIONS. BRIDGE SOIL PIPES PASSING UNDER NEW WALLS WITH CONCRETE LINTELS. DRAINS ARE TO HAVE MINIMUM FALL OF 1 IN 40 AND ARE TO BE SURROUNDED IN PEA SHINGLE ALL DETAILS TO BE APPROVED BY RESPECTIVE DEPARTMENT ALL WORK TO BE CARRIED OUT TO L.A APPROVAL AND TO COMPLY WITH BUILDING REGULATIONS ALL DETAILS TO BE APPROVED BY RESPECTIVE ENGINEER ALL WORK TO BE CARRIED OUT TO L.A APPROVAL AND AND TO COMPLY WITH BUILDING REGULATIONS

SEWARAGE PIPE TO BE 600MM AWAY FROM ANY FOUNDATION FILLED WITH PEA SHINGLE AND BRIDGED WITH CONCRETE LINTEL OVER

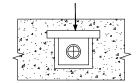

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10m

SCALE 1:100
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FOR:
M. Cithering

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