




EXISTING EXTERNAL PLAN  
SCALE 1:100

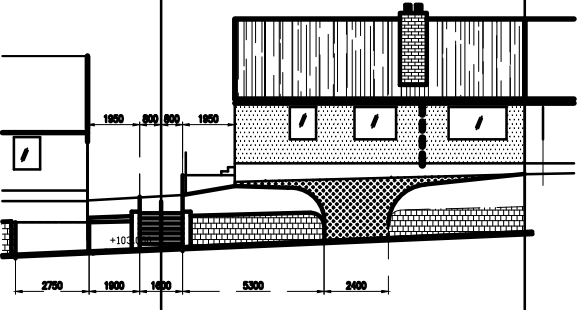


EXISTING EXTERNAL WEST ELEVATION  
SCALE 1:100

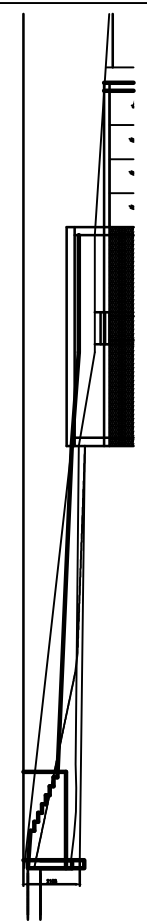


EXISTING CROSS SECTION  
LOOKING SOUTH  
SCALE 1:100

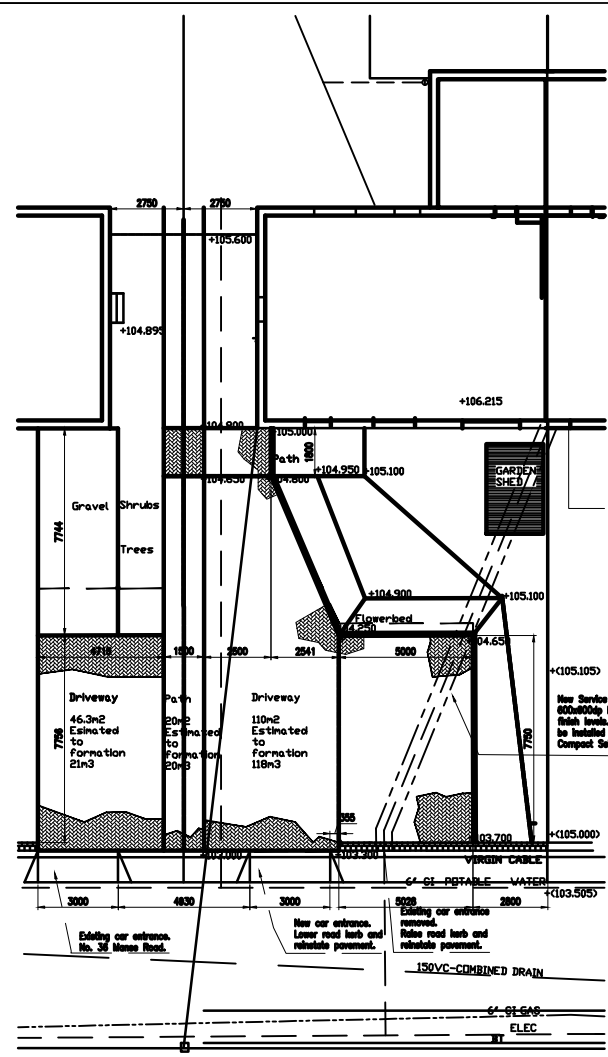


PROPOSED EXTERNAL PLAN  
SCALE 1:100

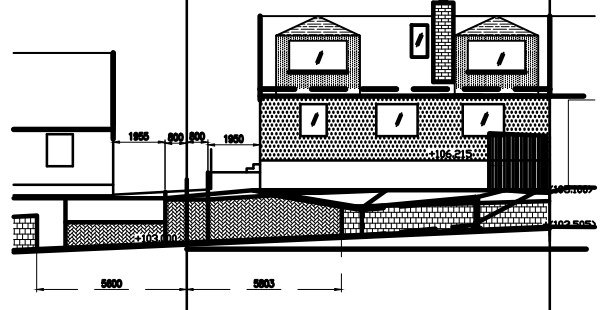

PROPOSED EXTERNAL WEST ELEVATION  
SCALE 1:100

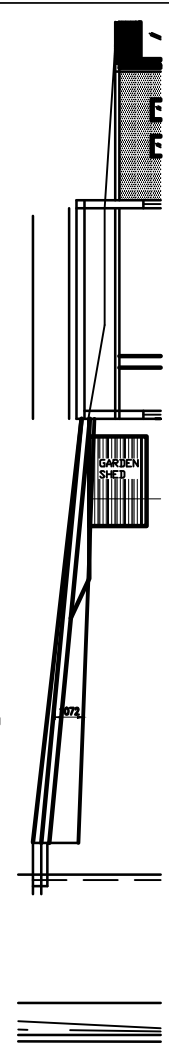

PROPOSED CROSS SECTION LOOKING SOUTH  
SCALE 1:100

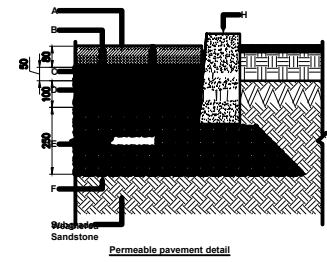

Permeable pavement detail

- NOTES**
1. PROPOSED GROUND LEVELS TO BE GRADED TO MATCH EXISTING ON ALL BOUNDARIES.
  2. ALL SERVICES TO BE PROTECTED AND DIVERTED AS SHOWN ON PROPOSED DETAILS.

- Legend of Finishes**
- Roof Tile - Red
  - Mortar - exposed chips to match existing
  - Glass
  - Stone - To match existing
  - Timber - Treated beech-Silver
  - GRP - Black/Dark Gray
  - Permeable Paving Marshalls Priora
  - Granular ground surface
  - Brickwork - Red
  - Concrete paving slabs

WE HEREBY CERTIFY THAT THIS IS A TRUE COPY OF THE PLAN REFERRED TO IN THE APPLICATION FOR BUILDING WARRANT.  
DATE: 01.02.2021  
SIGNED: \_\_\_\_\_

**PLANNING DEPARTMENT**  
Applicant: **KERRY**  
Project title: **38 Manse Road Lillingow BH60AR**

Drawing title: **DRIVEWAY PLANS ELEMENTS AND DETAILS**

Drawn PFK	Checked	Approved
Date Feb 21	Date	Date
Scale AS NOTED		

Drawing Number: 2021-MR-001

A. PERMEABLE PAVED BY MARSHALLS PRIORA 150MMx150MM SP.  
B. JOINT FILLING MATERIAL. ASPEN 10 x 20 x 2.5 (10MM) AGGREGATE  
C. BINDER COURSE. 40 TO 50 MM. ASPEN 10 x 20 x 2.5 (10MM) AGGREGATE  
D. BASE COURSE. 100 MM. ASPEN 10 x 20 x 2.5 (10MM) AGGREGATE  
E. SUBGRADE COURSE. 150MM TO 200MM FINE SAND  
F. GEOTEXTILE. 1000g 1000