
## BATH ROOM BED ROOM 8 BED ROOM 7 BATH ROOM LANDING BED ROOM 9 BED ROOM 9

SECOND FLOOR PLAN AS PROPOSED

SCALE 1:50@A1

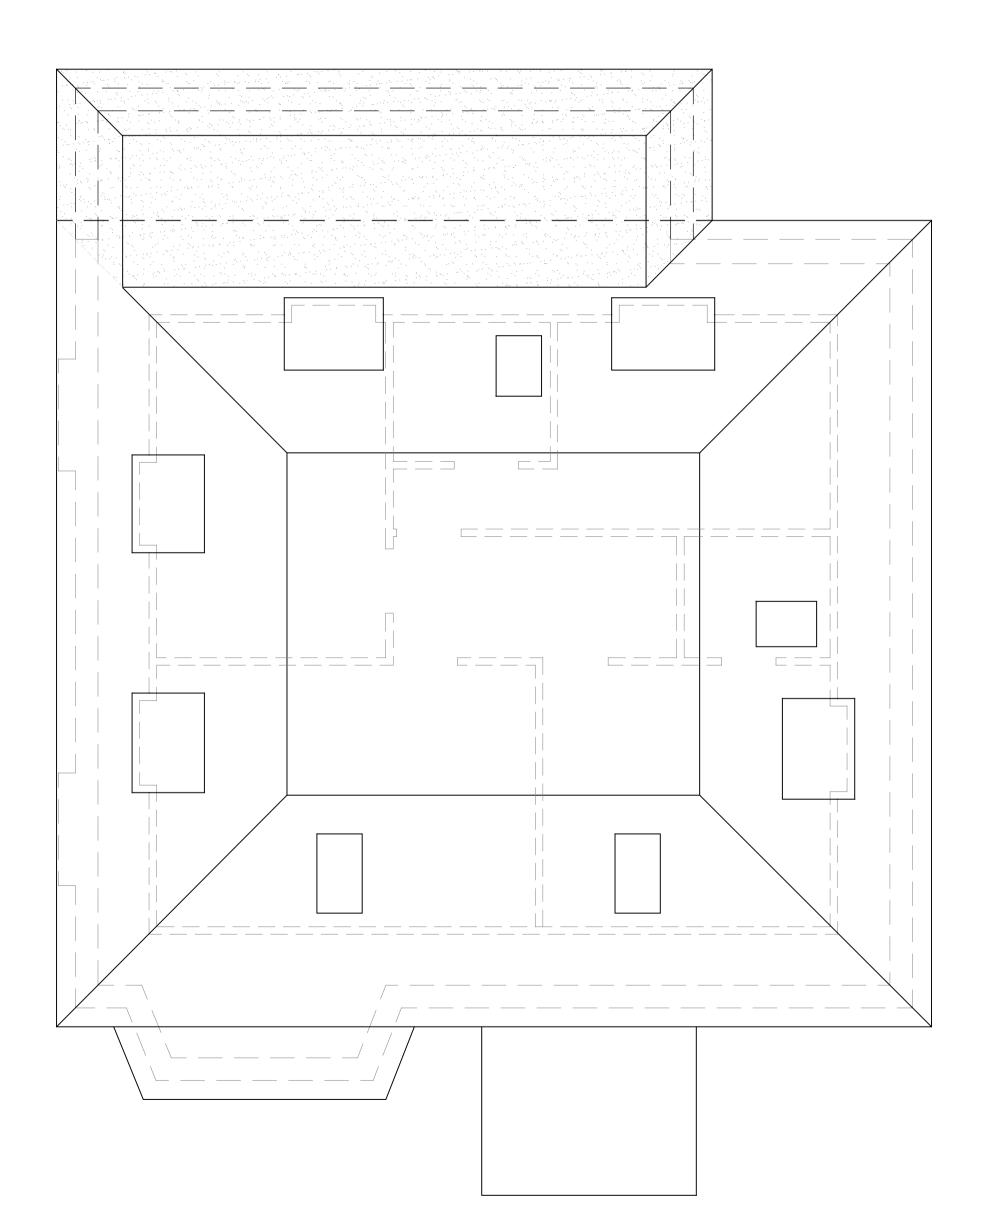

ROOF PLAN AS PROPOSED
SCALE 1:50@A1

NOTES

GENERAL

<u>Copyright.</u> No part of this drawing or any other drawings, details, calculations or schedules pertaining to this project as titled (including any notes therein) may be reproduced in any form either in part or whole without the prior permission in writing of Derek LOFTY & Associates.

All dimensions are in millimeters. Unless noted otherwise.

Do not scale this drawing – other than for planning purposes.

If in doubt - ASK!

This drawing is not to be used for setting out.

All sizes and dimensions to be checked on site prior to commencement and confirmed by the Architect. This drawing is to be read in conjunction with all other relevant drawings and details.

Materials and workmanship must be of a standard conforming with the appropriate recognised authority. For example "National House Building Council", "British Standards Institution", "Department of the Environment – (Building Regulations 1991)" etc.

HEALTH & SAFETY

The Contractor must at all times operate safe working practices, , maintain the integrity of the existing structures, and conform to all the appropriate requirements of the Health & Safety Executive including the "Construction (Health, Safety and Welfare) Regulations 1996".

The working methods of any hazardous operations must first be discussed with the designer and or project manager prior to commencement

Rev Amendments Date

Client:
PRIVATE CLIENT

Project:
5 GROSVENOR GARDENS
LONDON

NW11 0HH

Title:

REAR EXTENSION

PROPOSED PLANS

Status: PLANNING ISSUE

Derek LOFTY & Associates



The Lodge Studio | Copthorne Road | Croxley Green Hertfordshire | WD3 4AQ

Structural Engineering
T: 01923 774373 | F: 01923 896299
e: info@dlaconsultants.co.uk

DATE SCALE DRAWING NO DRAWN Rev

NOV-20 SHOWN 11566/203 WD -

3 metres @ 1:50 5m 5 metres @ 1:100 10m

© Derek LOFTY & Associates

Date as title block Original size A1