



Roof lights to protrude no more than 150mm from slope of roof

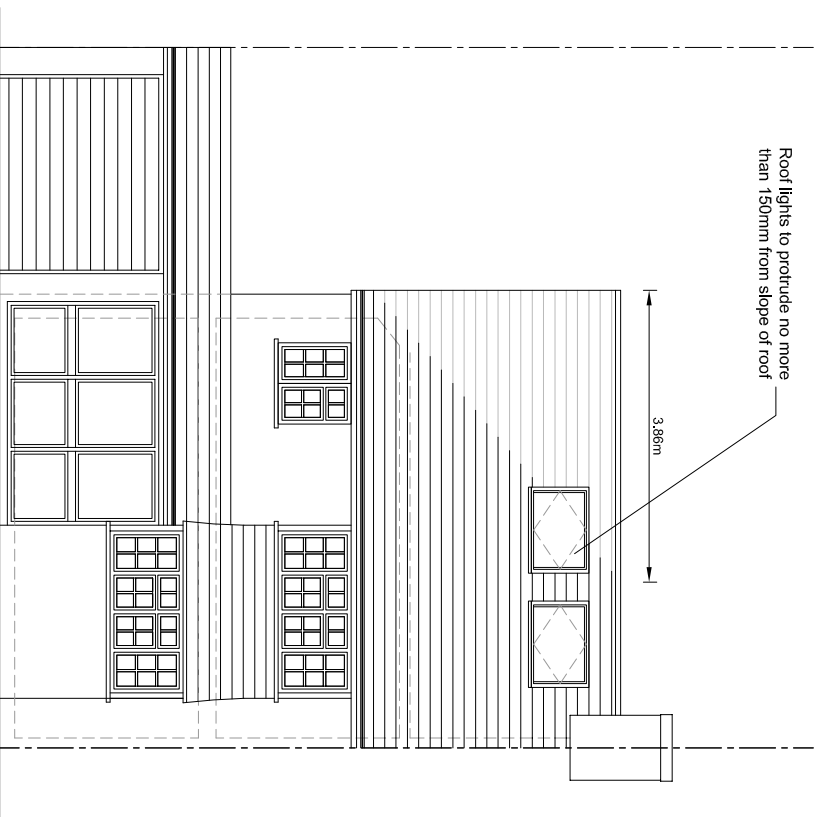

Proposed Front Elevation


Proposed materials to be similar in appearance to existing

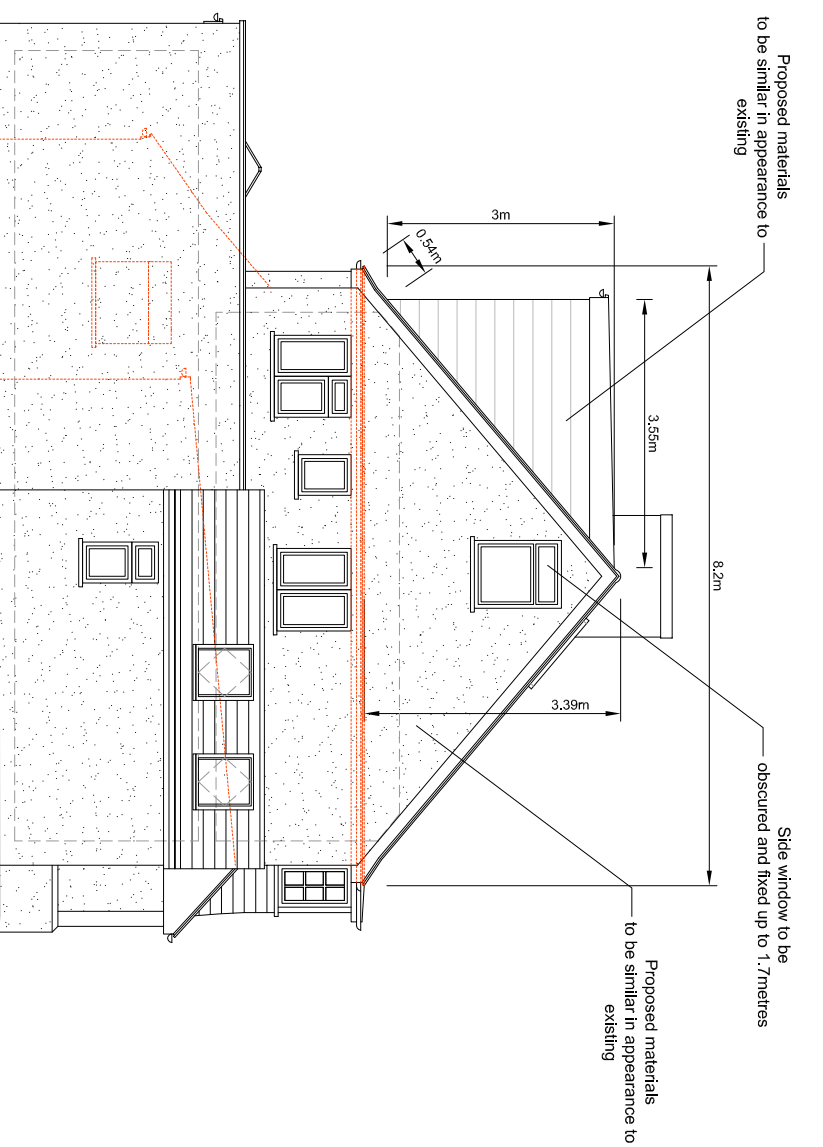


Proposed Side Elevation

Additional Volume Calculation for PD
 Hip to Gable
 $3.86m \times 8.20m \times 3.39m / 6 = 17.88m^3$
 Dormer
 $5.80m \times 3.00m \times 3.55m / 2 = 30.89m^3$
 Total 48.76m³

Proposed materials to be similar in appearance to existing

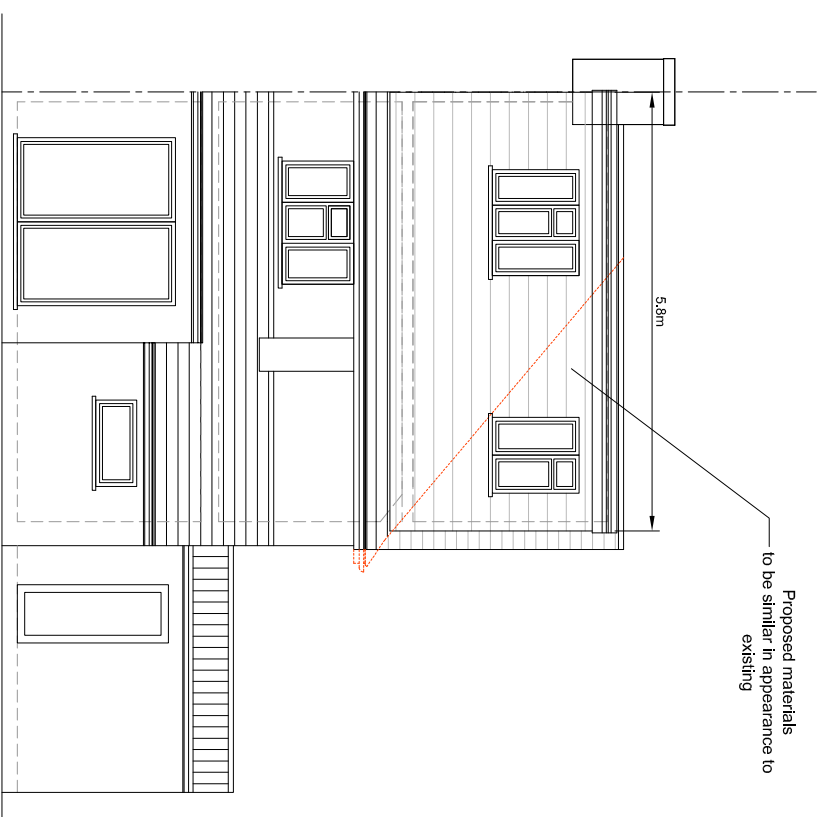

Proposed Rear Elevation

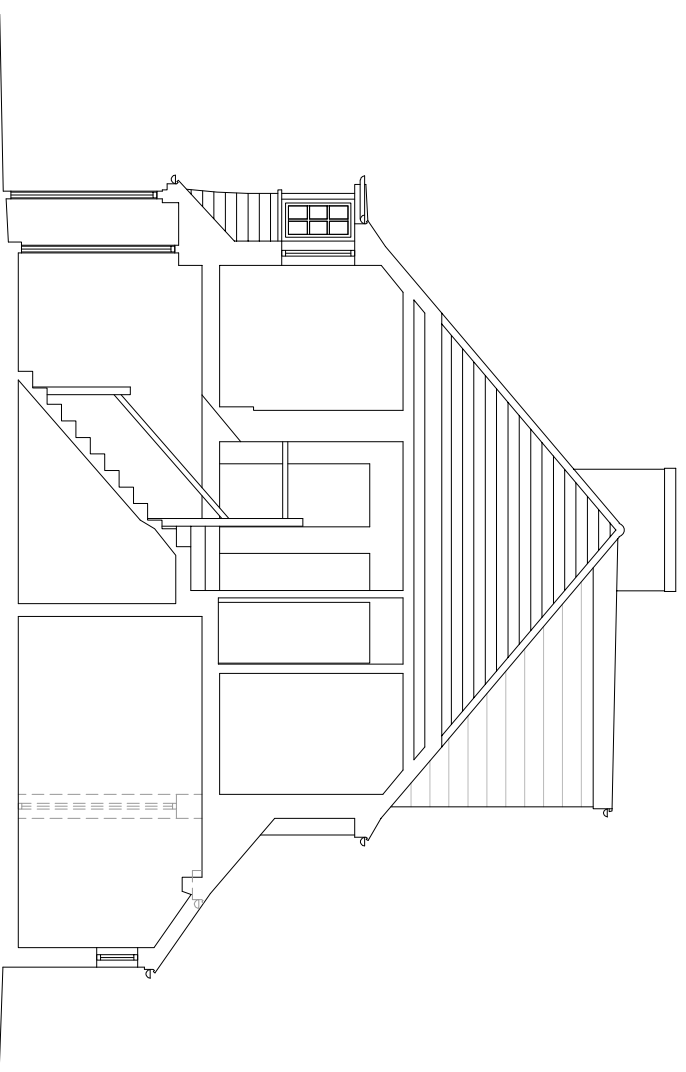

Proposed Section A-A

Rev	Date	Description



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Proposed Elevations and Section

1 : 100 @ A3

Dwg No. FLU.1246.2.05

Scale 1:100 @ A3

Date 03.09.20

Rev

Drawn P. Ferranti