




EXISTING GROUND FLOOR PLAN
SCALE 1:50

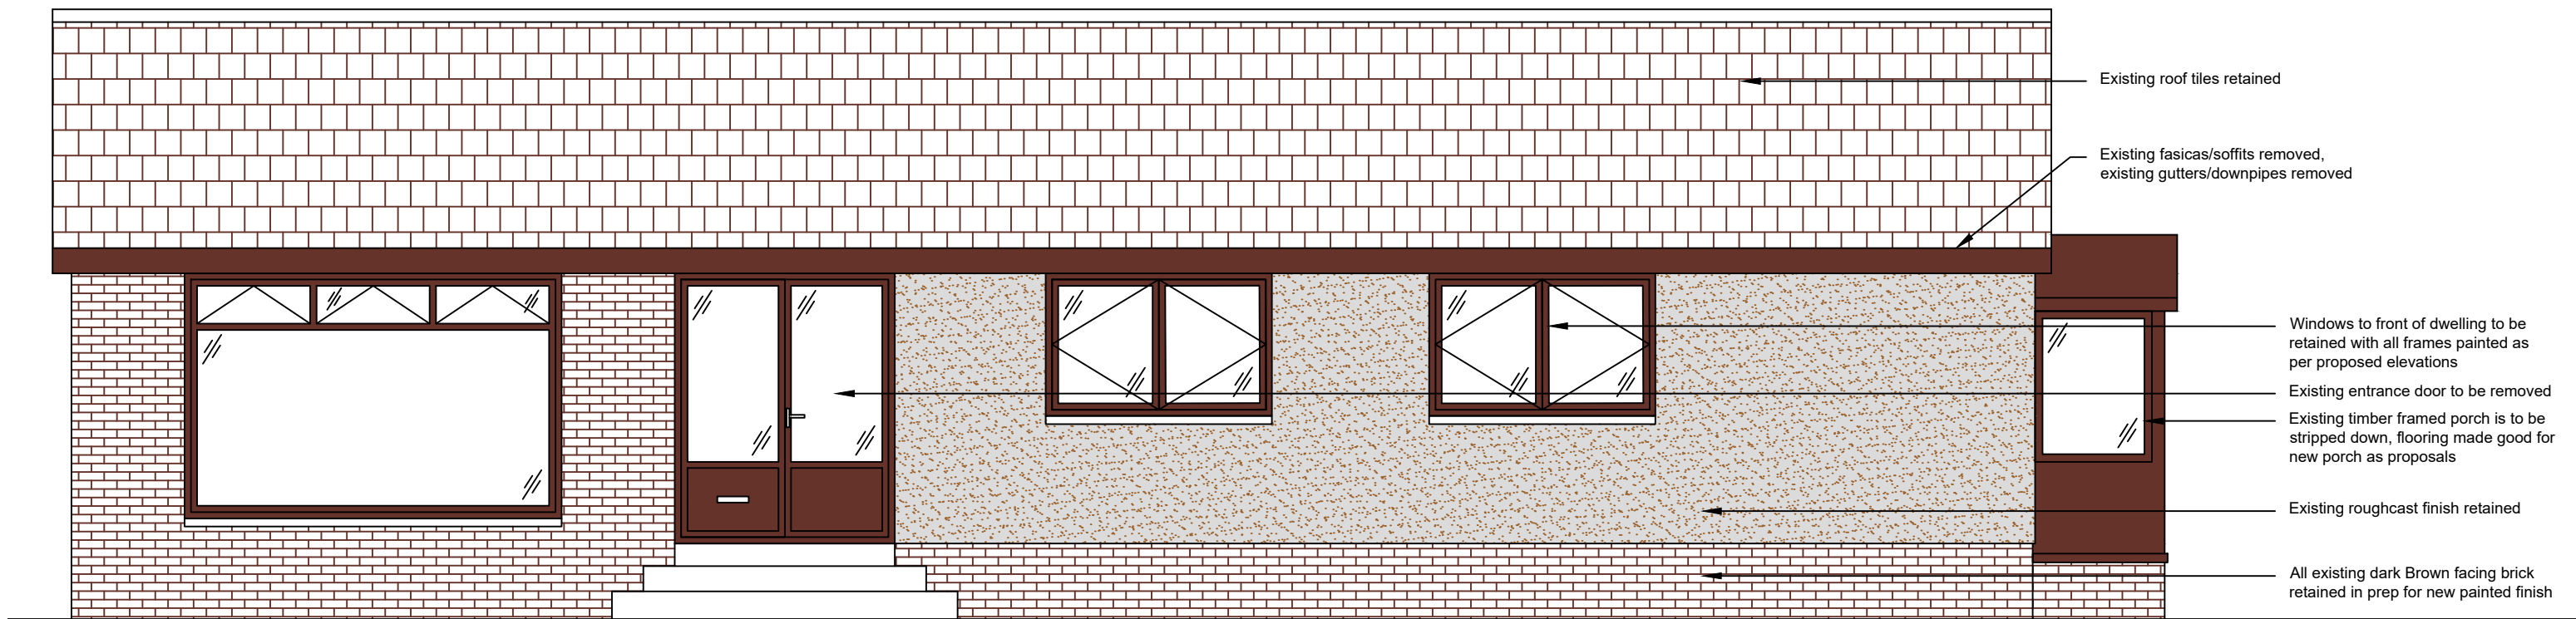


EXISTING FRONT ELEVATION
SCALE 1:50

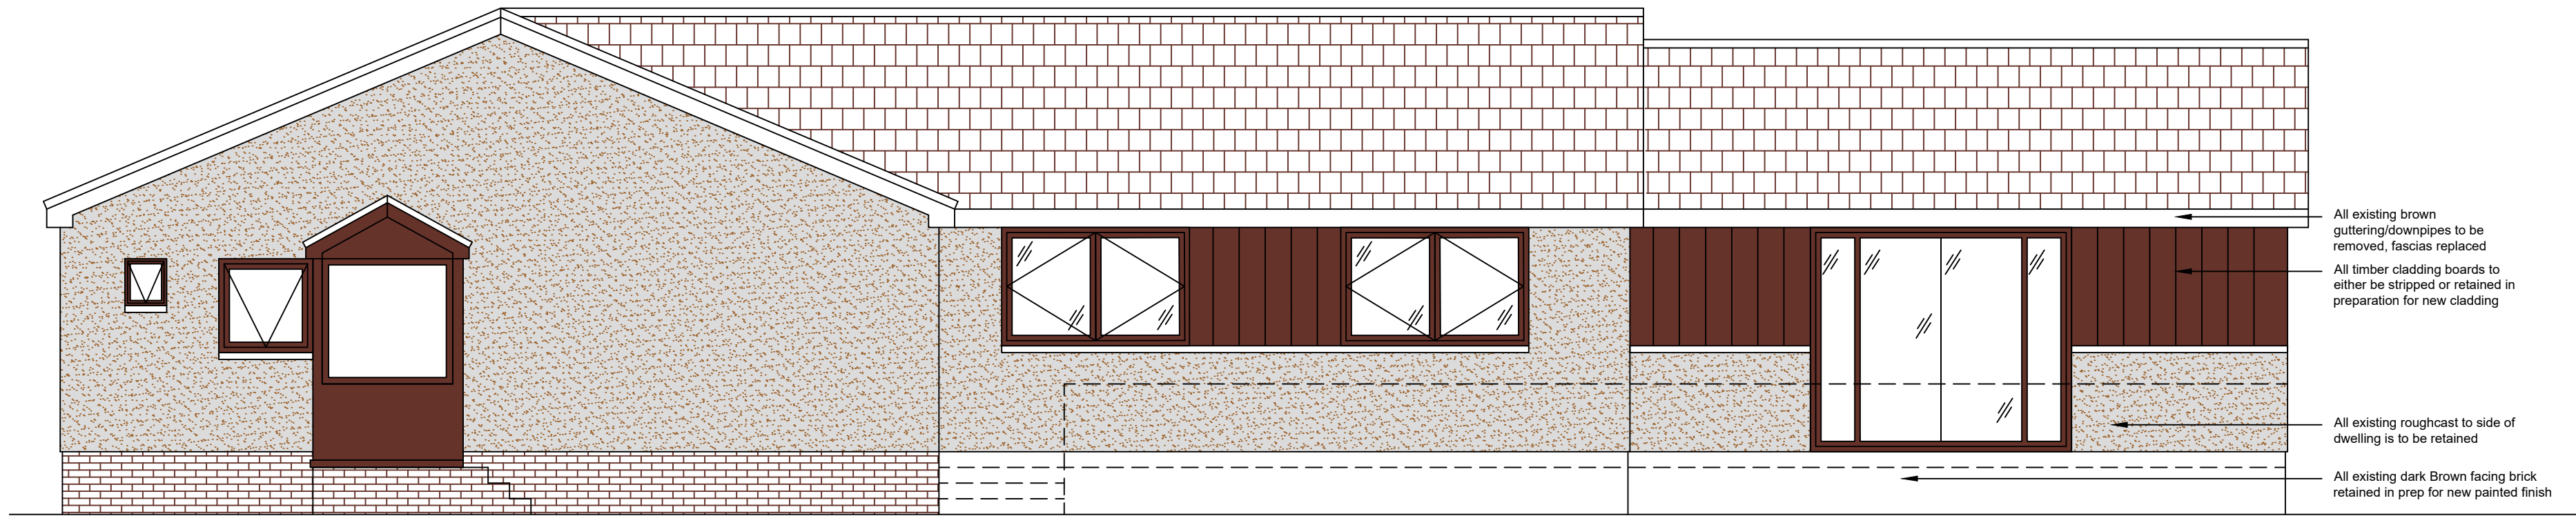

EXISTING FRONT ELEVATION
SCALE 1:50

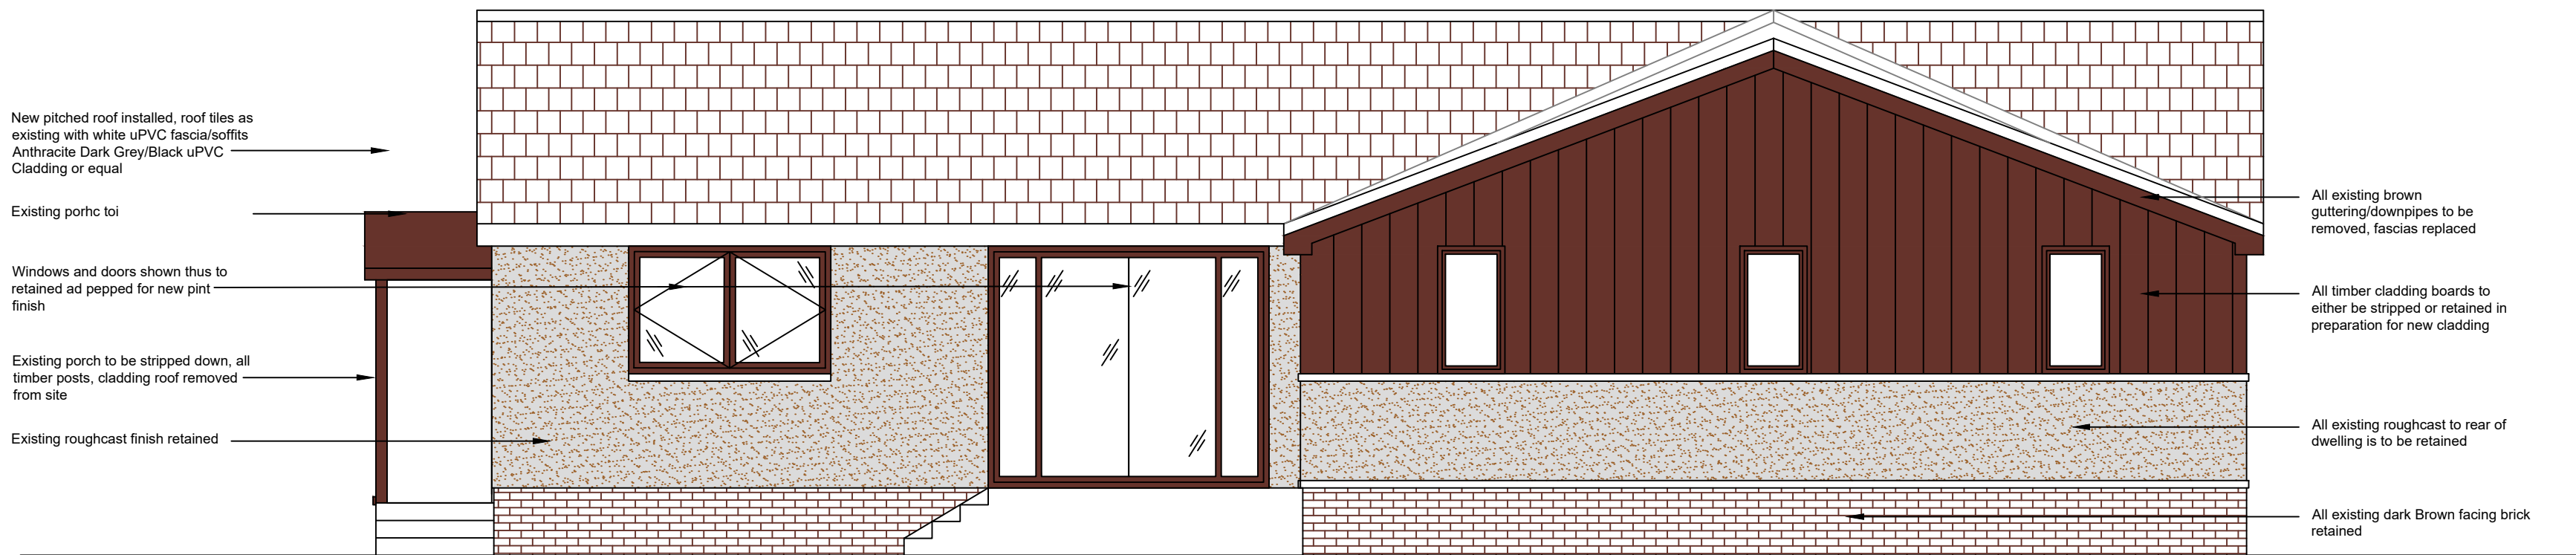

EXISTING REAR ELEVATION
SCALE 1:50

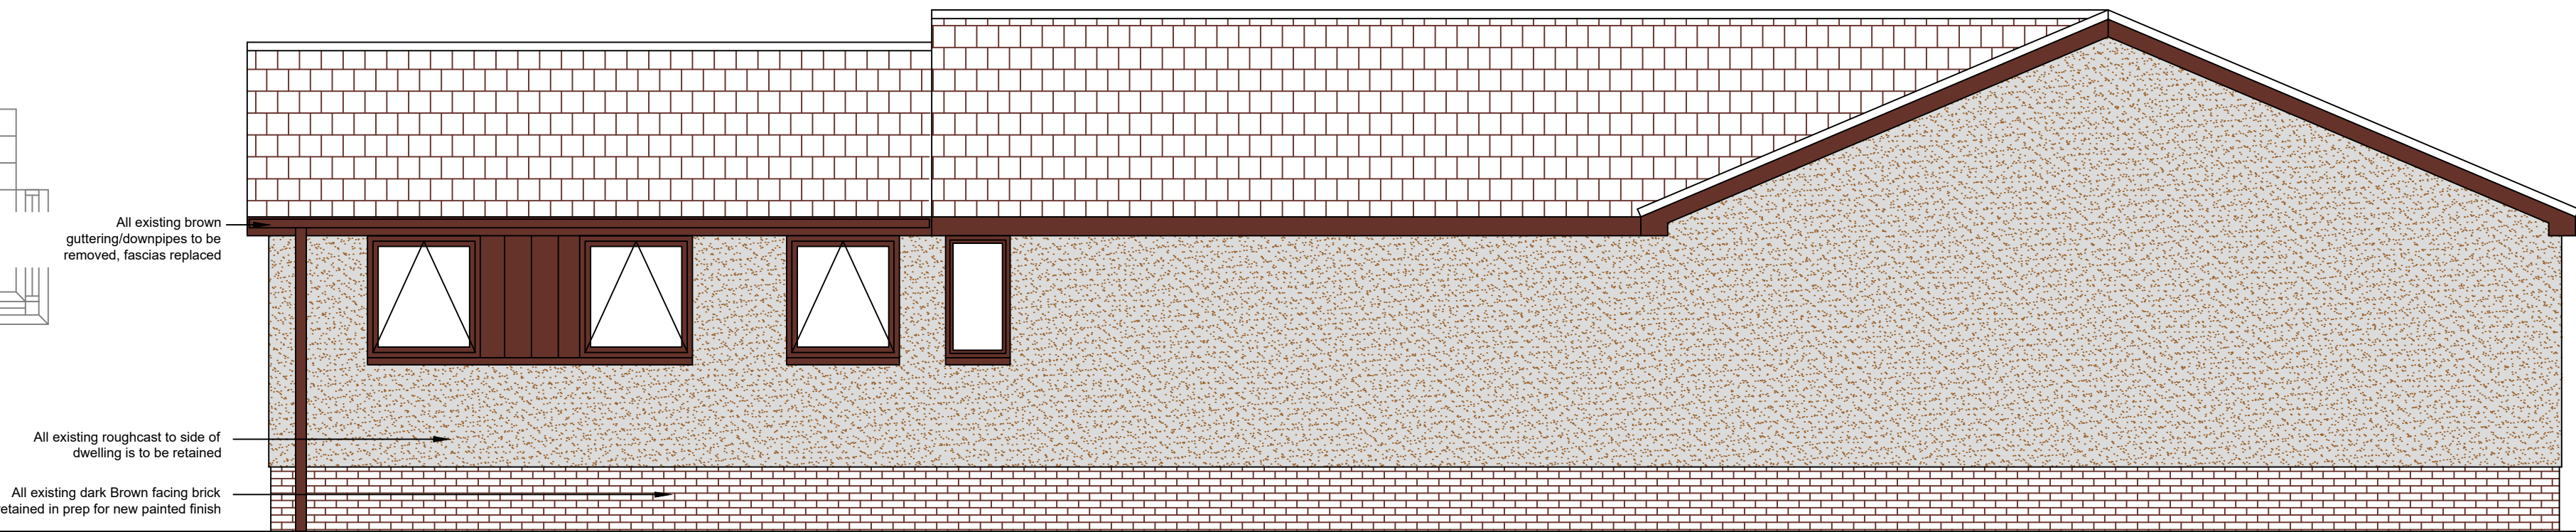

EXISTING SIDE ELEVATION
SCALE 1:50

DO NOT SCALE THIS DRAWING. IF IN DOUBT ASK

NOTES:

1. All dimensions are in millimeters unless stated otherwise.
2. The contractor is to verify all dimensions on site and is responsible for the accurate setting-out.
3. All sizes scaled from this drawing will be approximate and should be checked on site by the user.
4. Contractor must not alter any details on these drawings without the prior consent of the engineer. Failure to do this will result in additional design work and time and correspondingly, additional cost for the client.
5. All care & attention has been taken to ensure all details are correct based on the information available at the time of design. The contractor has a duty of care and if anything on site is found to differ, the Engineer MUST be informed immediately.

REV: C - 08/06/21 - UPDATED TO SUIT PLANNER COMMENTS.
REV: B - 26/03/21 - UPDATED TO SUIT CLIENT COMMENTS.
REV: A - 23/03/21 - UPDATED TO SUIT CLIENT COMMENTS.

SCHEMATIC DESIGN

PROJECT:
EXTERNAL ALTERATIONS TO
DWELLING.

CLIENT:
MR. & MRS. BATTERSBY

LOCATION:
4 DUNLIN CRESCENT
HOUSTON
RENFREWSHIRE
PA6 7JX

SCALE: AS SHOWN

JOB NO: J16

DRAWING NO: 002

DATE: 21/03/21

DRAWN BY: CJF

REVISION: C