

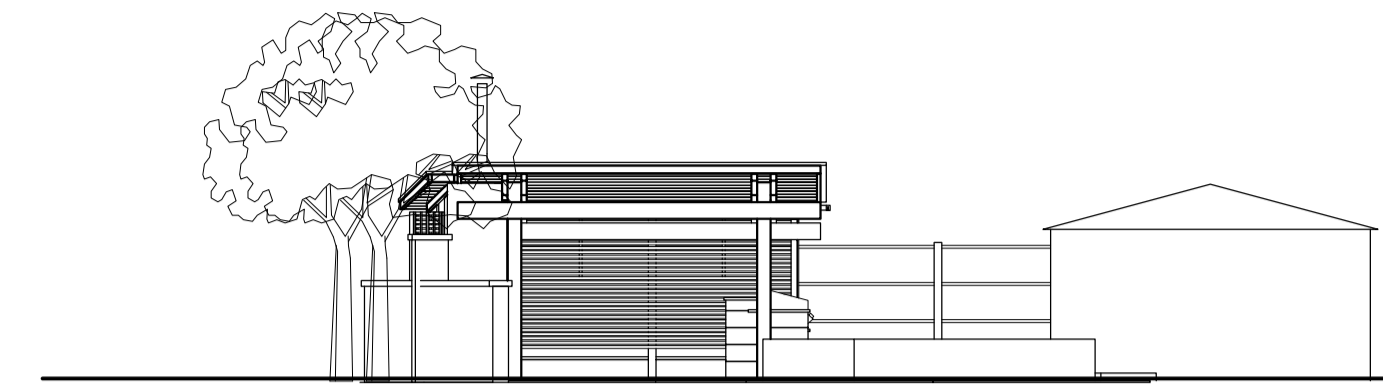



Side Elevation
Scale 1:100

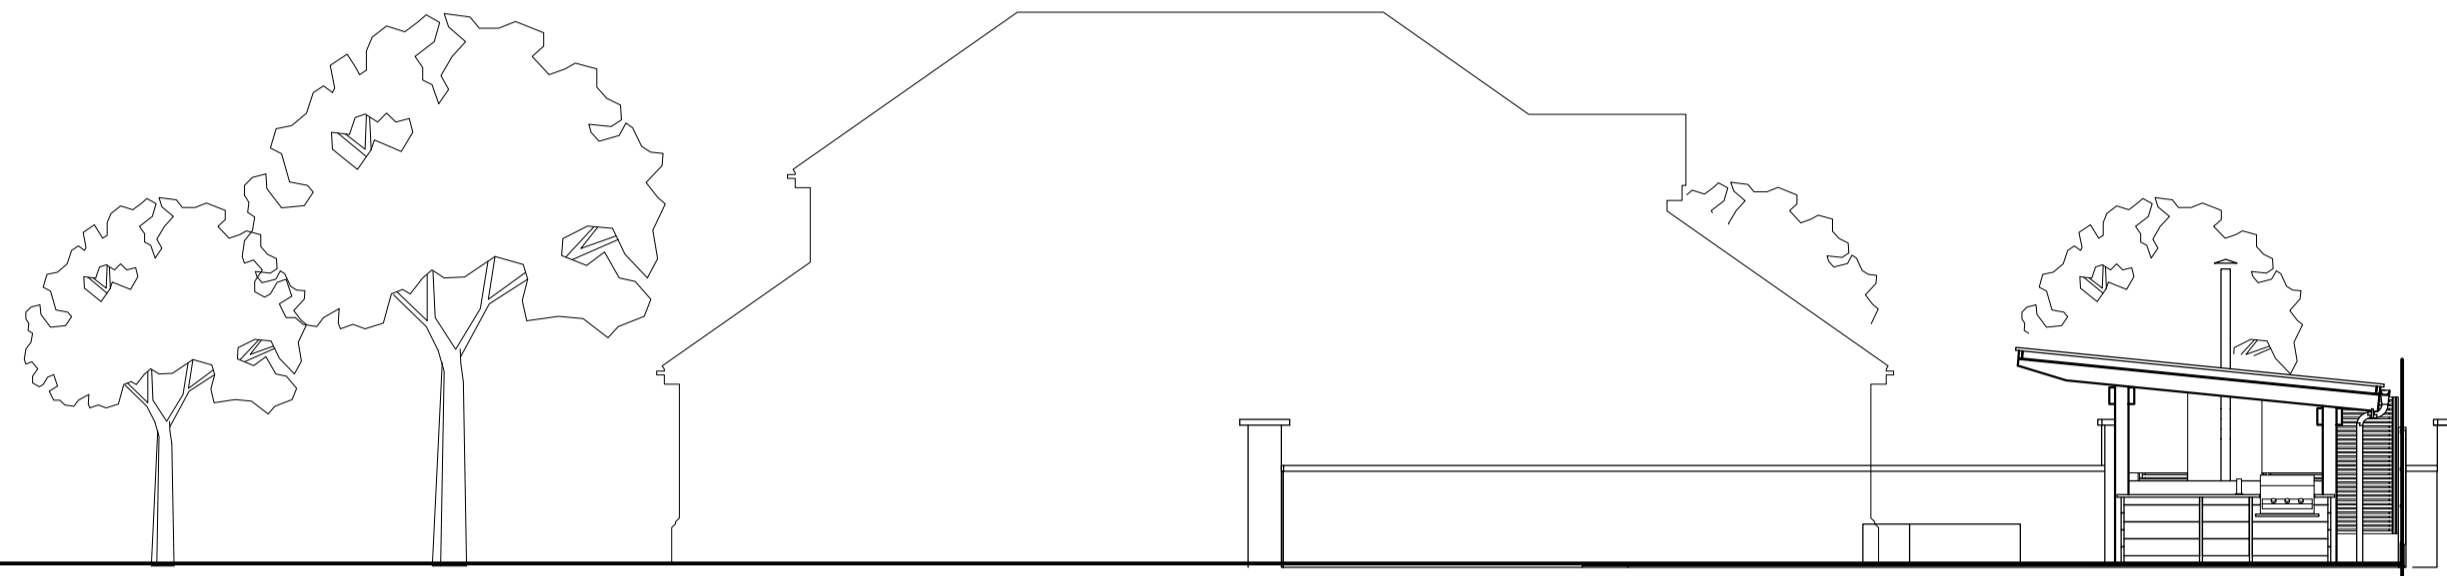


Front Elevation
Scale 1:100

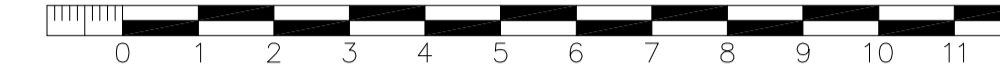


Side Elevation
Scale 1:100

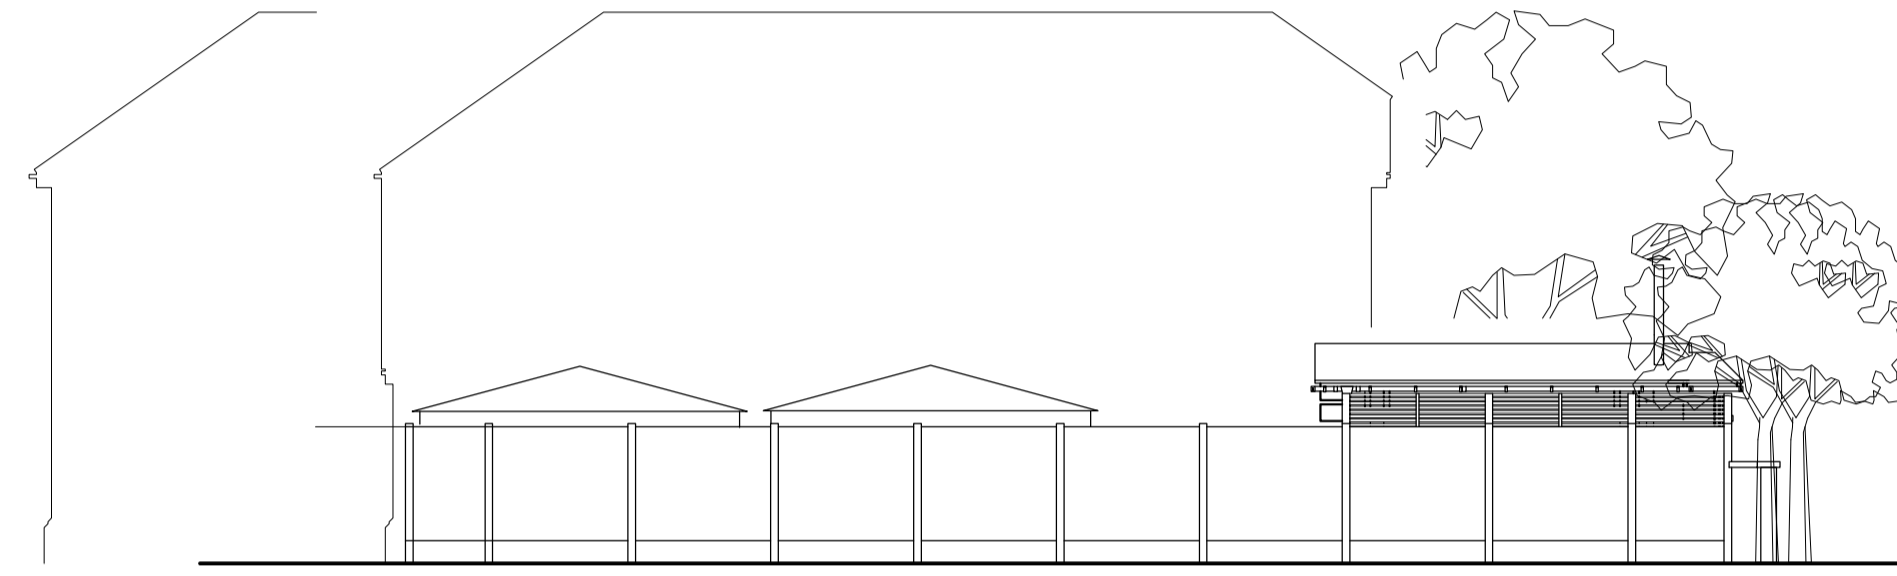

Rear Elevation
Scale 1:100

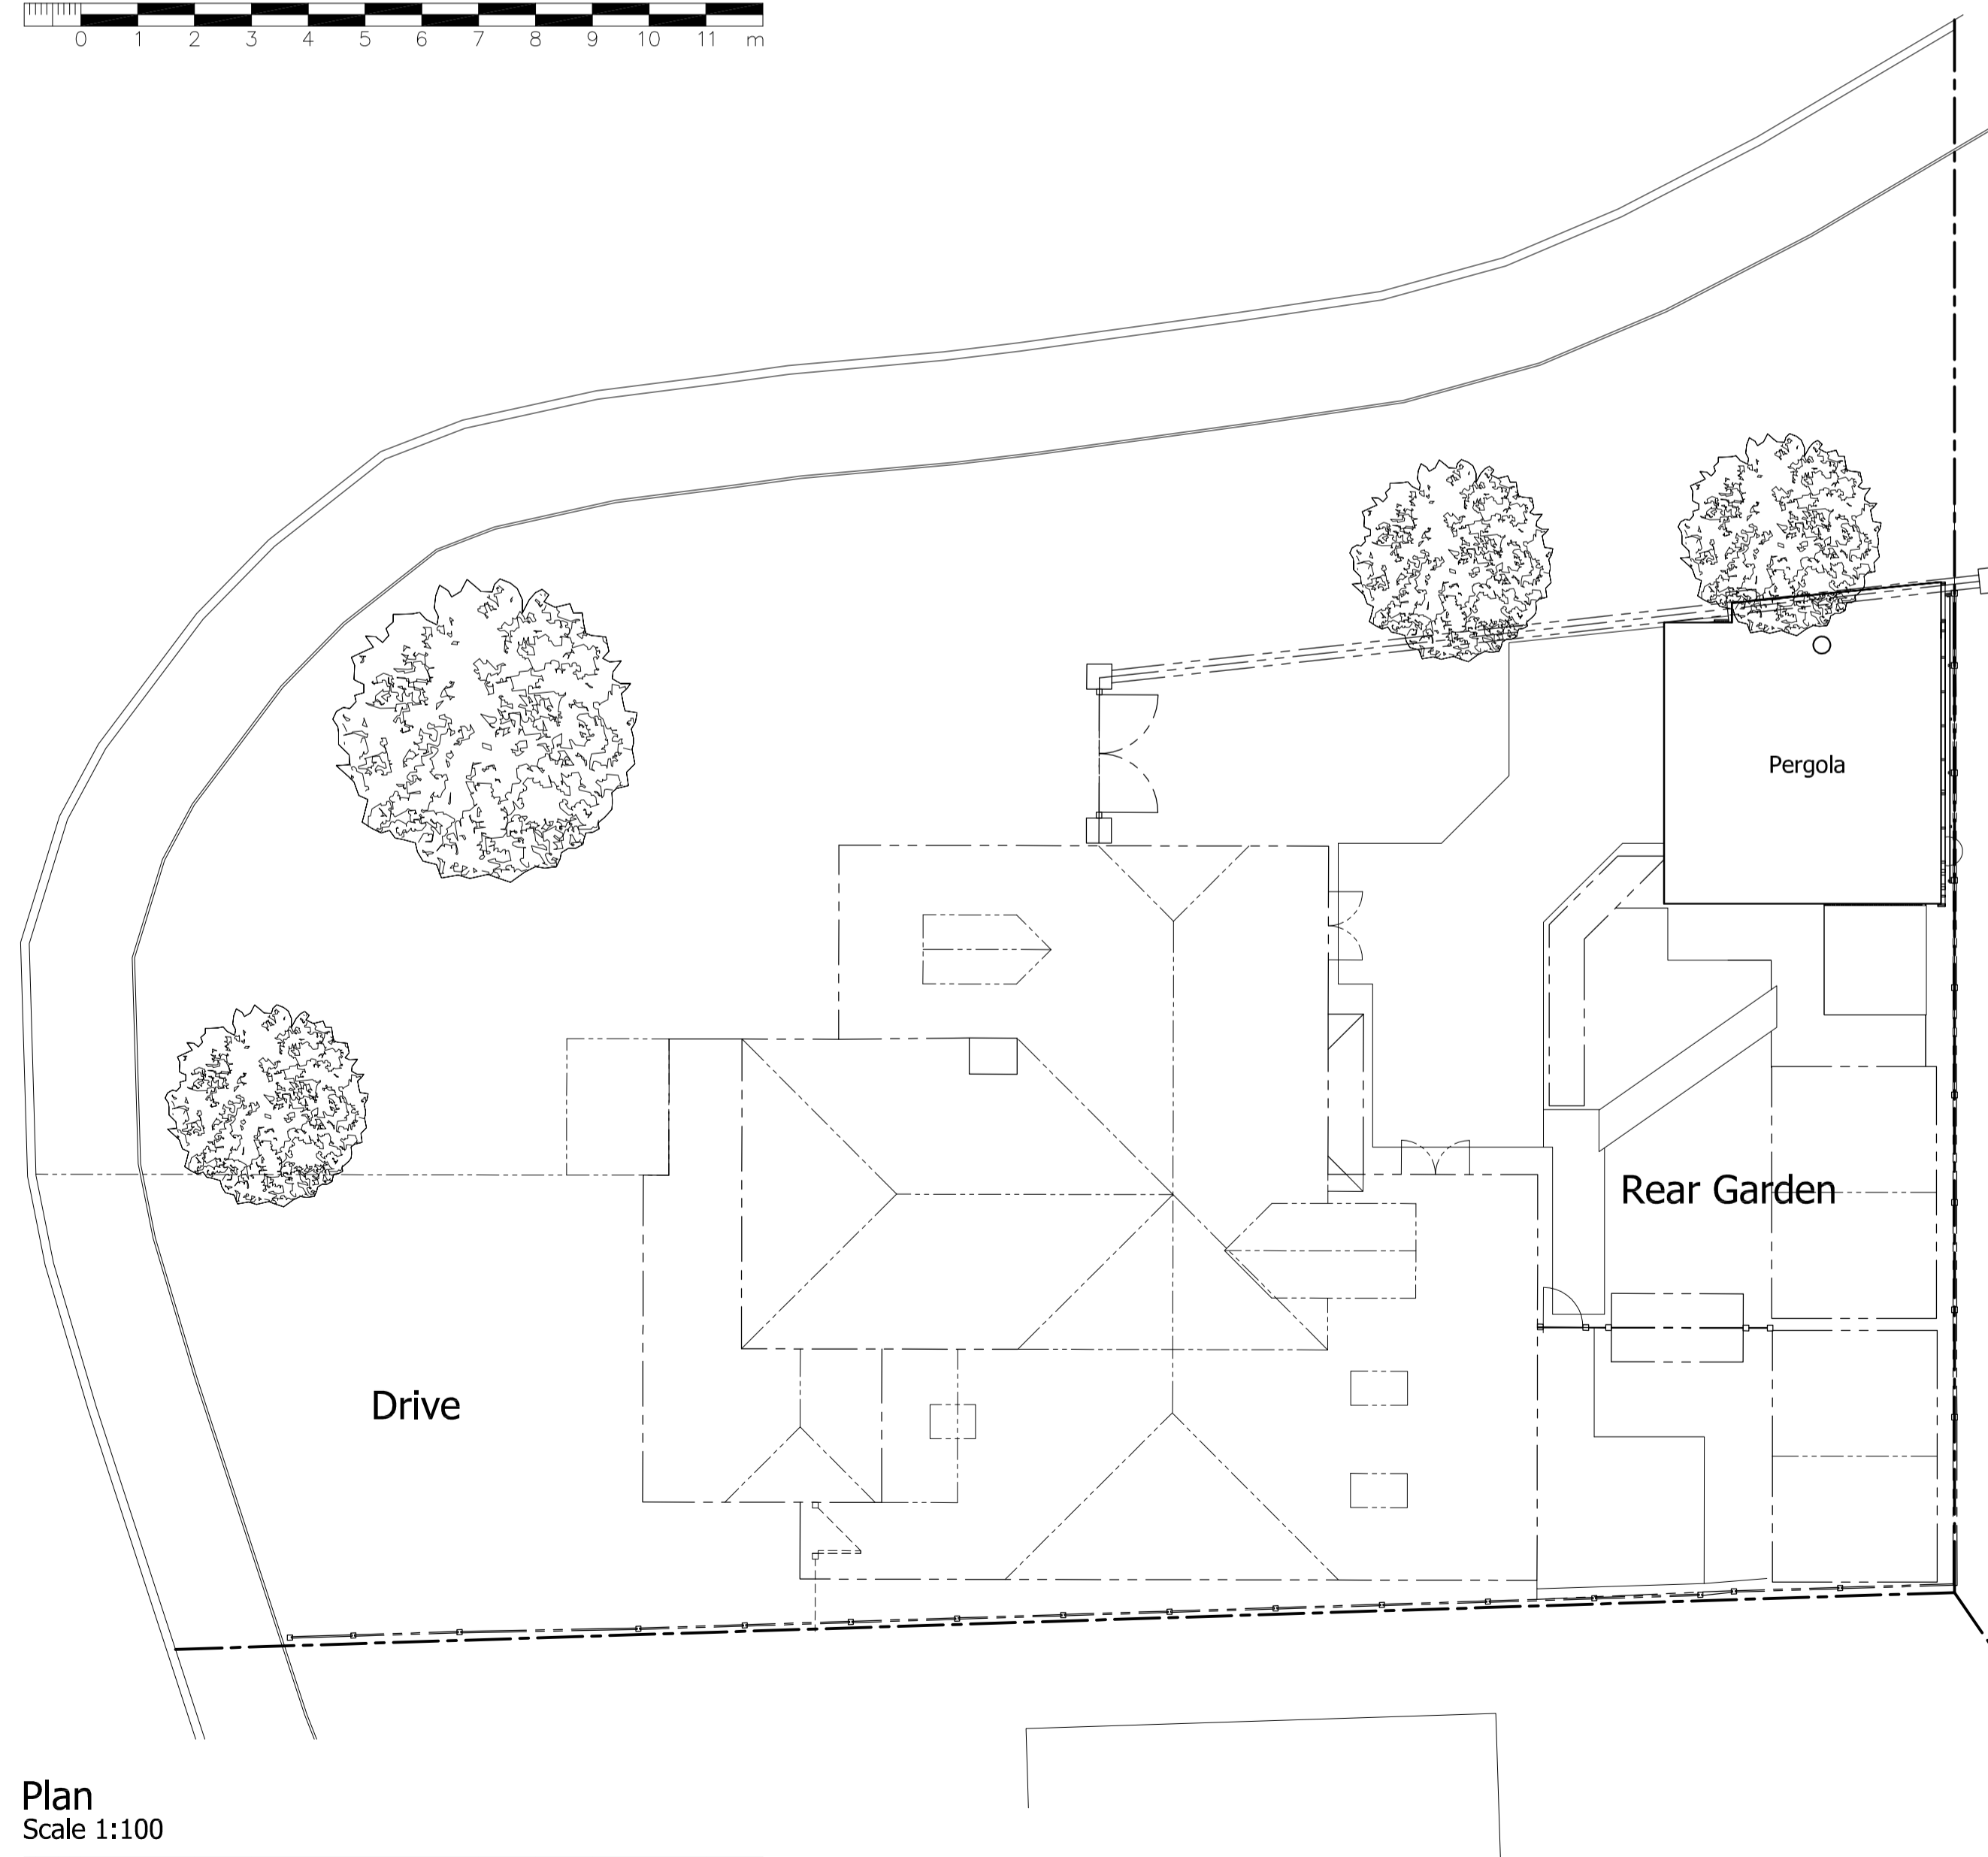


Plan
Scale 1:100

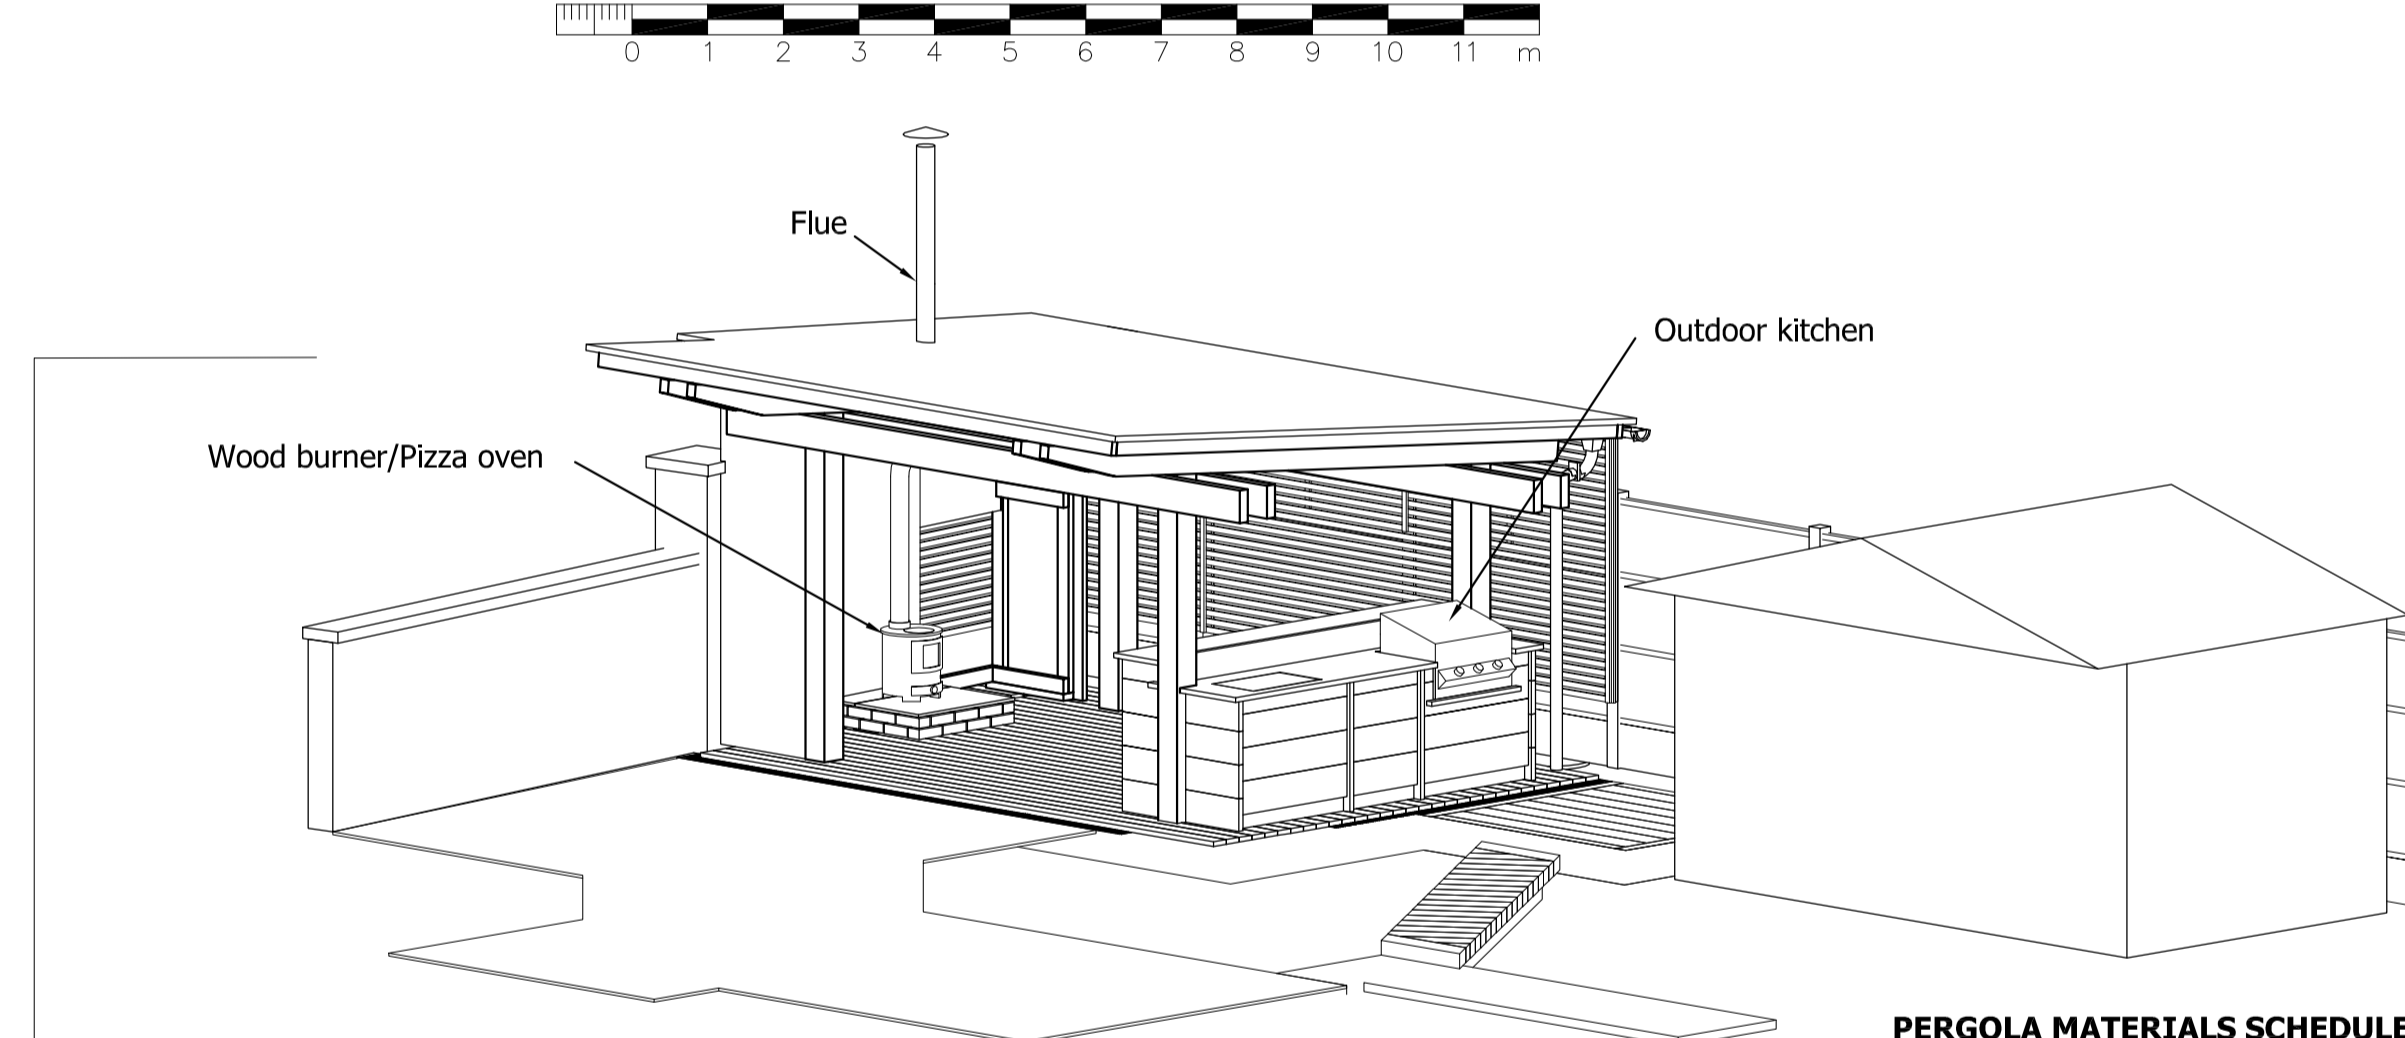


Isometric View

PERGOLA MATERIALS SCHEDULE:


- FRAME:
 - tanalised timber
- ROOF/SIDING:
 - galvanised corrugated metal sheet
- GUTTERING:
 - galvanised metal half round
- FLUE:
 - 5" twin wall stainless steel
- DECKING:
 - 120x24mm green pine treated board

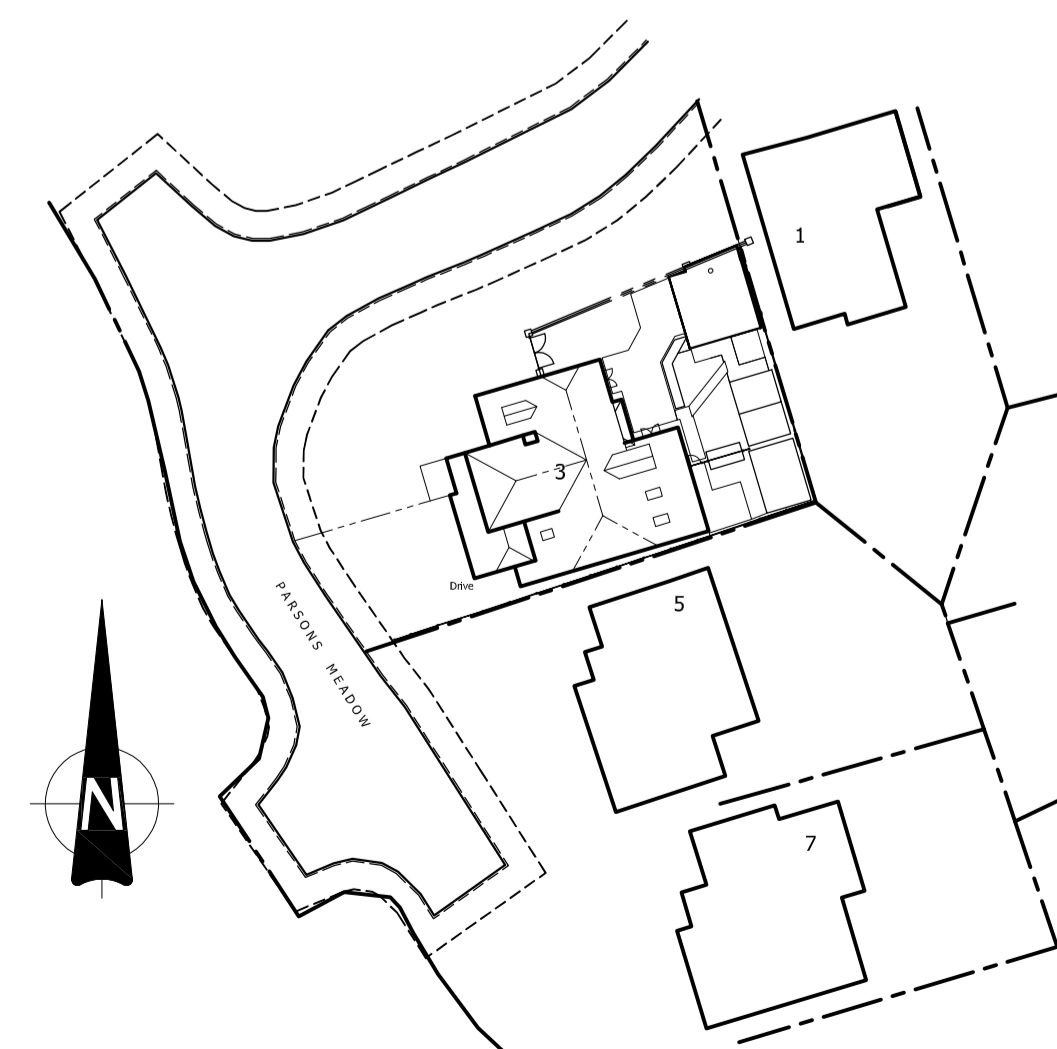

Site Plan
Scale 1:500

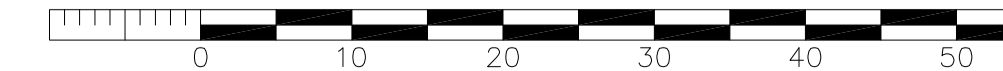

Location Plan
Scale 1:1250

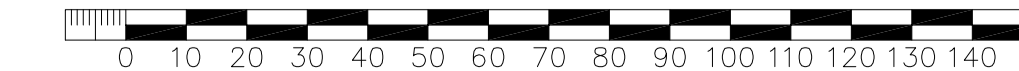

View 1



View 2



View 3



View 4

Revisions : A Issued for planning Jun. 2021

Do Not Scale - (Where drawings are submitted for Planning Permission, drawings can be scaled for planning purposes only). Check all levels and dimensions on site against the drawings and written specification and notify any discrepancies to CLIENT. Contractors, subcontractors and suppliers MUST verify all dimensions on site before commencing any work or making any workshop drawings. Please note that all details are subject to local authority approval unless otherwise stated.

The copyright of this drawing is vested with CLIENT and should not be reproduced, copied or used for any other purpose than that it is intended for without the prior written consent of the CLIENT.

Project
Retain Existing Pergola
3 Parsons Meadows, Colwick, Nottingham

Drawing Title
Planning Drawing

Client
Mr. I. Foster
Drawing No.
0088/2021 A
Date
June 2021

Scale
As shown @ A1