



01 | PROPOSED SOUTH ELEVATION (part)  
SCALE 1:50

PROPOSED SIGNAGE SCHEDULE:

Type & Location	Advert 1 South Elevation 'Self Storage' lettering	Advert 2 South Elevation Logo	Advert 3 South Elevation 'Reception' lettering	Advert 4 East Elevation Logo	Advert 5 East Elevation 'Self Storage, open 24 hours' lettering	Advert 6 West Elevation Logo	Advert 7 Site boundary sign
a) height from ground to base of advert in meters	7.3m	2.2m	3.45m	2.53m	4.52m	2.53m	As existing
b) dimension of advert (HxWxD) in metric	0.76m x 8.60m	4.15m x 2.33m	0.48m x 3.96m	4.15m x 2.33m	1.52m x 8.60m	4.15m x 2.33m	As existing
c) max height of letters of any individual letters and symbols (in metric)	0.76m	0.49m	0.48m	0.49m	0.76m	0.49m	As existing
d) colour of text and background	Text = white Background (wall) = blue	Text = white & red Background (wall) = blue	Text = white Background (wall) = blue	Text = blue & red Background (wall) = white	Text = blue Background (wall) = white	Text = blue & red Background (wall) = white	Text = blue & red Background (wall) = white
e) materials of the signs	Plastic / PPC Alu	Decal / plastic	Plastic / PPC Alu	Decal / plastic	Plastic / PPC Alu	Decal / plastic	Decal / plastic onto existing masonry base and upstand
f) max projection of advert from face of building	100mm	none	100mm	none	100mm	none	none
g) details of method of illumination (internally illuminated/externally illuminated)	backlit using LED strips	uplit from floor mounted light	backlit using LED strips	uplit from wall mounted flood light	backlit using LED strips	no	no
h) illuminance level (cd/sqm)	Indirect only as light reflection from facade	Indirect only as light reflection from facade	Indirect only as light reflection from facade	Indirect only as light reflection from facade	Indirect only as light reflection from facade		
i) illuminance static or intermittent?	static	static	static	static	static		


This drawing is copyright and may not be altered, traced, copied, photographed or used for any purpose other than that for which it is issued without written permission from CSA Architects.

Contractors are not to scale from this drawing, but to check all dimensions on site prior to the commencement of work. Any discrepancies should be reported to the Architect.

All details shown on this drawing are based upon typical site conditions related to the area. No responsibility can be accepted for abnormal conditions unless reported to the Architects, so that design amendments may be considered.

REV	DATE	NOTES	BY
A	21.07.21	Lettering on East Elevation updated	SK
-	01.07.21	Initial Issue	SK

ORIGINAL DRAWING SIZE : A1

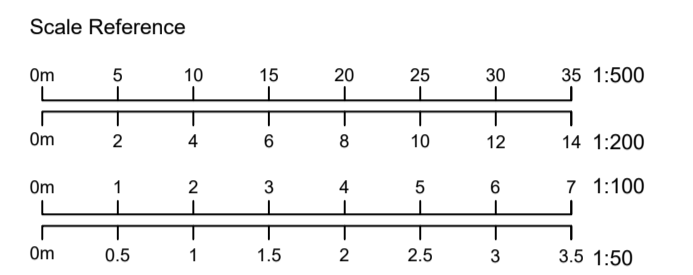

PROPOSED MATERIALS:

Roof

Grey cladding with vertical profile

Walls

- White flat panel cladding system
- Blue flat panel cladding system where indicated
- Red feature trims where indicated
- Rendered masonry, painted grey
- Curtain wall glazing
- Signage, as indicated


Doors / Windows

- Grey roller shutter doors
- Existing white uPVC
- Grey metal fire exit doors

Existing Storage Building left unaltered



02 | PROPOSED WEST ELEVATION (part)  
SCALE 1:50

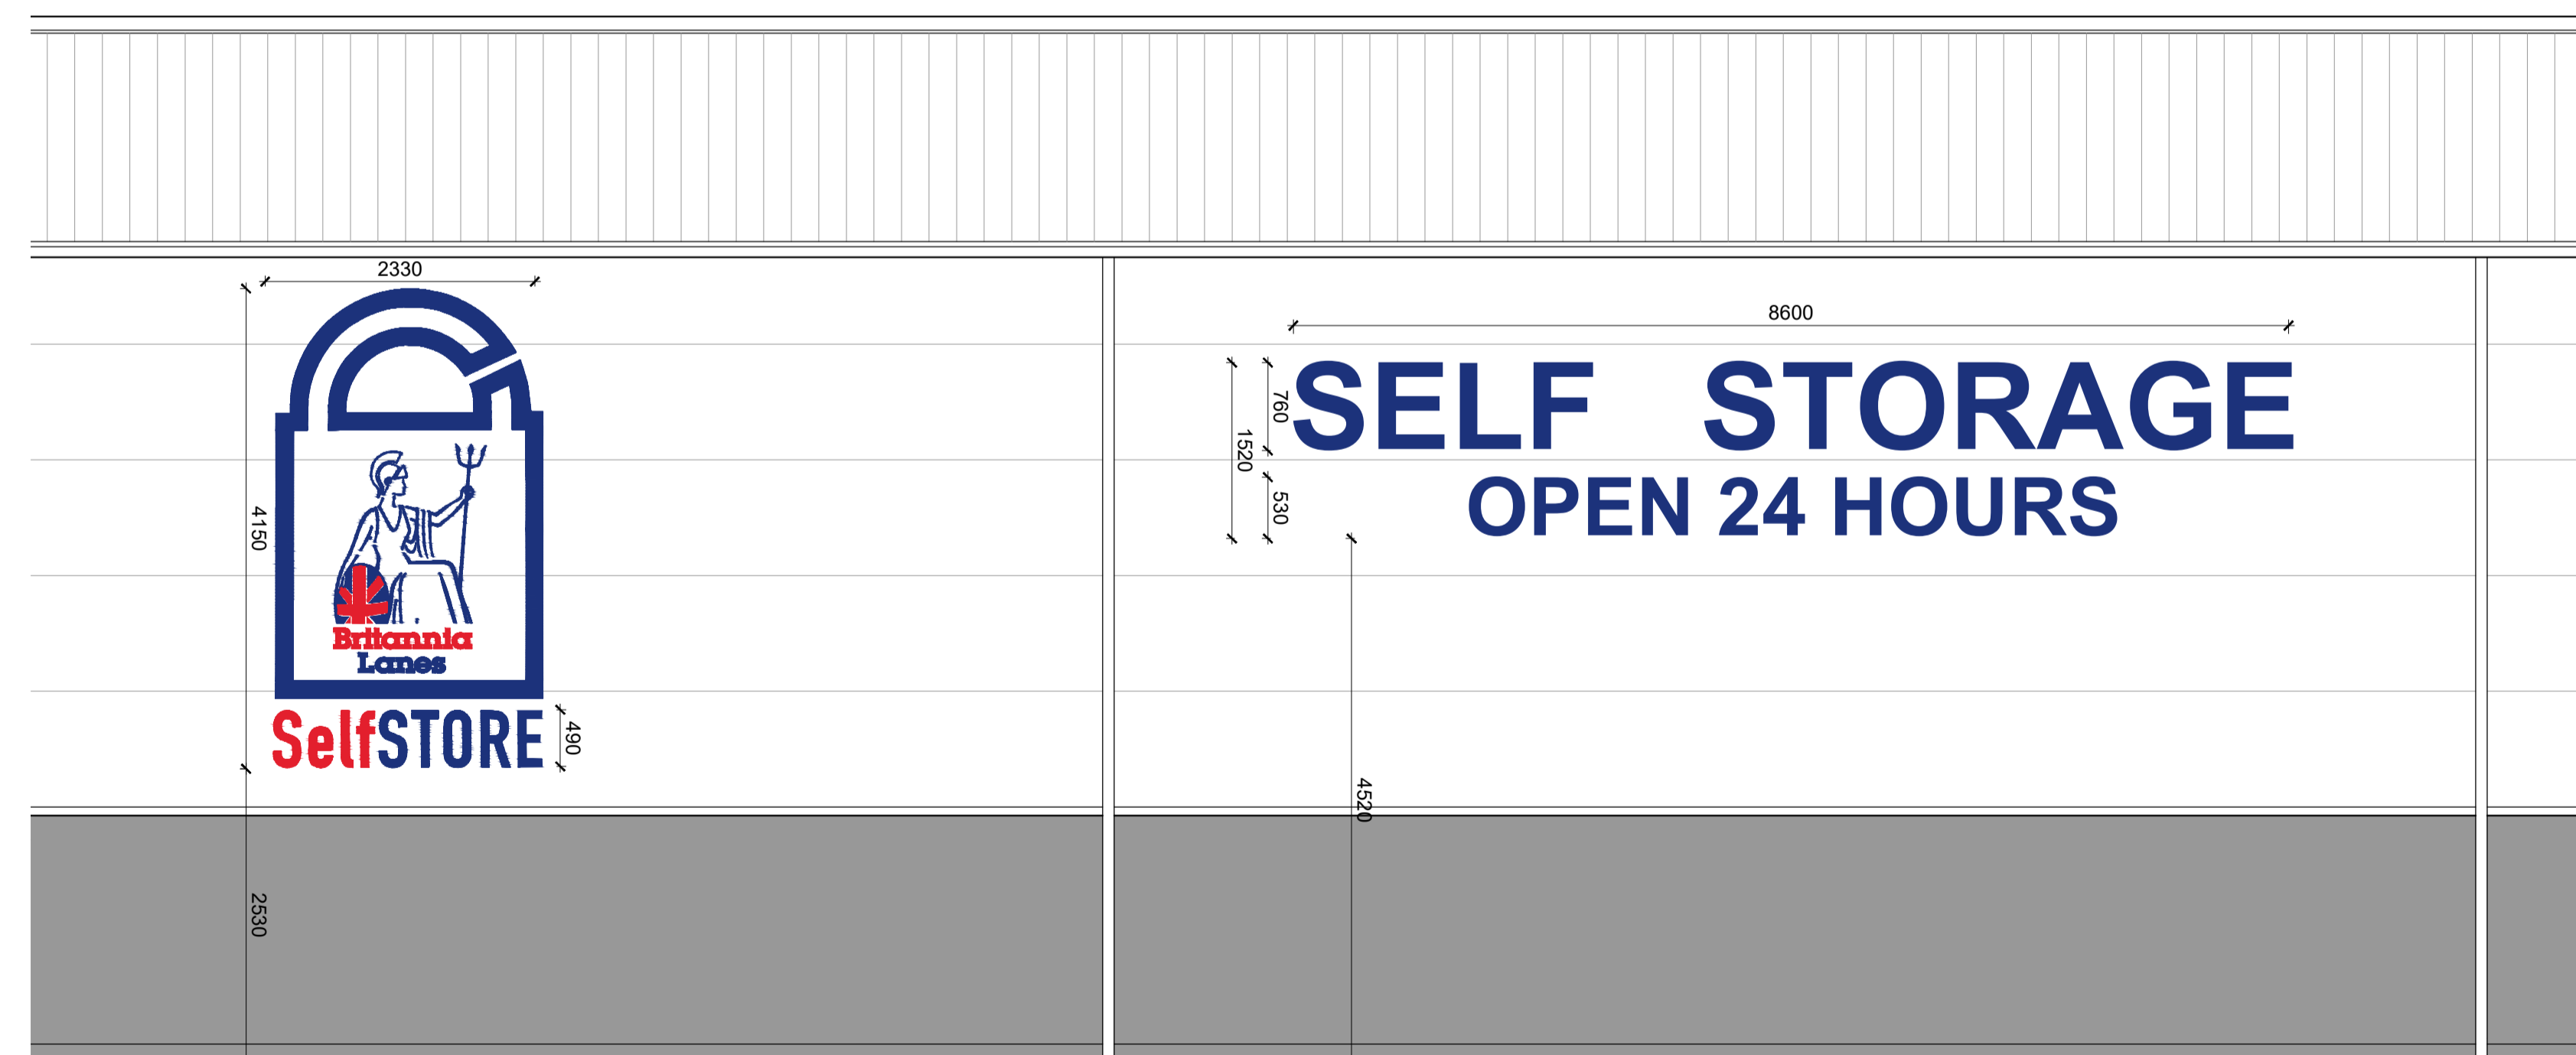

wall mounted  
uplighter for sign

backlit  
lettering

02 | PROPOSED EAST ELEVATION (part)  
SCALE 1:50

CSA Architects  
RIBA Chartered Practice

Tel 01872 265 310  
www.csa-architects.co.uk  
info@csa-architects.co.uk  
St Piran House, Heron Way  
Newham, Truro, Cornwall, TR1 2XN



Client  
BRITANNIA LANES

Job Description / Location  
Alterations to Elevations of Extg Building to include External Lighting and Use of the Building in the B8 Use Class at UNIT 7, BICKLAND INDUSTRIAL PARK FALMOUTH, TR11 4TA

Drawing Title  
PROPOSED  
ELEVATION DETAILS  
SIGNAGE

Date	Scale	Drawn By	Checked
July '21	1:50	SK	
Job No.	Drawing No.	Revision	
3381	022	A	

PLANNING