


## **Existing Front Elevation** Existing Side Elevation (View from No.49) **Existing Rear Elevation** Existing Side Elevation (View from No.45) UPVC windows Concrete roof tiles Concrete roof tiles Painted pebble dashed finish — Existing Side Elevation (View from No.49) Existing Side Elevation (View from No.45) **Existing Front Elevation Existing Rear Elevation** Cement render / finish Block up door Existing Ground Floor Plan Existing Roof Plan

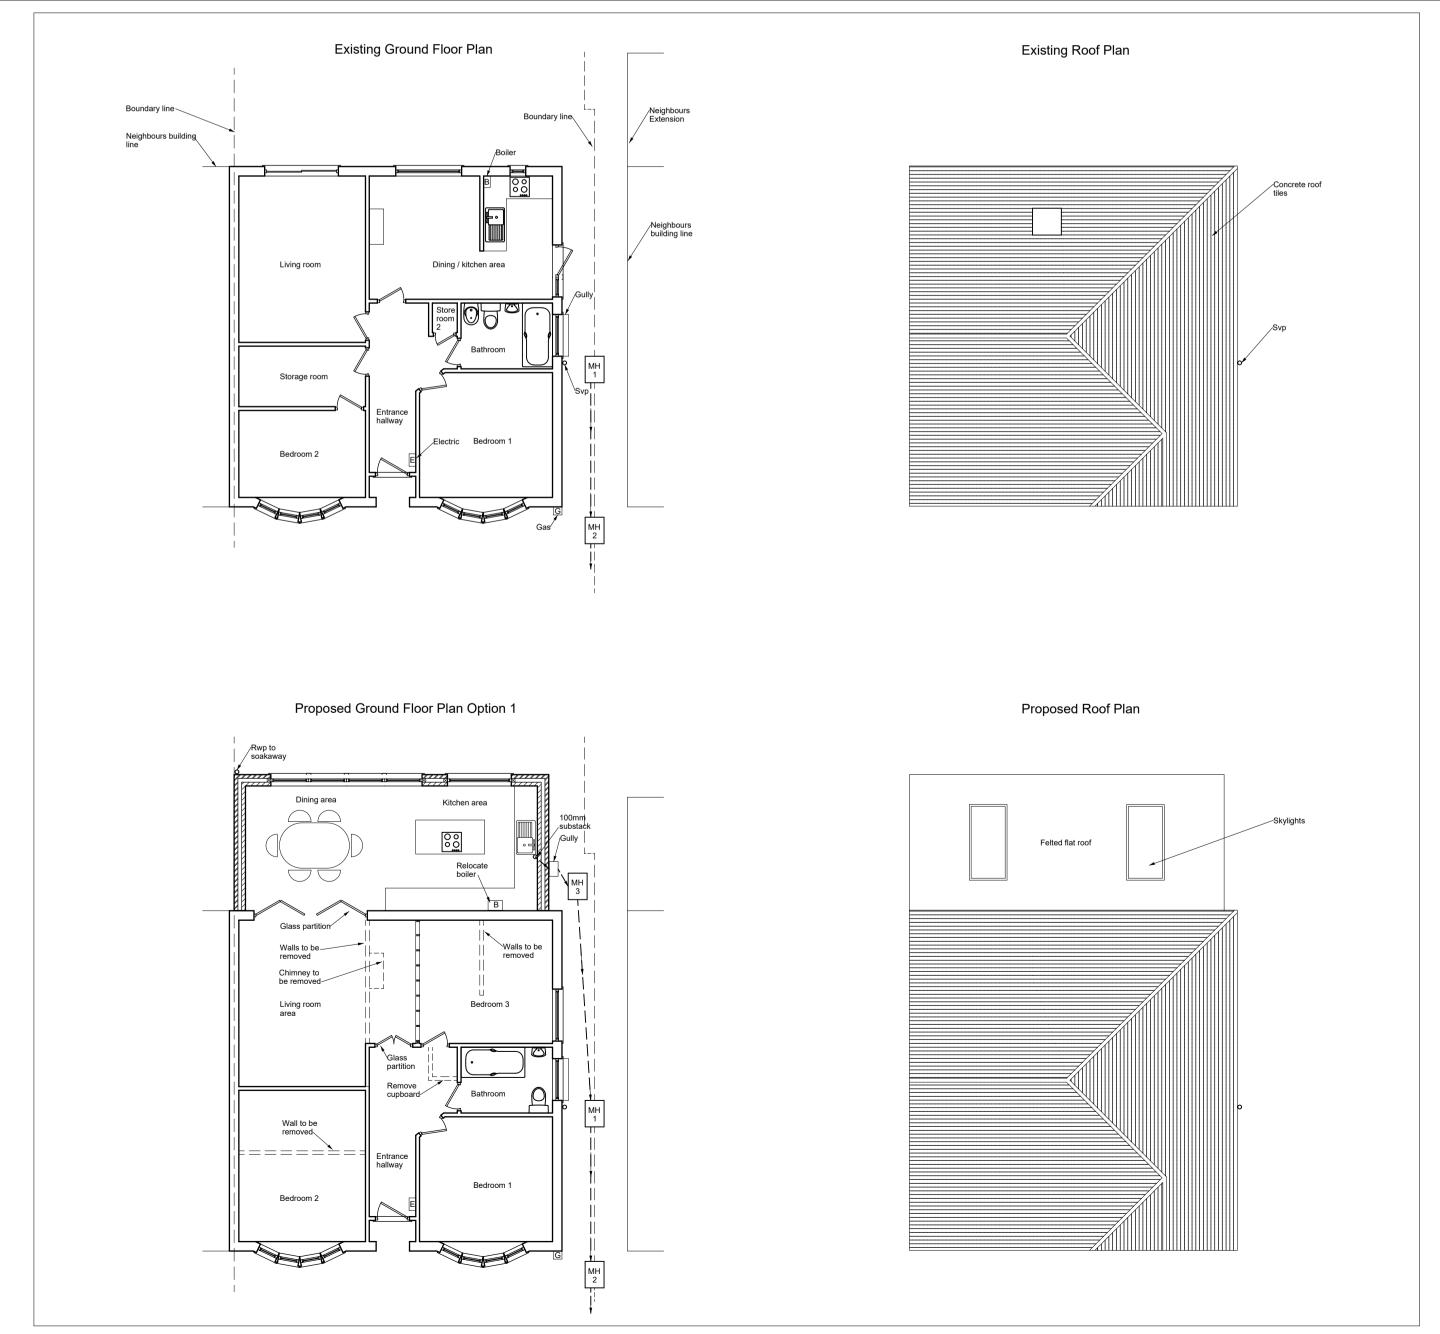

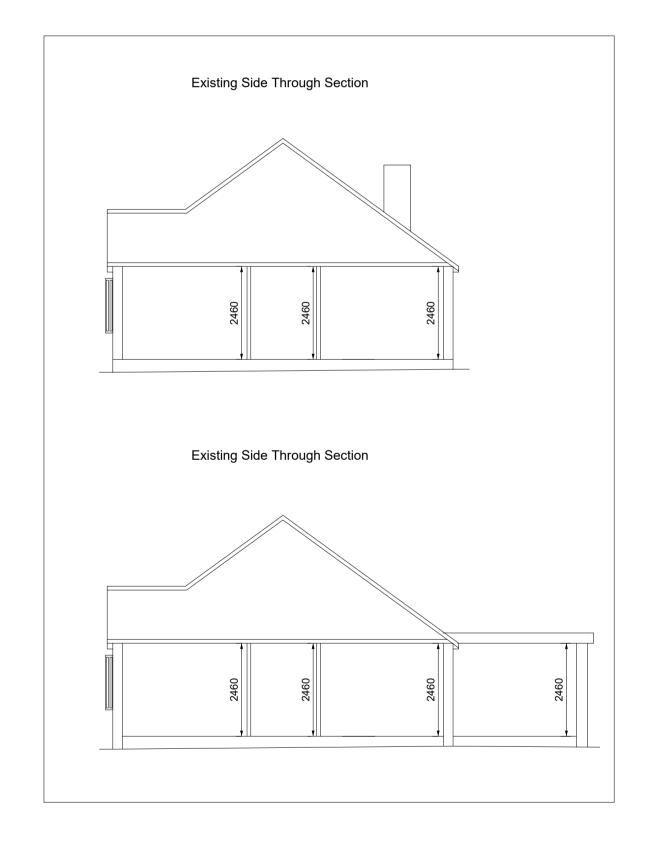

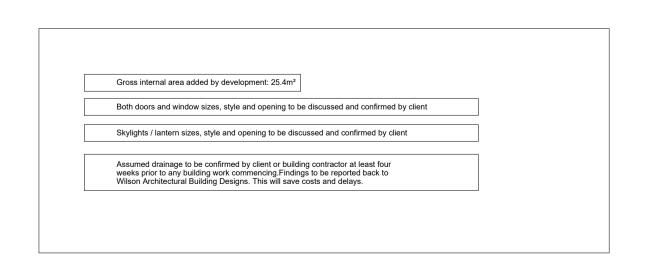

- Minimum clearance between new foundations and below ground pipe work (160 mm or less), must be no less that 100 mm.

- New foundations are to be lower than the invert level of all below-ground pipe work.

0 1.0m 2.0m 3.0m 4.0m 5.0m 6.0m 7.0m 8.0m Scale bar 1:100

Drawings produced are for building regulation approval only and may not cover all elements required to ensure project completion.

All dimensions to be checked on site by contractor.

Before any type of construction work takes place, client or contractor must confirm with

- New manholes connected to a public sewer are to be built in brick work.

- New below-ground pipe work connected to a public sewer are to be clay.

- New pipe work whether it be clay or plastic, needs to be surrounded in at least 150 mm of pea shingle.

Before any type of construction work takes place, client or contractor must confirm with building control elements of works that could require building control conformation checks.

Any discrepancies with drawings/specifications to be raised and clarified with Wilson Architectural Building Designs Ltd.

All works and the design of the conformation of the conformat

All workmanship and materials to comply with current British/European standards, codes of practice & manufacturers instructions.

Do not scale from drawing.

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Date: Scale: 1:100

Project: 47 Woodlands A

DRAINAGE INFORMATION -

47 Woodlands Avenue Sidcup Kent DA15 8HB

Single Storey Rear Extension Including Internal Alterations

Drawing No: 19-21-BEX



S1 02

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