



10 M

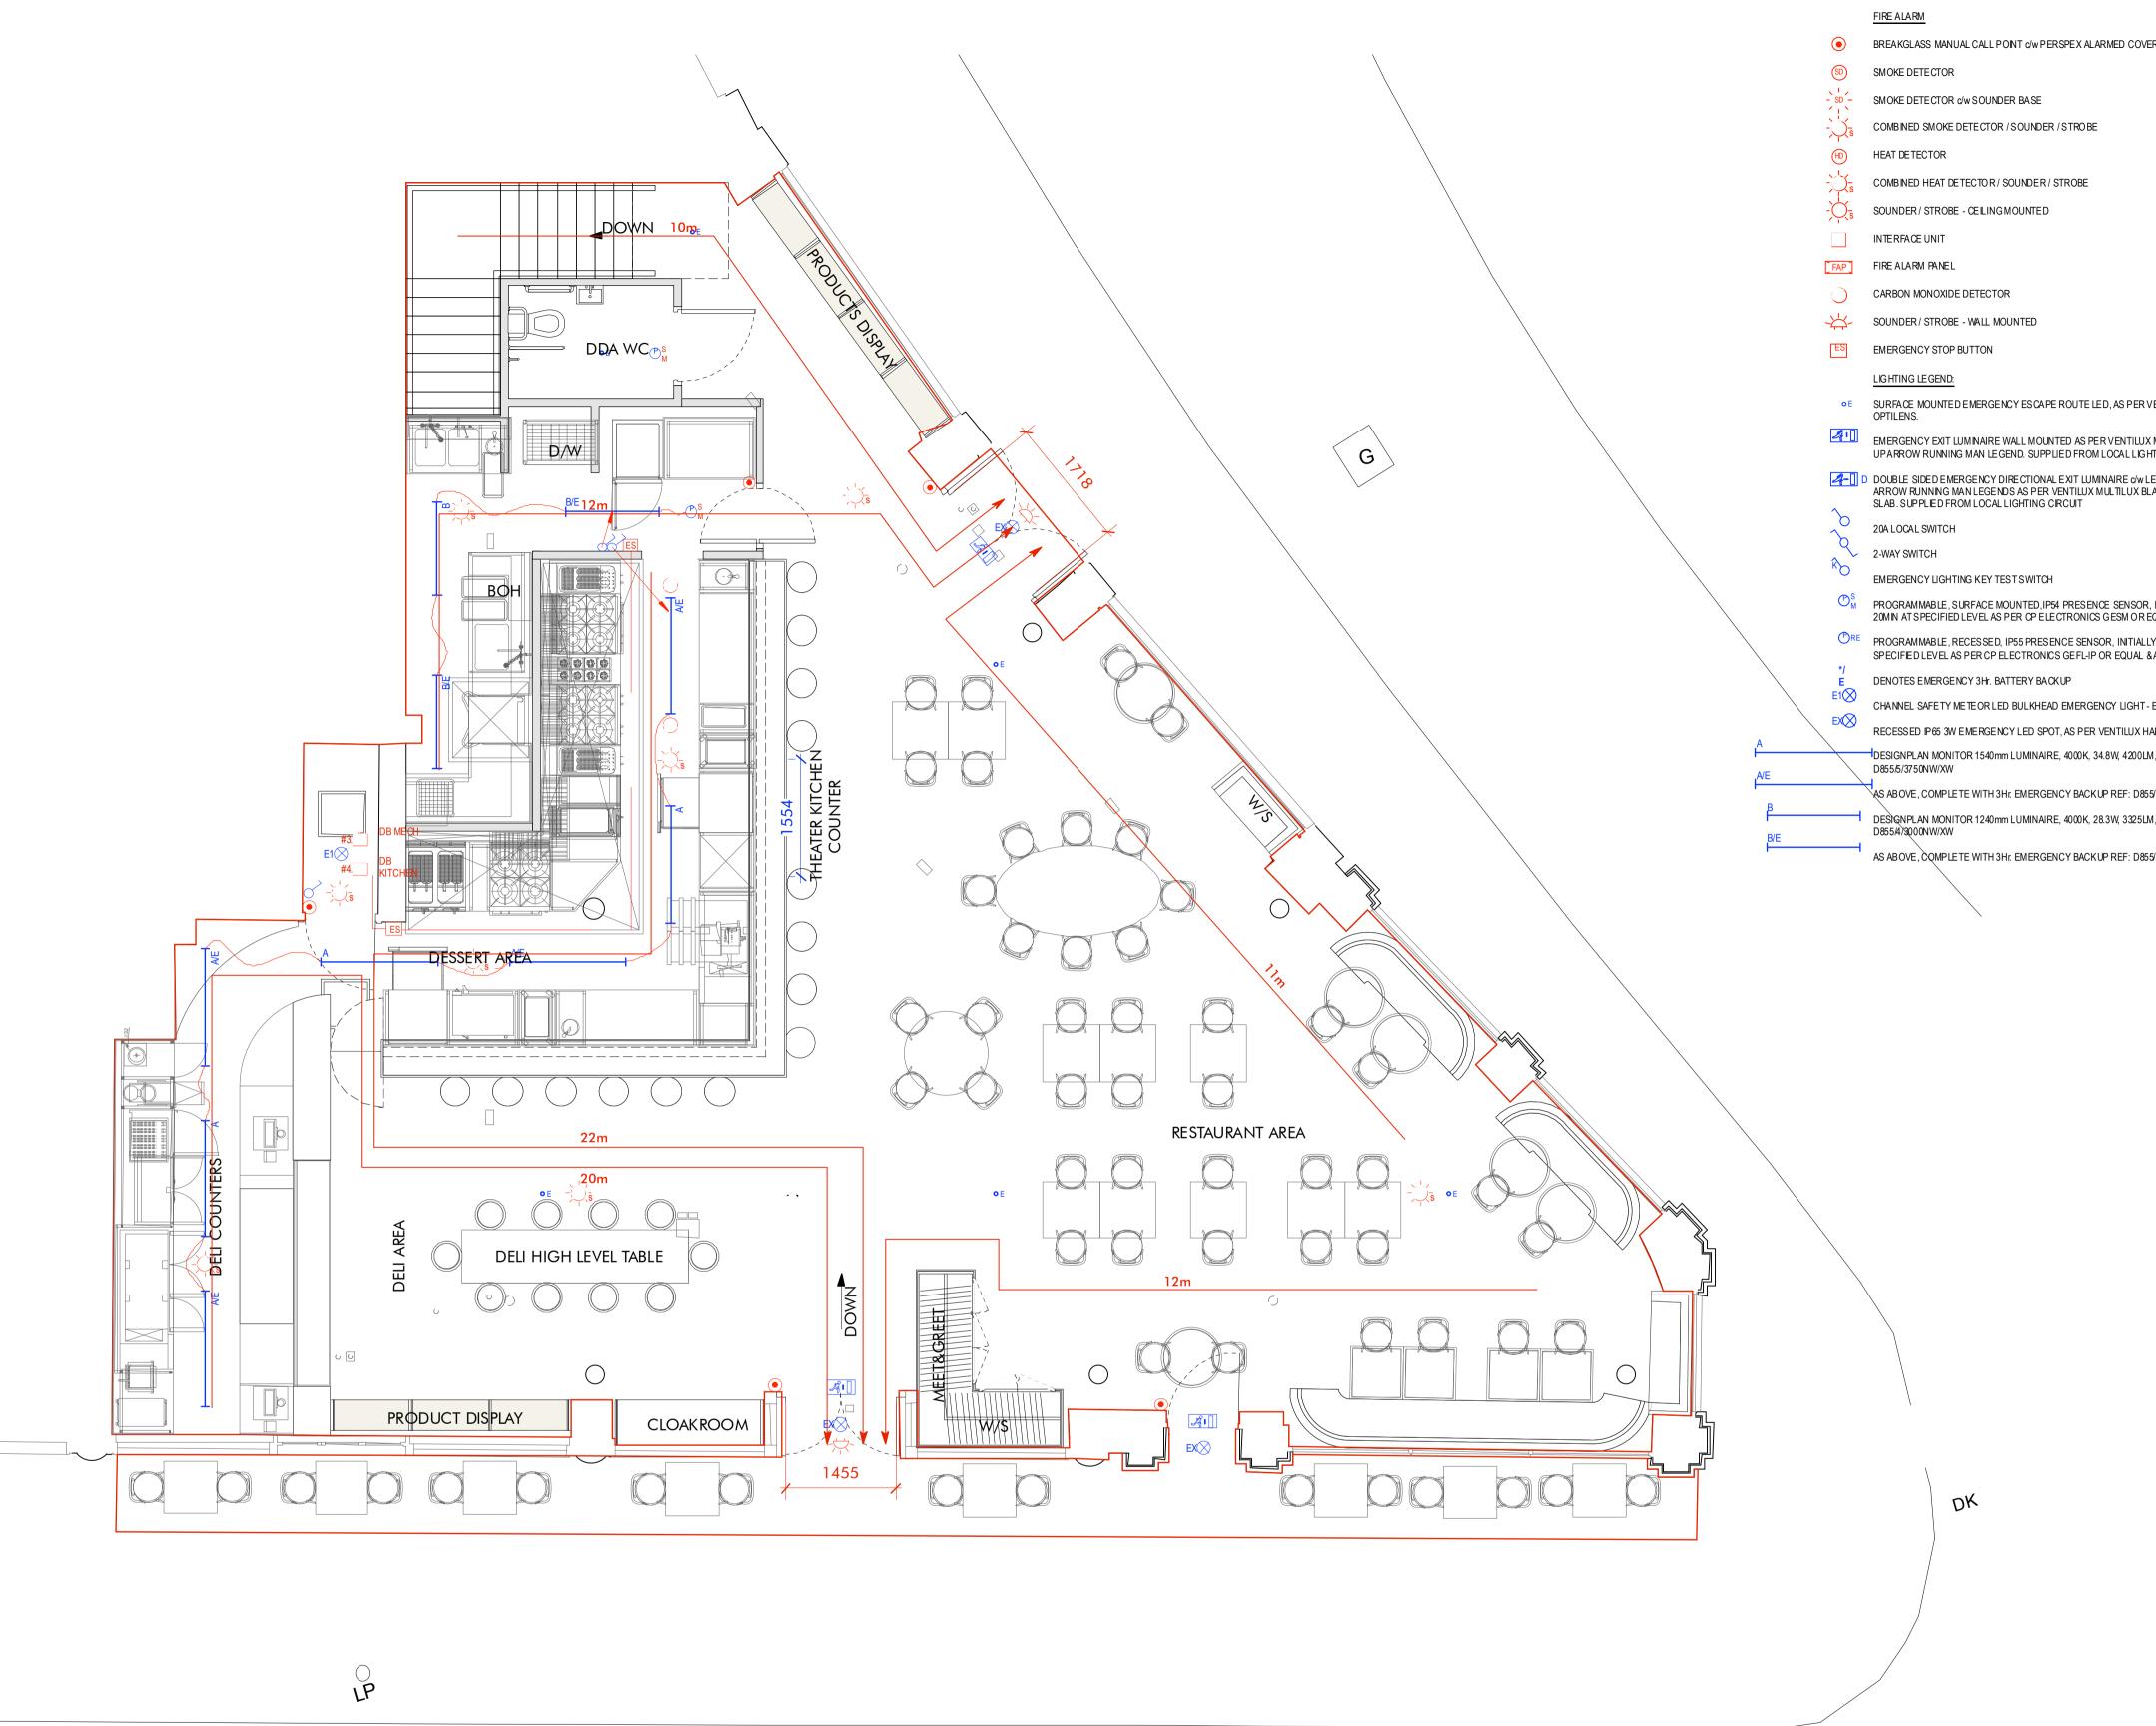



	Specifications	Notes	
OVER	EMERGENCY LIGHTING SPECIFIC NOTES: ALL ESCAPE LIGHTING TO COMPLY WITH BS5266-1:2016 & BS EN 1838:2013. ALL EXIT SIGNS TO COMPLY WITH B S5499-4:2013 & BS ISO 3864-1:2011.	AREA OF LICENSABLE ACTIVITIES	
	EMERGENCY LIGHTING TO BE INSTALLED IN: - APROTECTED ZONE / AN UNPROTECTED ZONE AS OVE RALL BUILDING IS GREATER THAN 18M IN HEIG HT		
	- ALL ROOMS WITH AN OCCUPANCY CAPACITY OF MORE THAN 60, OR IN THE CASE OF AN INNER ROOM, THE COMBINED OCCUPANCY CAPACITY OF THE INNER ROOM PLUS THE ADJOINING ROOM (AND ANY PROTECTED ZONE OR UNPROTECTED ZONE SERVING THESE ROOMS) IS MORE THAN 60		
	- APROTECTED ZONE OR UNPROTECTED ZONE SERVING BASEMENT STOREY		
	- APLACE OF SPECIAL FIRE RISK (OTHER THAN ONE REQUIRING ACCESS ONLY FOR THE PURPOSES OF MAINTENANCE) AND ANY PROTECTED ZONE OR UNPROTECTED ZONE SERVING IT		
	 OPEN AREAS WITH AN ESCAPE ROUTE PASSING THROUGH THEM AREAS LARGER THAN 60M² 		
ER VENTILUX	ALL EMERGENCY LIGHTING AND EXIT LIGHTS TO BE CABLED FROM NEAREST LIGHTING CIRCUIT WHEN NO SPECIFIED CIRCUIT SHOWN.		
LUX MULTILUX BOX c/w .IG HTING CIRCUIT /w LEFT & RIGHT	FIRE ALARM SPECIFIC NOTES: FIRE ALARM SYSTEM TO COMPLY WITH BS5839 PART 1:2017		
X BLADE FIXED TO	ALL FIRE ALARM CABLES SHALL BE PH120 ENHANCED GRADE CABLE; FIRE RETARDANT, SELF EXTINGUISHING.		
	WIRING SYSTEMS TO BE SUPPORTED BY FIRE-RESISTANT FIXINGS AND FASTENINGS.		
OR, INITIALLY SETTO OR EQUAL & APPROVED	CABLE TO BE ON / IN CONTAINMENT THROUGHOUT ITS ROUTE, UNLESS OTHERWISE INDICATED. ALL EQUIPMENT AND ACCESSORIES TO BE RECESSED IN WALLS IE. A FLUSH INSTALLATION. UNDER NO CIRCUMSTANCES WILL SURFACE		
ALLY SETTO 20MIN AT AL & APPROVED	WIRING BE ACCEPTED. AT EACH DE TE CTOR, CABLE TO BE ADEQUATELY SUPPORTED BETWEEN SOFFIT AND CEILING LEVEL. CABLE TO TERMINATE INTO A BESA BOX AT		
HT - E/ME/M3/LED/IP65	CEILING LEVEL FOR WALL MOUNTED DEVICES CABLE TO TERMINATE ABOVE CEILING INTO 20mm GALVANISED CONDUIT RECESSED INTO BUILDING FABRIC.		
X HALO IP65 DOLM, REF:	• FIRE ALARM SYSTEM TO COVER ALL AREAS TO L1 CATEGORY.		
D855/5/3750NW/XW/EM3 25LM, REF:	FIRE ALARM INTERFACES		
D855/4/3000NW/XW/EM3	1. GAS SOLENOID VALVE 2. MUSIC SY STEM		
		Revisions DD 1 21/04/21	
		DD 2 28/04/21 Ramp detail added DD 3 15/06/21 Issue for Licensing	
		DD 4 16/06/21 Revised notes	
		Project	
		Lina Stores - 68 Wigmore W1U 2SD	
		Client LS-WRF	
		Drawing Title Proposed Plan Ground Floor Licensing	
		Scale @ A 1 1:50 @ A 1	
		Drawning number 013-802	
		Revision DD4	
		Drawn by GP	
		Do not scale from drawing, all dimensions to be checked on site. Report omissions and discrepancies to the architect immediately. © 2021 Studio Itaca LTD	
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		studio-itaca.com	

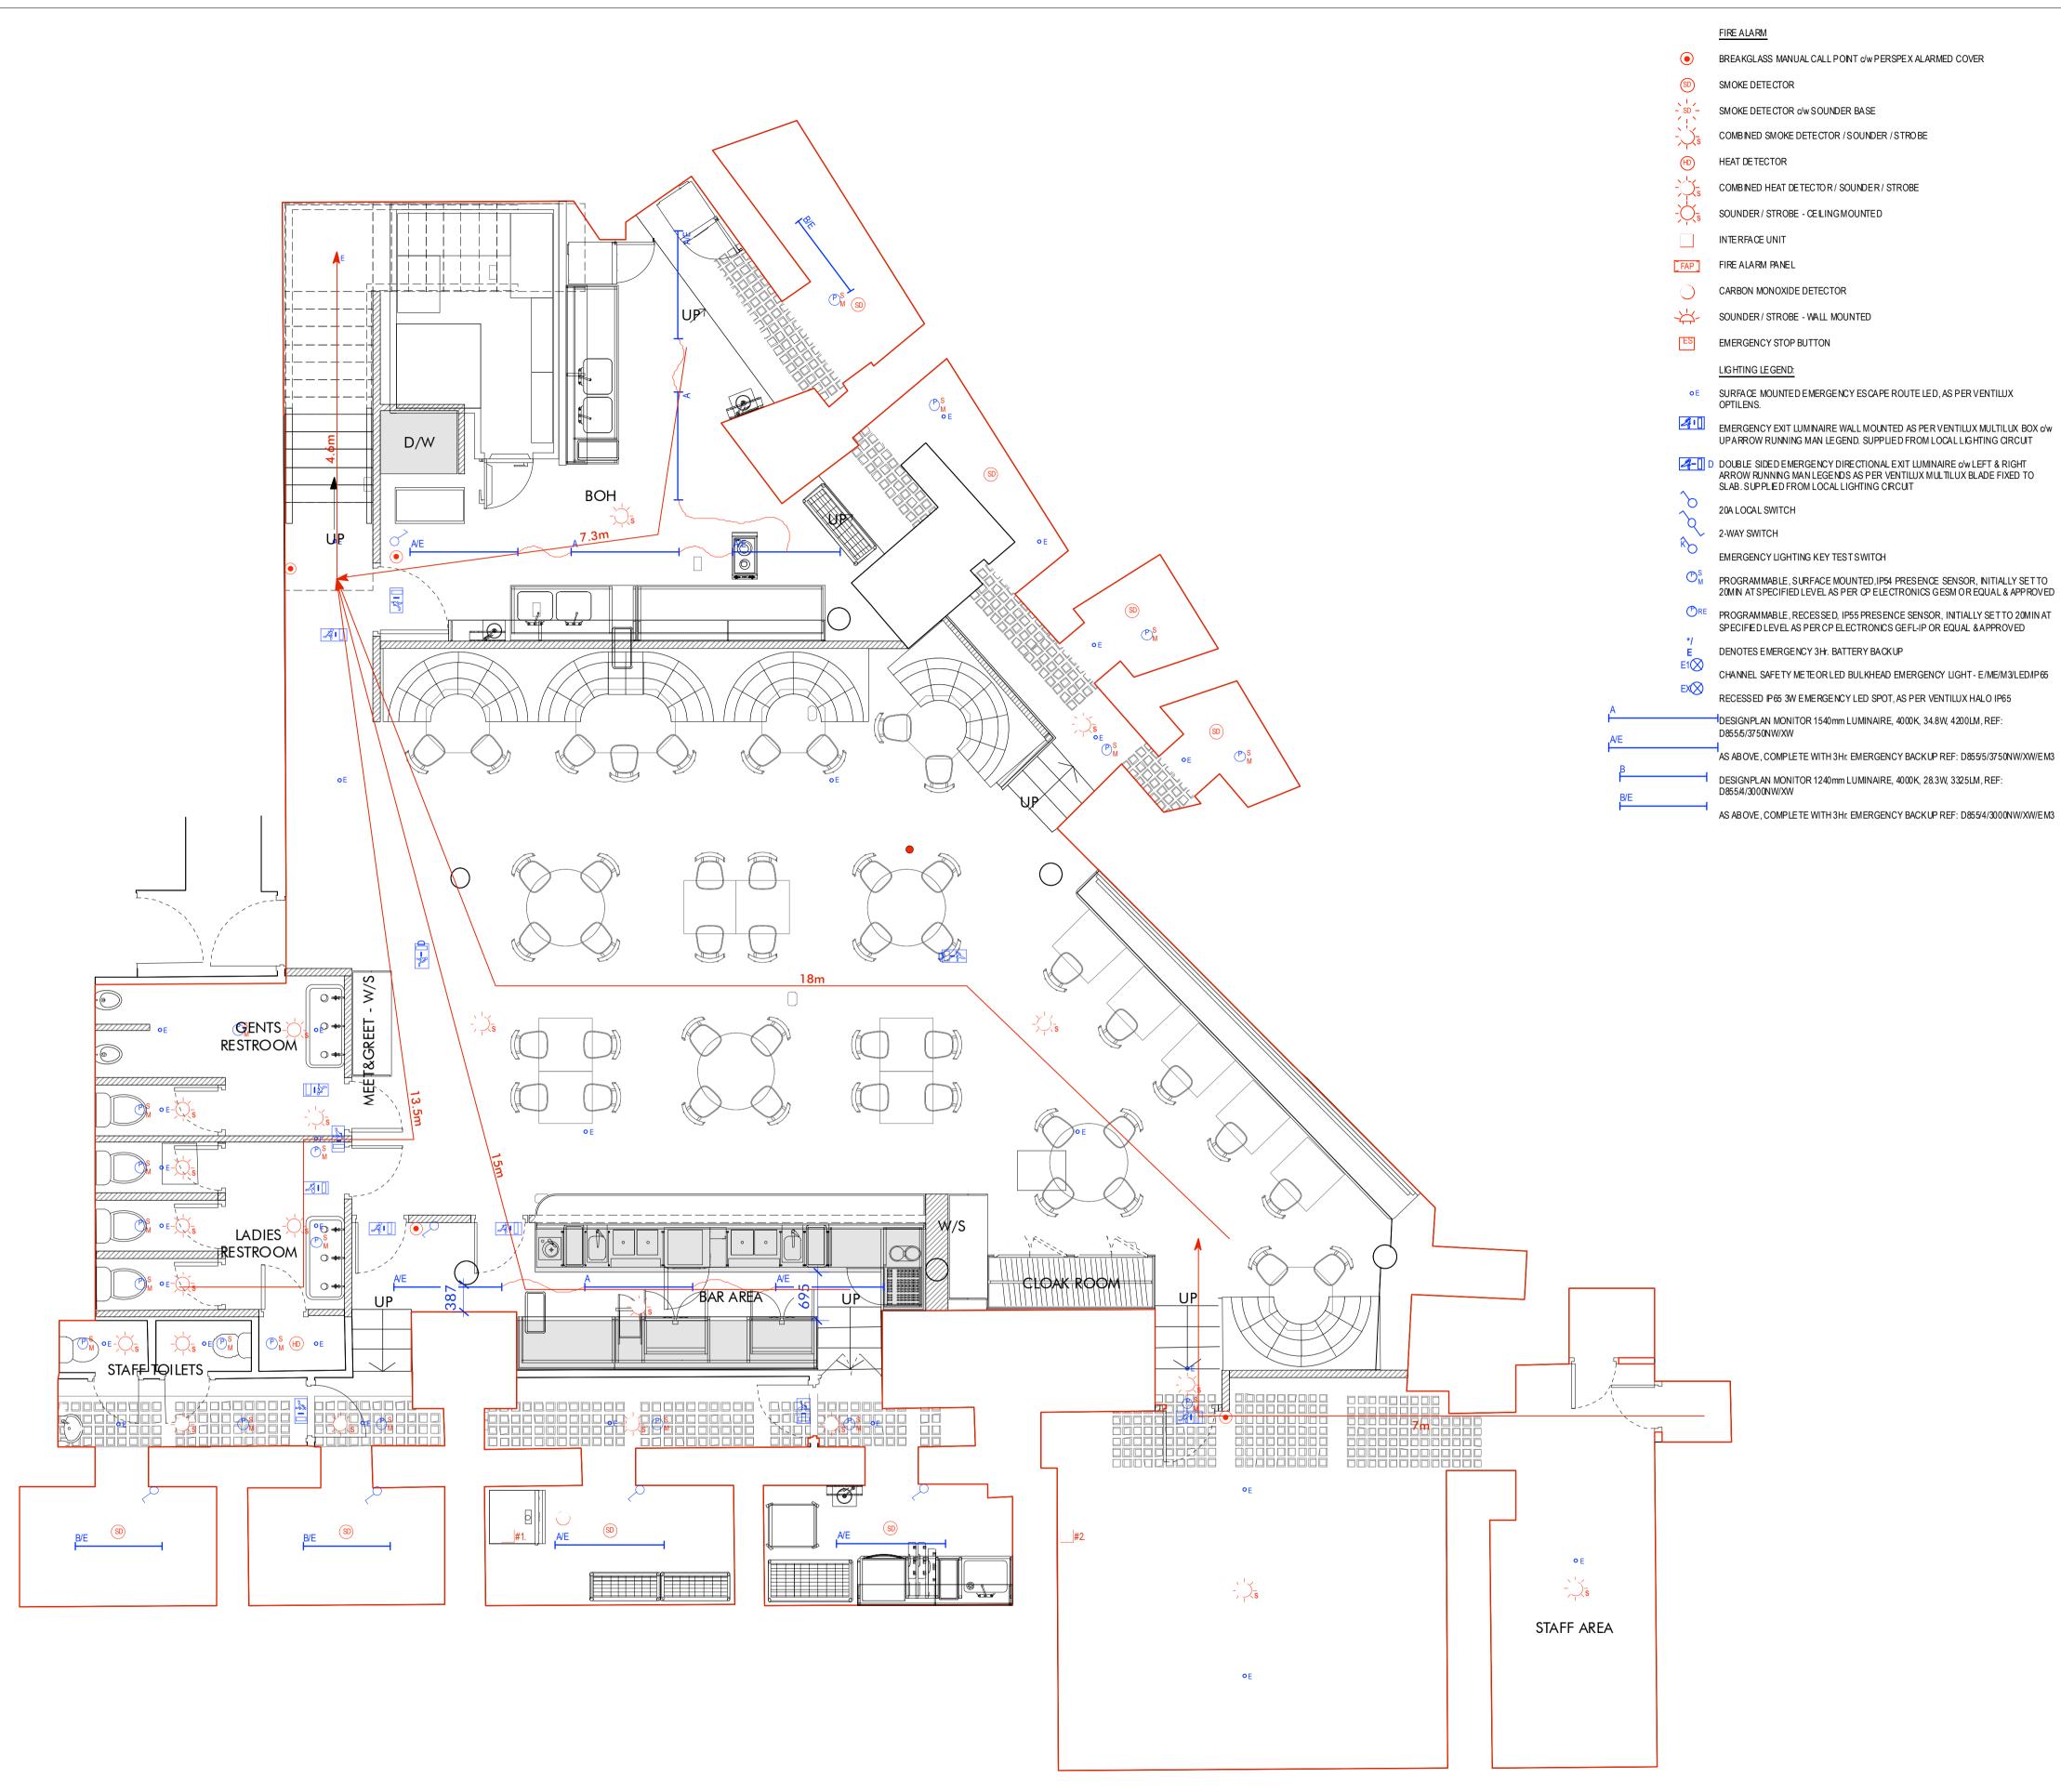

PROPOSED PLAN BASEMENT FLOOR LICENSING Scale: 1:50

1

	Specifications	Notes	
D COVER	EMERGENCY LIGHTING SPECIFIC NOTES:		
	ALL E SCAPE LIGHTING TO COMPLY WITH BS5266-1:2016 & BS EN 1838:2013.		
	ALL EXIT SIGNS TO COMPLY WITH B \$5499-4:2013 & BS ISO 3864-1:2011.	FURNITURE LAYOUT INDICATIVE ONLY	
	EMERGENCY LIGHTING TO BE INSTALLED IN:		
	- APROTECTED ZONE / AN UNPROTECTED ZONE AS OVE RALL BUILDING IS GREATER THAN 18M IN HEIGHT		
	- ALL ROOMS WITH AN OCCUPANCY CAPACITY OF MORE THAN 60, OR IN THE CASE OF AN INNER ROOM, THE COMBINED OCCUPANCY CAPACITY OF THE INNER ROOM PLUS THE ADJOINING ROOM (AND ANY PROTECTED ZONE OR UNPROTECTED ZONE SERVING THESE ROOMS) IS MORE THAN 60		
	- APROTECTED ZONE OR UNPROTECTED ZONE SERVING BASEMENT STOREY		
	- APLACE OF SPECIAL FIRE RISK (OTHER THAN ONE REQUIRING ACCESS ONLY FOR THE PURPOSES OF MAINTENANCE) AND ANY PROTECTED ZONE OR UNPROTECTED ZONE SERVING IT		
	- OPEN AREAS WITH AN ESCAPE ROUTE PASSING THROUGH THEM		
	- AREAS LARGER THAN 60M ²		
S PER VENTILUX	ALL EMERGENCY LIGHTING AND EXIT LIGHTS TO BE CABLED FROM NEAREST LIGHTING CIRCUIT WHEN NO SPECIFIED CIRCUIT SHOWN.		
NTILUX MULTILUX BOX c/w AL LIGHTING CIRCUIT	FIRE ALARM SPECIFIC NOTES:		
RE c/w LEFT & RIGHT ILUX BLADE FIXED TO	FIRE ALARM SYSTEM TO COMPLY WITH BS5839 PART 1:2017		
	ALL FIRE A LARM CABLES SHALL BE PH120 ENHANCE DGRADE CABLE; FIRE RETARDANT, SELF EXTINGUISHING.		
	WIRING SYSTEMS TO BE SUPPORTED BY FIRE-RESISTANT FIXINGS AND FASTENINGS.		
	CABLE TO BE ON / IN CONTAINMENT THROUGHOUT ITS ROUTE, UNLESS OTHERWISE INDICATED.		
ENSOR, INITIALLY SETTO IM O R EQUAL & APP ROVED NITIALLY SETTO 20MIN AT	ALL EQUIPMENT AND ACCESSORIES TO BE RECESSED IN WALLS I.E. A FLUSH INSTALLATION. UNDER NO CIRCUMSTANCES WILL SURFACE WIRING BE ACCEPTED.		
QUAL & APPROVED	AT EACH DETECTOR, CABLE TO BE ADEQUATELY SUPPORTED BETWEEN SOFFIT AND CEILING LEVEL. CABLE TO TERMINATE INTO A BESA BOX AT CEILING LEVEL.		
LIGHT-E/ME/M3/LED/IP65	FOR WALL MOUNTED DEVICES CABLE TO TERMINATE ABOVE CEILING		
ILUX HALO IP65	INTO 20mm GALVANISED CONDUIT RECESSED INTO BUILDING FABRIC.		
4200LM, REF:	• FIRE ALARM SYSTEM TO COVER ALL AREAS TO L1 CATEGORY.		
EF: D855/5/3750NW/XW/EM3			
3325LM, REF:	FIRE ALARM INTERFACES 1. GAS SOLENOID VALVE		
EF: D855/4/3000NW/XW/EM3	2. MUSIC SY STEM		

Revisions

Revisions			
DD	1	21/04/21	lssued to BCO

DD	2	15/06/21	Issue for Licensing

DD	3	16/06/21	Revised notes

Proje	ct		
Lina	Stores	- 68 Wigmore	W1U 2SD

Client LS-WRF

Drawing Title Proposed Plan Basement Floor Licensing

Scale @ A 1

1:50 @ A1

Drawning number 013-803

Revision

DD3

Drawn by

GP

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