

NOTES:

1. This drawing is to be read in conjunction with all relevant contract documentation from the design team, with any conflicting information to be brought to the attention of PolarDesign Architecture in writing before commencing on site.
2. The contractor is to check and verify all levels and dimensions before construction. Any discrepancies are to be brought to the attention of PolarDesign Architecture
3. All dimensions in mm, unless otherwise stated.
4. All sub base and concrete design and specification to engineer's details. All diagrams provided here are purely indicative.
5. Waterproofing of any element to be specified by others.
6. All proprietary products shall be installed in accordance with manufacturers written instructions.

TITLE  
Existing Plans and Elevations

CLIENT

DRAWN BY  
Ivar Selter

CHECKED BY  
PD


DATE  
28/09/2021

SCALE (@ A1)  
As indicated


PROJECT NUMBER  
35SAND/21

DRAWING NUMBER  
101

REV

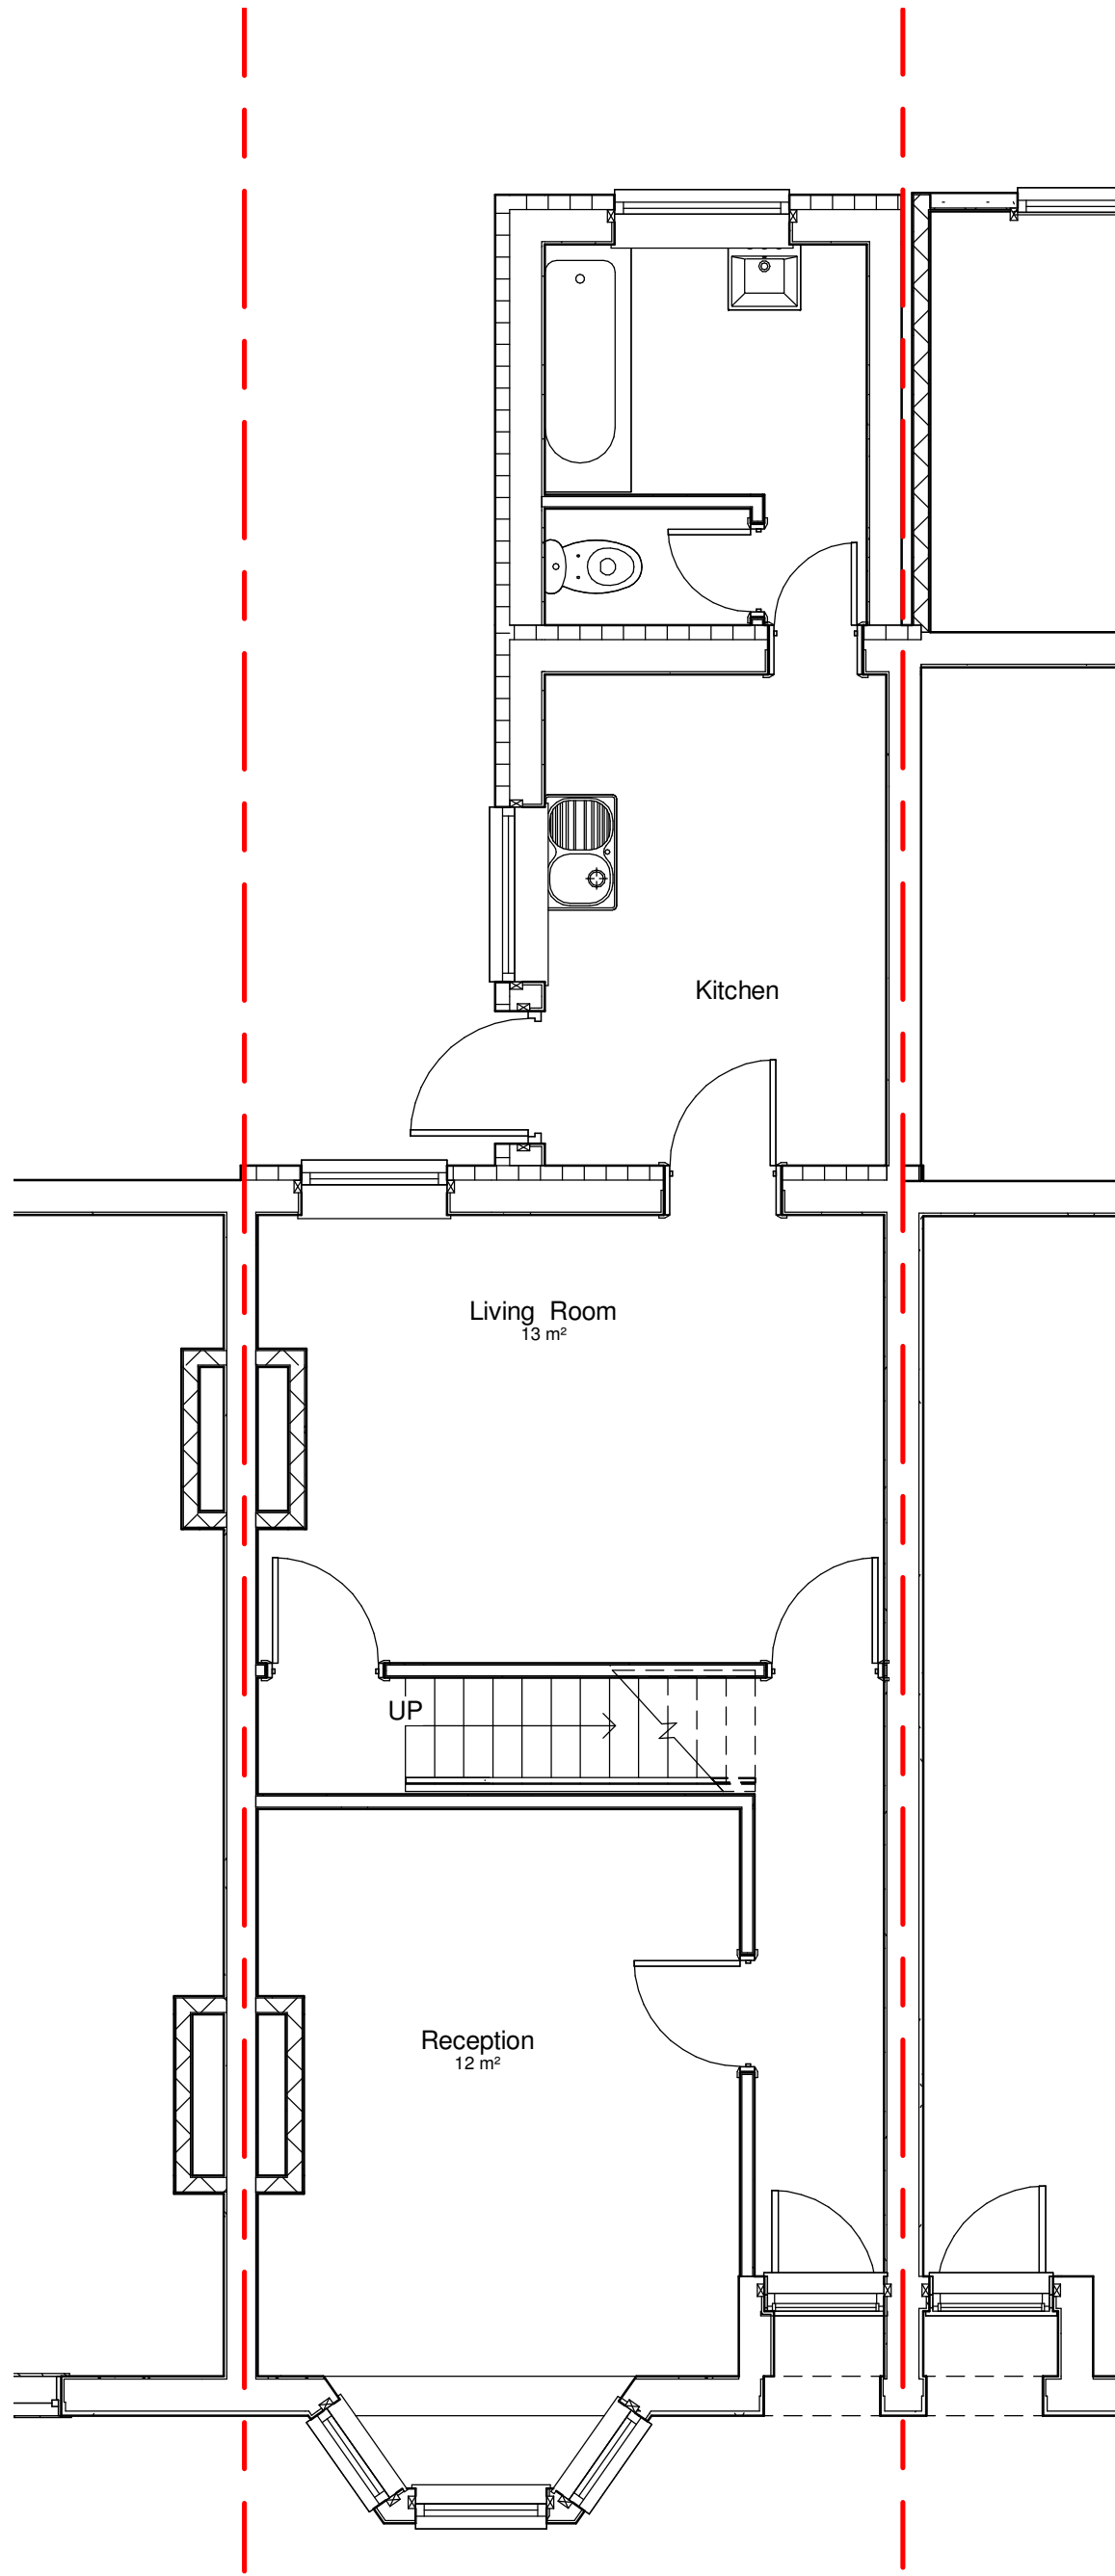

1 01 Existing Ground Floor  
1 : 50

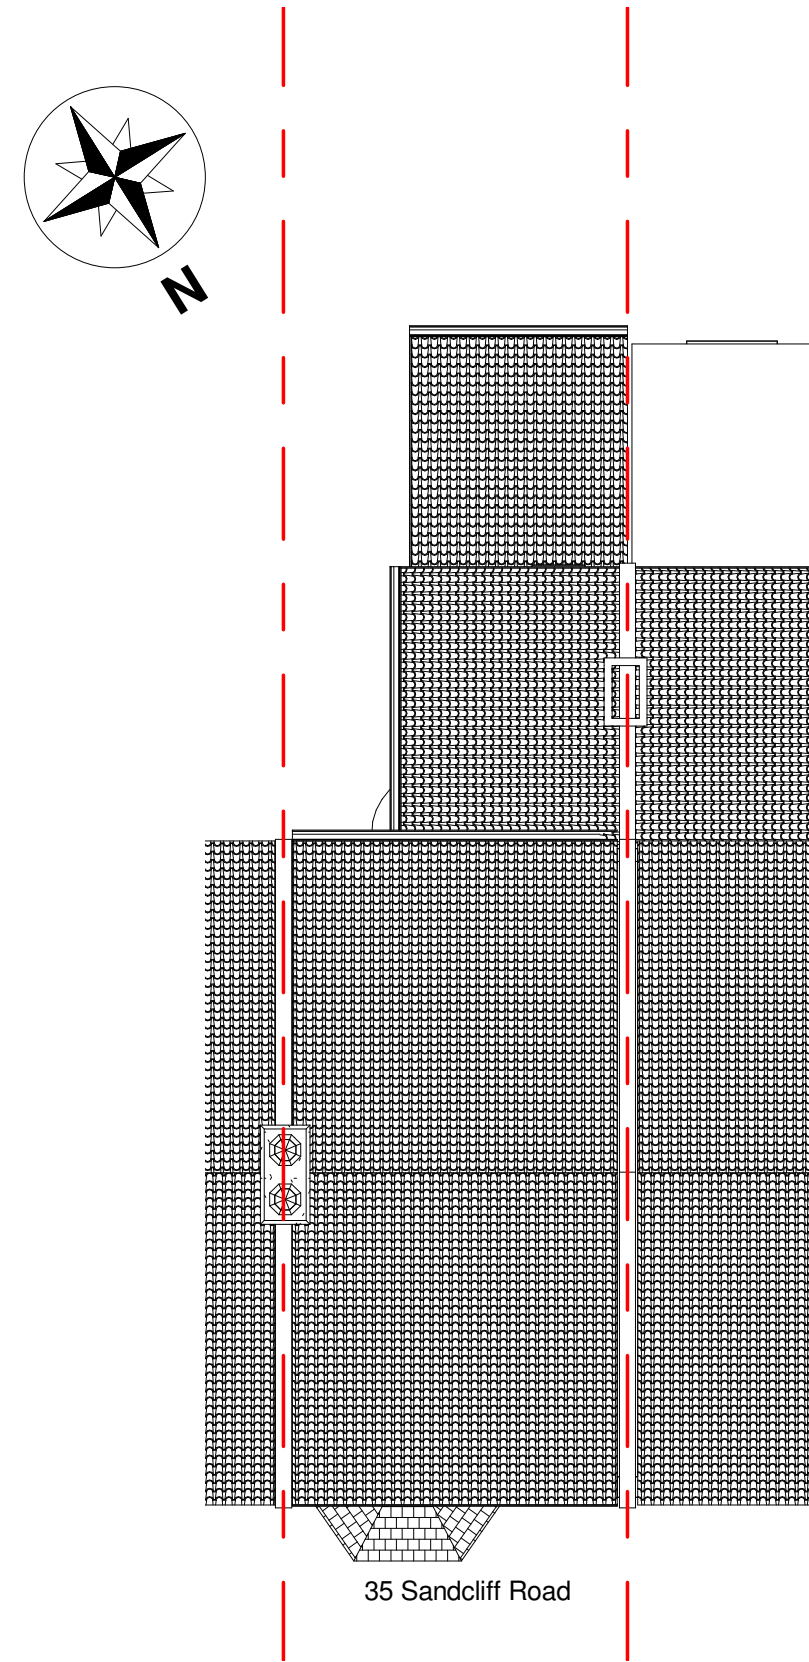


0m 1m 2m 3m 4m 5m  
VISUAL SCALE 1:50 @ A1

0m 2m 4m 6m 8m 10m  
VISUAL SCALE 1:100 @ A1


2 Site  
1 : 100




6 Existing South Elevation  
1 : 100

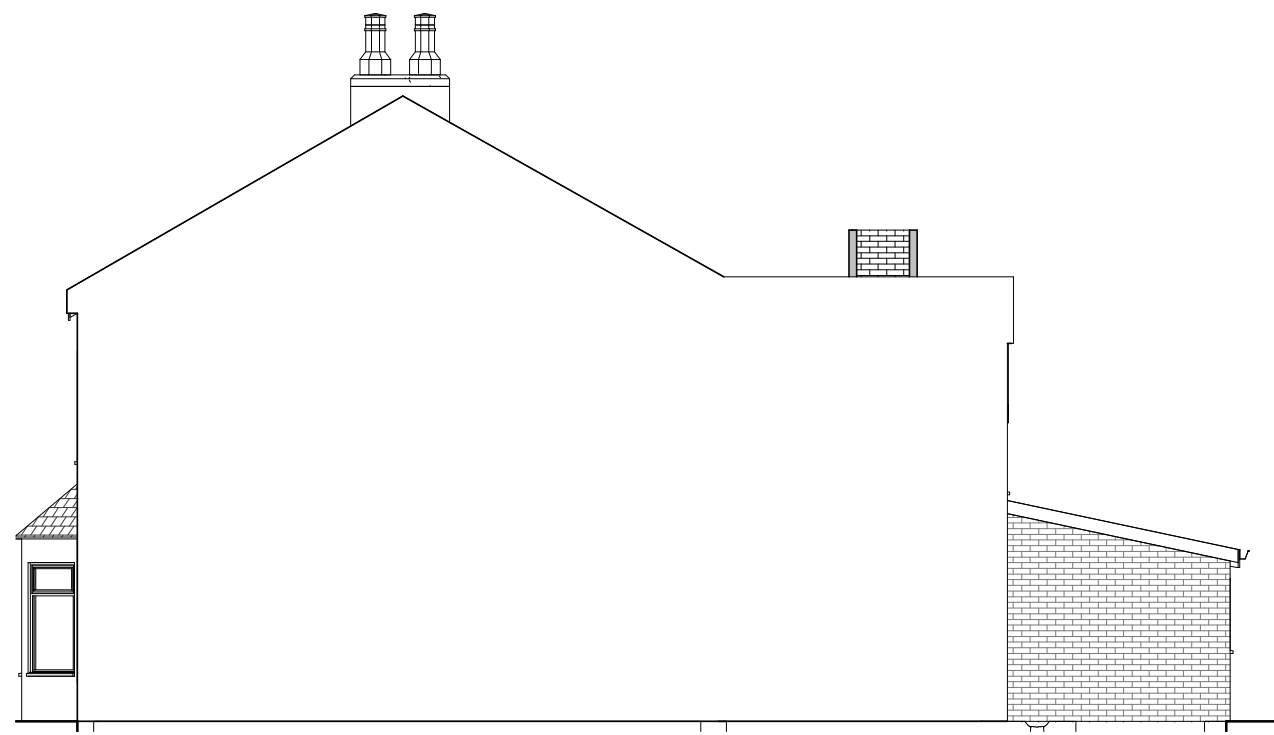

5 Existing North elevation  
1 : 100

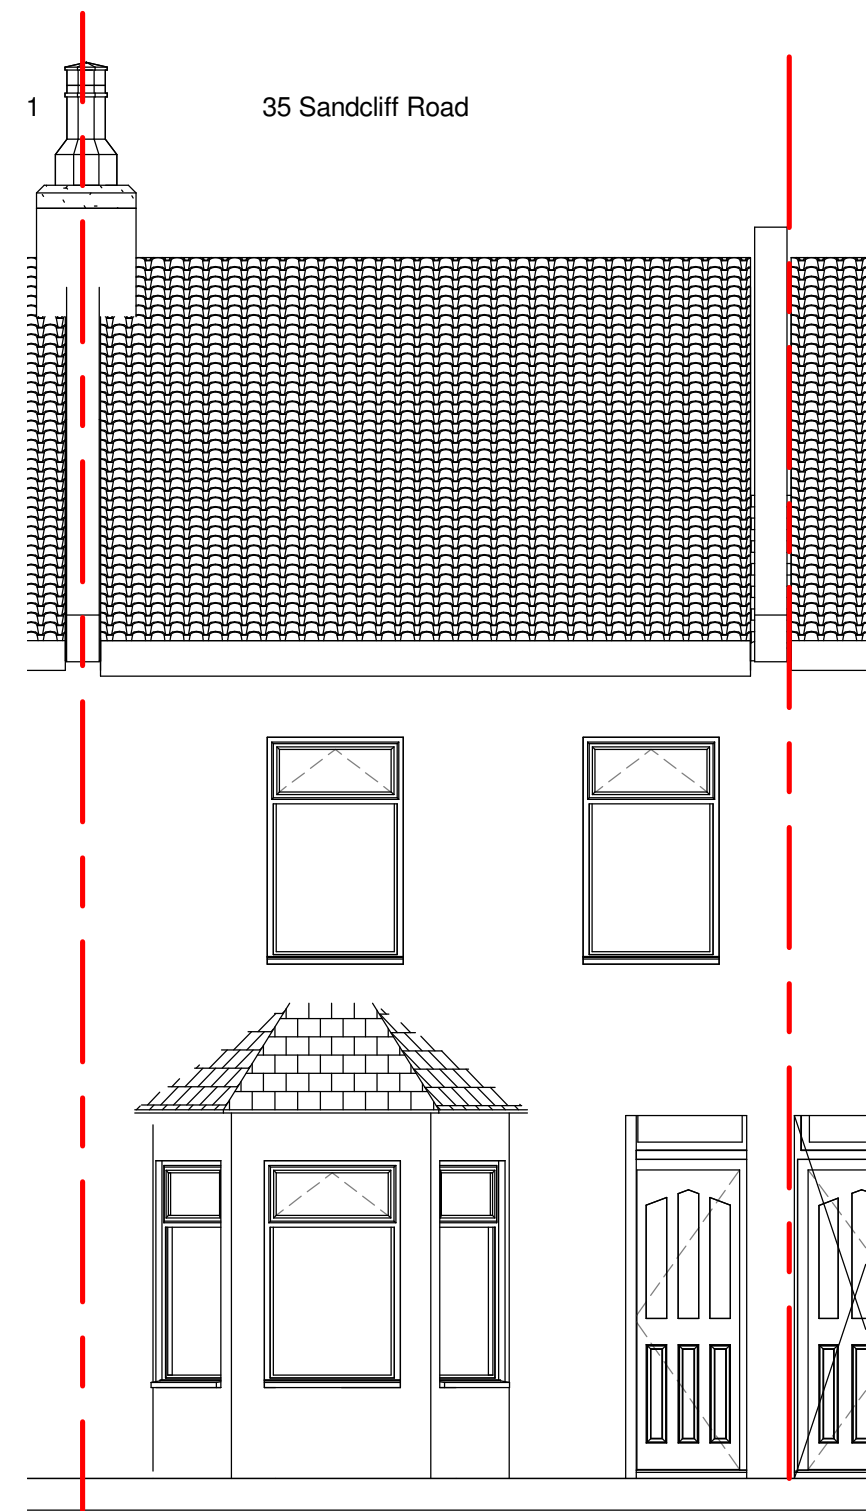

3 Existing Front Elevation  
1 : 50

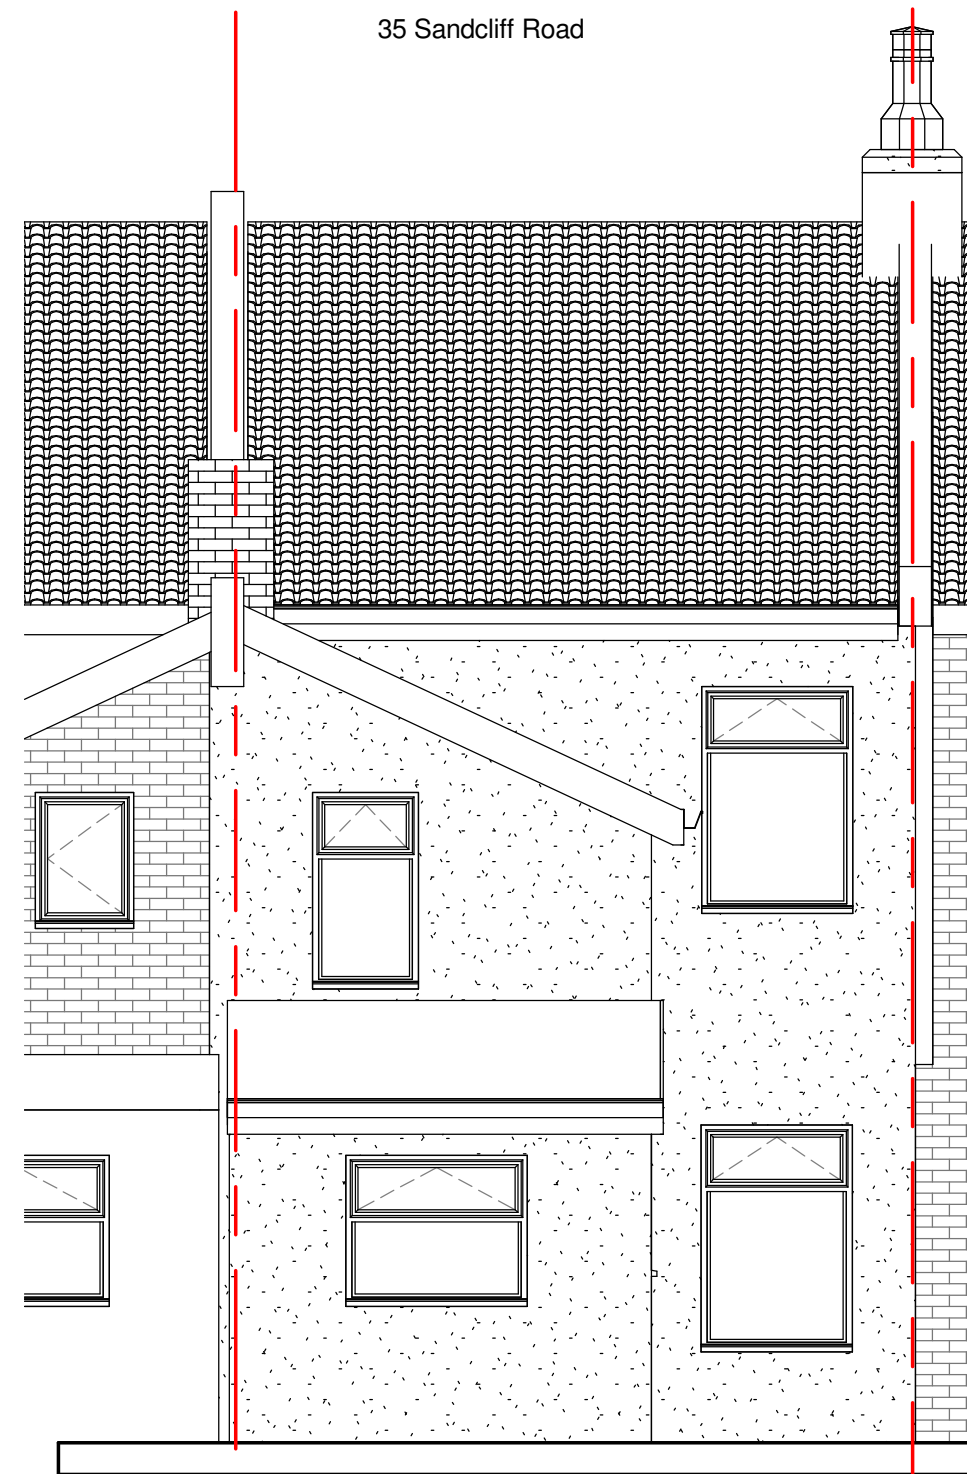

4 Existing Rear Elevation  
1 : 50

Erection of rear /side single storey extension  
incorporating flat roof and roof lights  
at 35 Sandcliff Road DA8 1NZ