


Low Level Path Lighting


Lanea Path Lighting Bollard with PIR sensor.

Beneficial features :

- LED mains wired.
- Low level height, only 40cm high.
- LED bulbs installed into this pillar lamp are in such a manner that they shine downwards onto cascading reflectors, keeping all light at low level.
- Integrated PIR sensor, keeping light levels low and only on when required.
- Range 2-8metres, set at 5m as shown.
- Lighting duration (5 seconds to 6 minutes ) are configurable.
- Detects movement at an angle of 90 degrees .

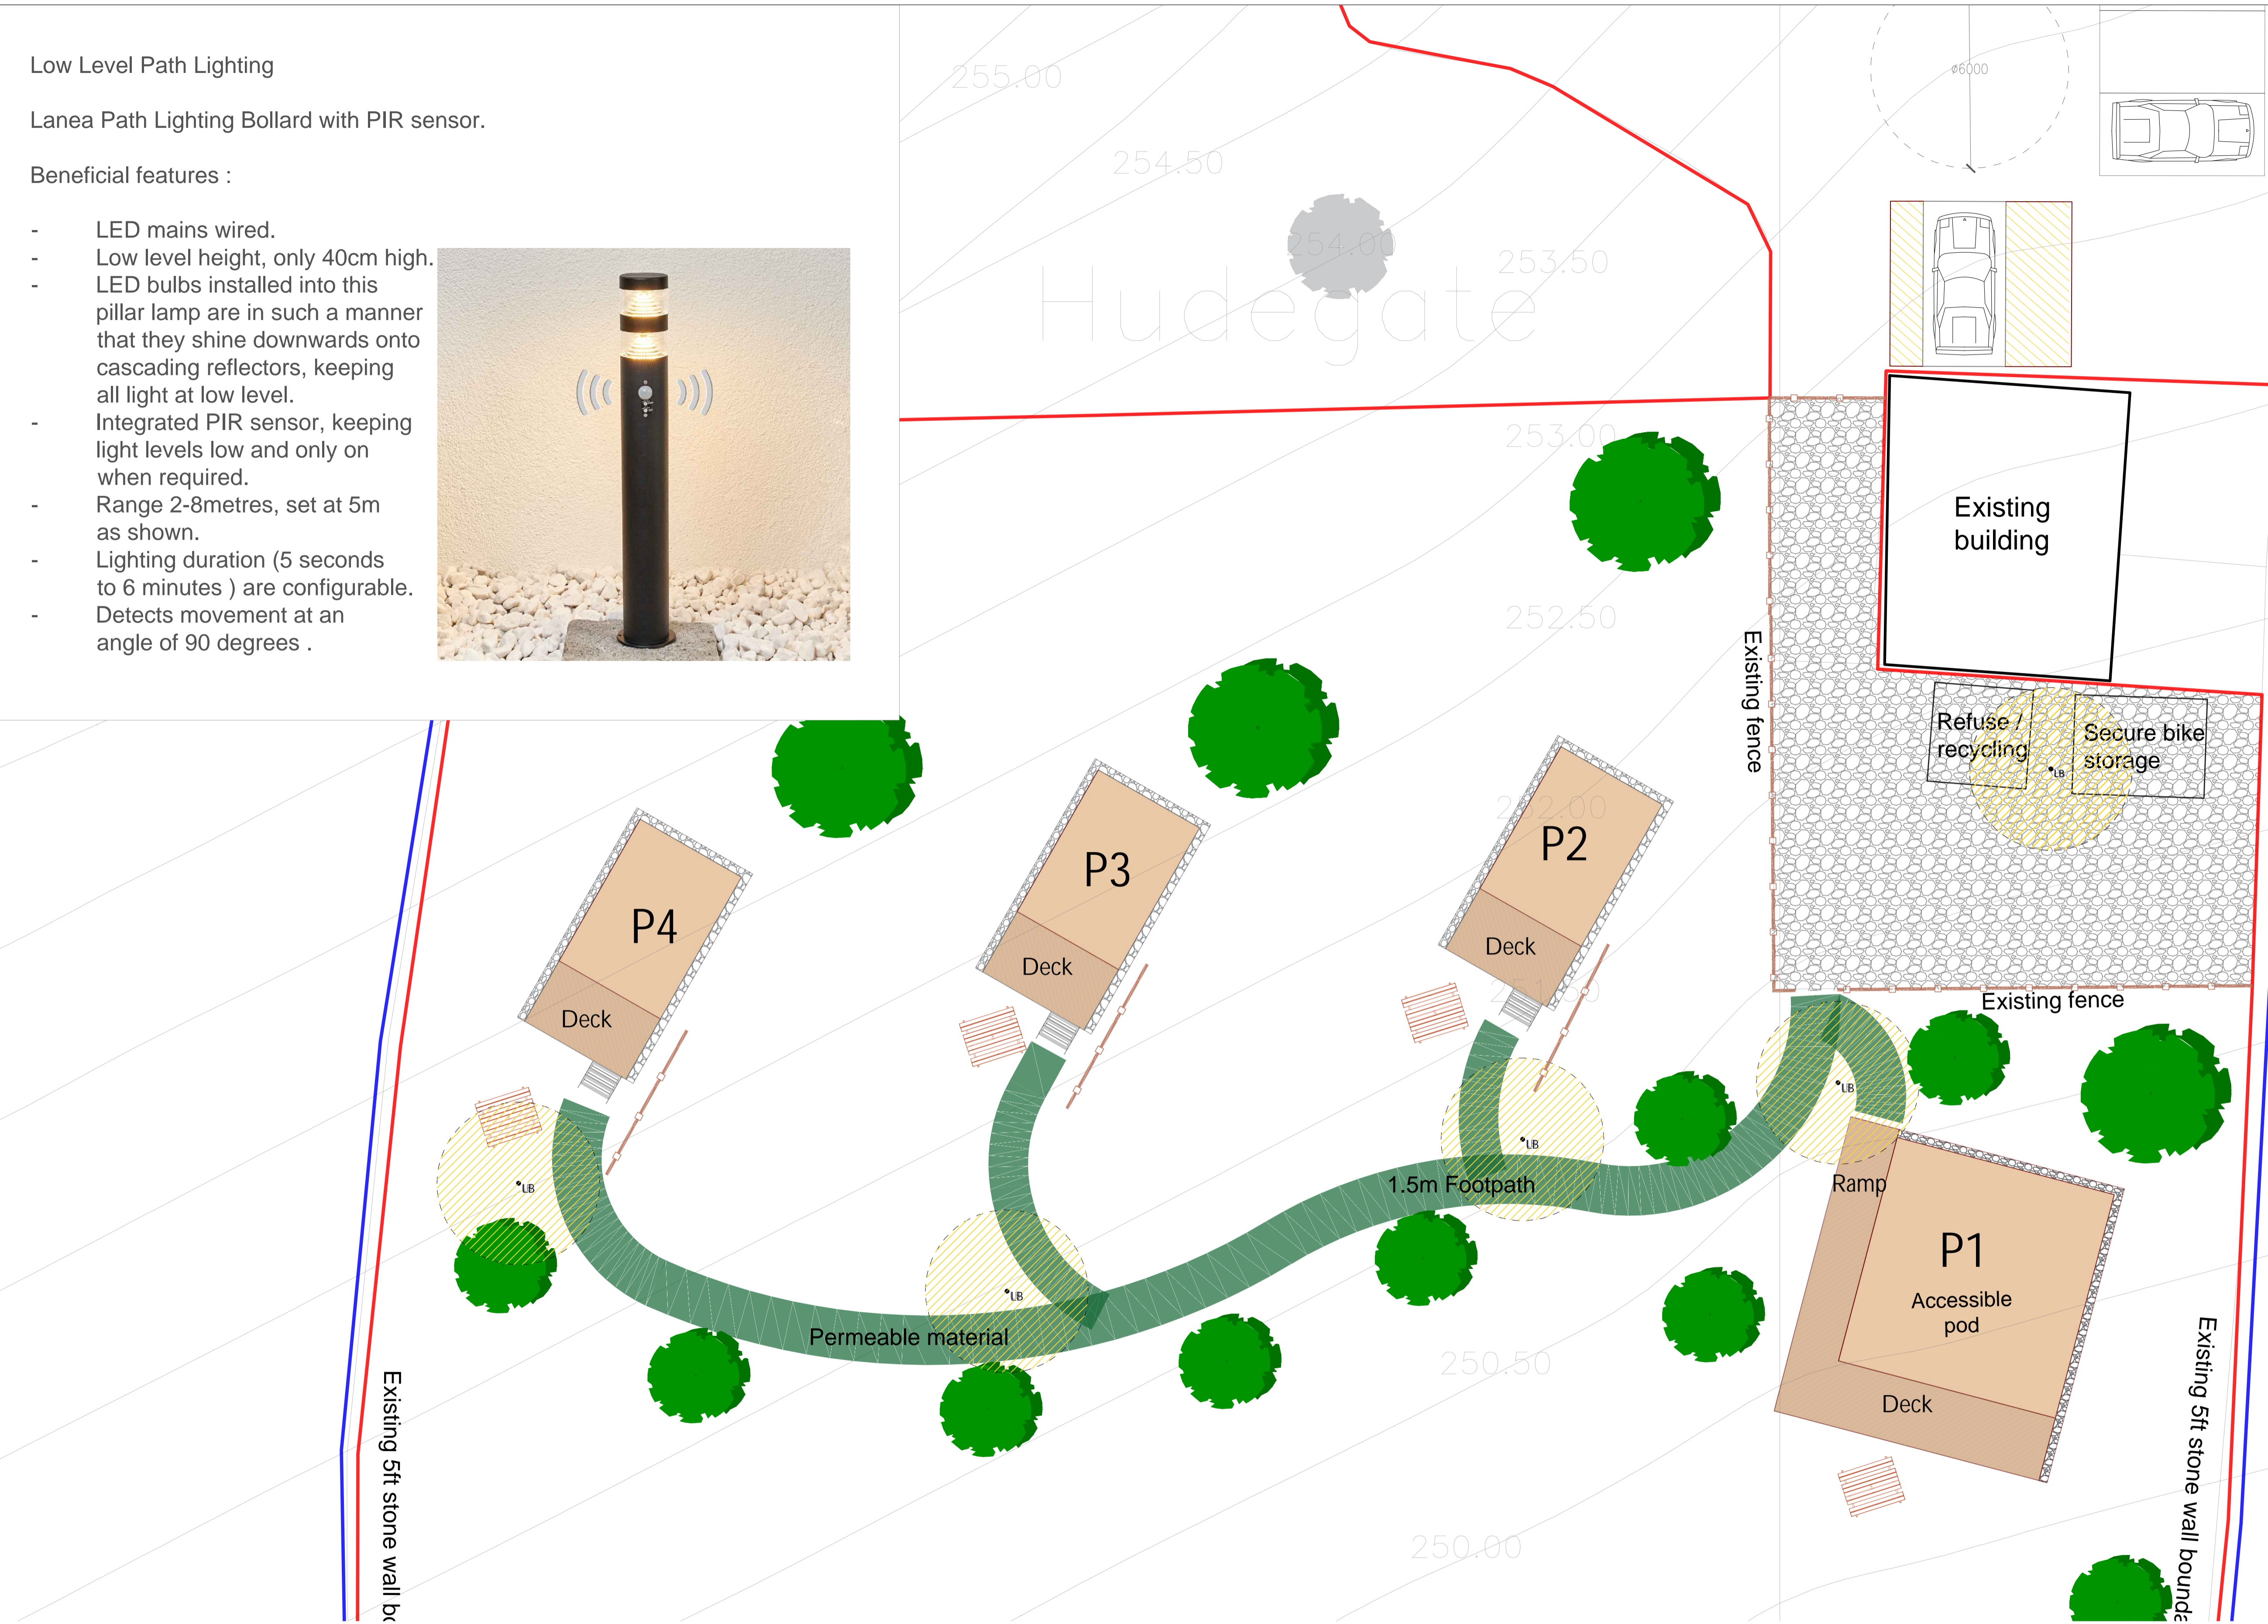


KEY TO SYMBOLS

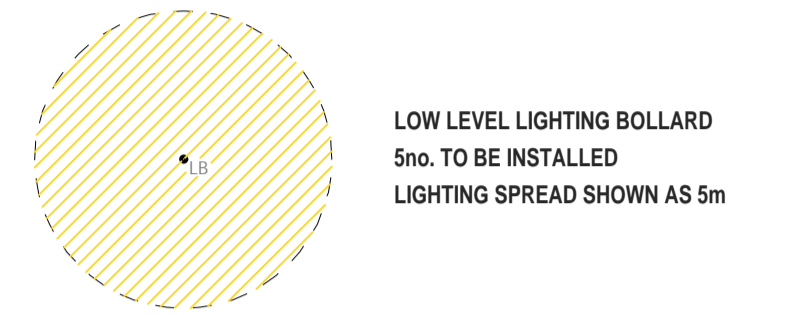

Date	Description	Rev	By

Revision Description

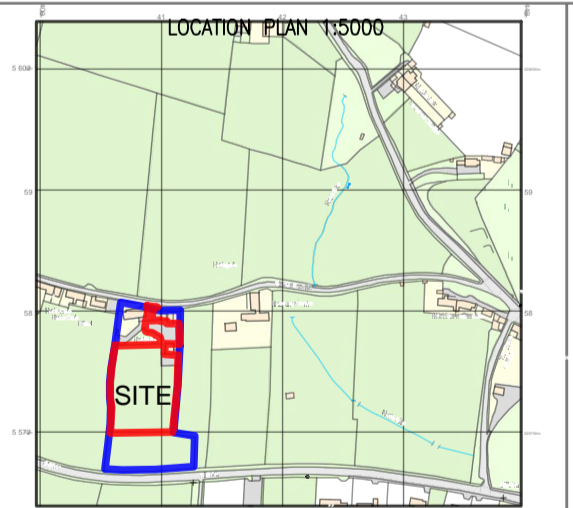

Project:  
Proposed Glamping Site - For Charlotte Snowdon  
Hudegate Farm, Middleton in Teesdale  
DL12 0QR

Drawing Title:  
LIGHTING PLAN


Drawing Number:  
**210318-01-07**

Revision:  
Date: 08-09-21  
Scale: 1:100 @ A1  
Drawn By: TA  
CAD Dwg File: -  
Arch. Base Dwg:

Issue Status:  
**Full Planning Application**

OWNERSHIP BOUNDARY

SITE BOUNDARY

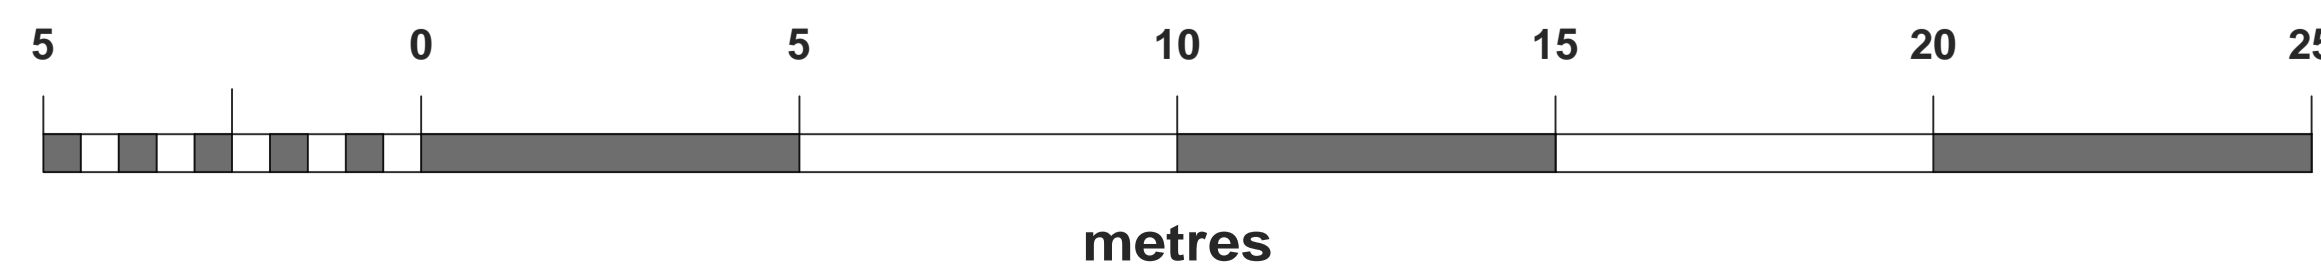

**NORTH**

