
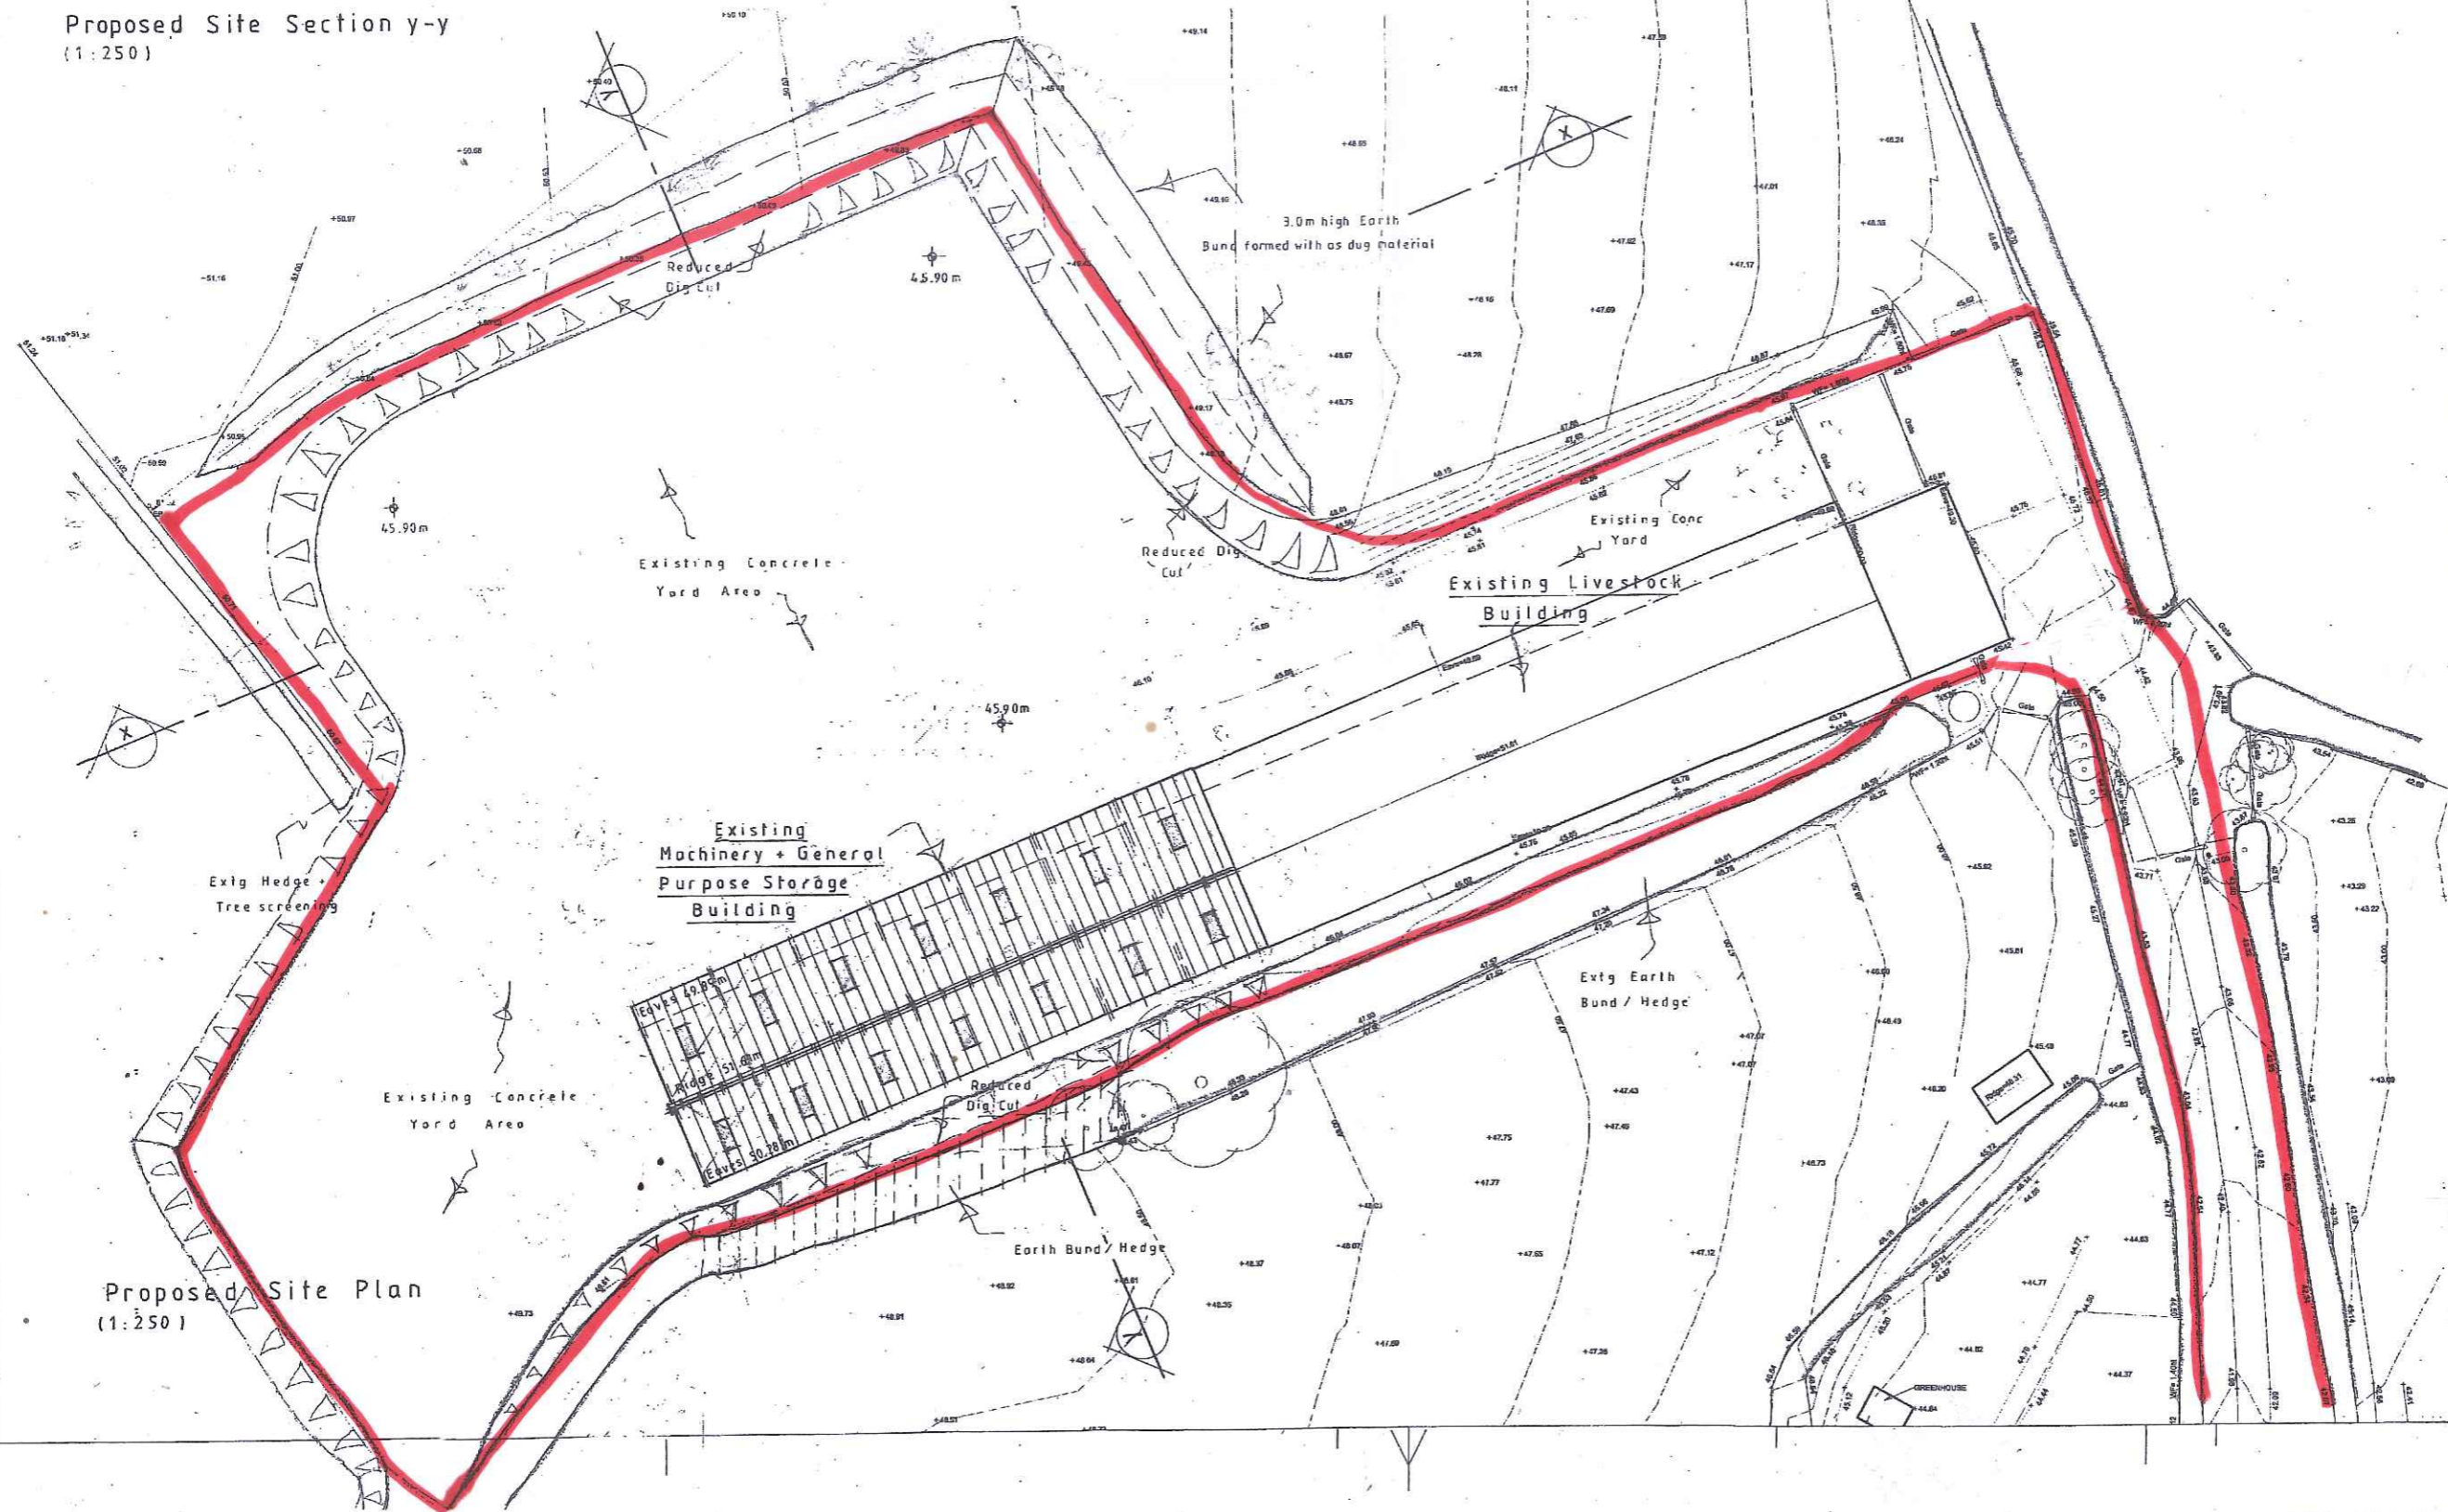
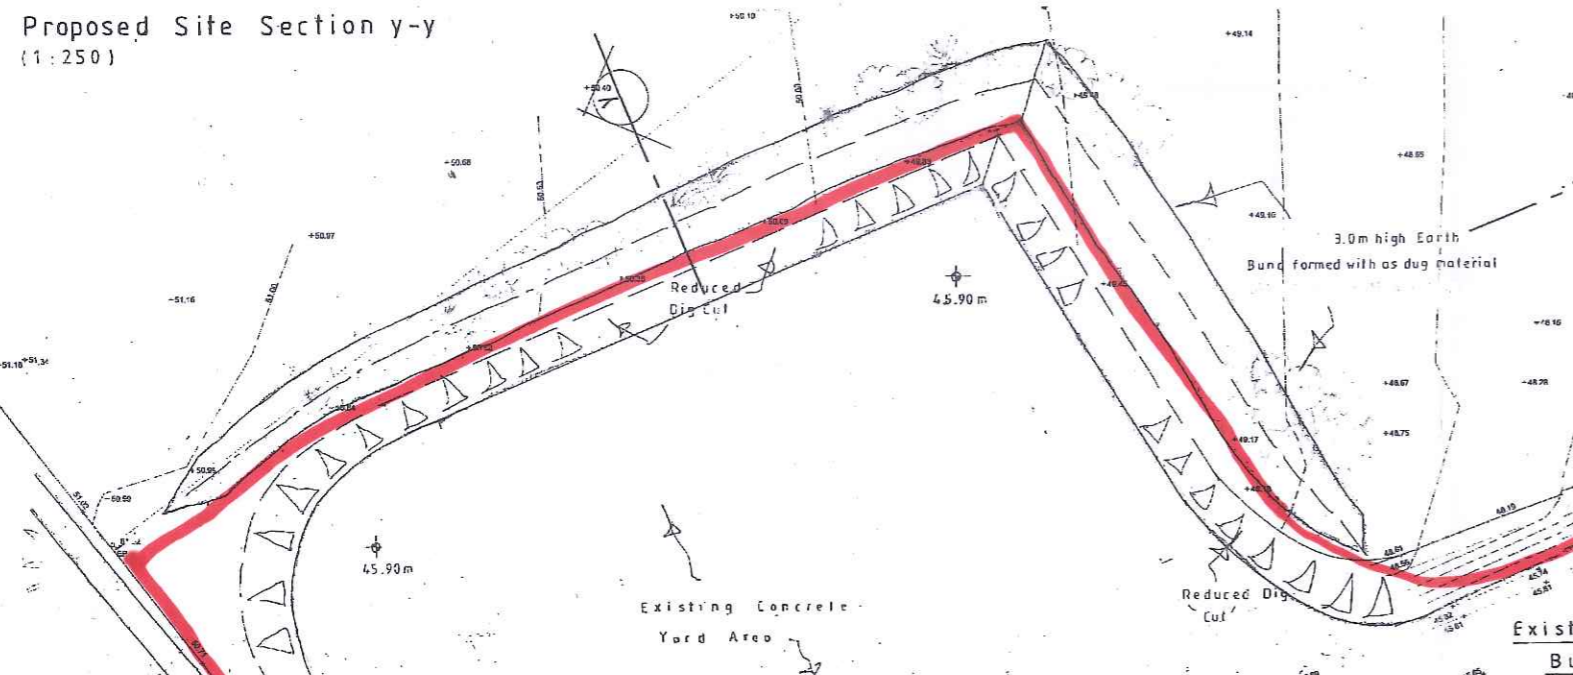
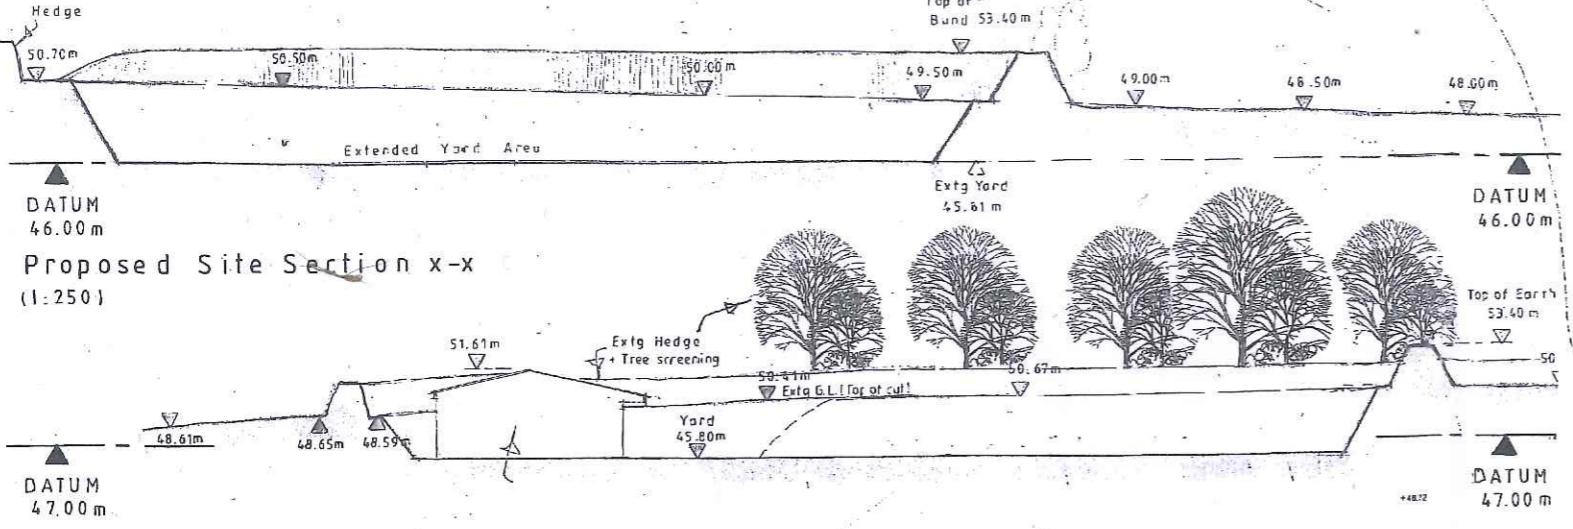


- Notes:
- COPYRIGHT OF THIS PLAN IS HELD BY DOUGLASS GEOMATICS LTD. NO RESPONSIBILITY IS TAKEN FOR AMMENDMENTS BY OTHERS.
  - THE ORIGIN & ORIENTATION OF THE SURVEY GRID IS ARBITRARY.
  - LEVELS ARE RELATED TO OSG83(02)
  - LEVELS AT KERB RELATE TO ROAD CHANNEL.
  - PIPE DIAMETERS ARE ESTIMATED BY SURFACE INSPECTION.

AV	AIR VENT	MH	MANHOLE
BD	BOLLARD	MR	MARKER
BS	BUILDING	MS	MALE STONE
CB	CONCRETE	OHB	OVERHEAD BUILDING
CC	CRASH BARRIER	OCB	OVERHEAD CABLE
CBF	CRASH BARRIER	OPF	POST & RAIL FENCE
CL	COVER LEVEL	OWF	POST & WIRE FENCE
CPWF	CONC. POST & WIRE FENCE	RF	RODDING EYE
CS	CHANGE OF SURFACE	RG	RAILING
D	DIAMETER	RHM	ROAD MARKING
DK	DROP KERB	RWR	RIVER
EIC	ELECTRICAL INSP. COVER	RW	RETAINING WALL
EP	ELECTRICITY POLE	SL	SPOT LEVEL
FF	FINISH FLOOR LEVEL	SMH	STORM MANHOLE
FH	FIRE HYDRANT	SP	SOFT LEVEL
FMH	FUUL MANHOLE	SV	STOP VALVE
FP	FLAG POLE	SWL	STONE WALL
G	GULLY	SY	STAY
GPST	GATE	TB	TOP OF BANK
GV	GV STOP VALVE	TK	TRACK LINE
HE	HEDGE	TR	TRUCK
HF	HEDGE FACE	TP	TELEPHONE POLE
IC	INVERT COVER	VF	VERGE
IL	INVERT LEVEL	VF	VENT
KB	KERB	WF	WOODEN FENCE
LP	LAMP POST	WL	WALL
		WM	WATER METER

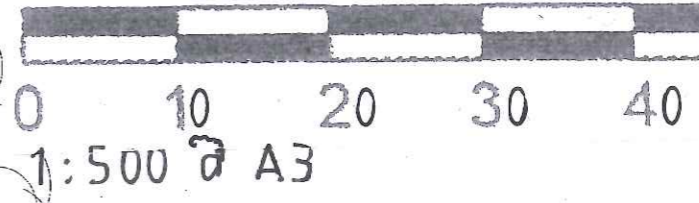

Date	Revisions

© copyright  
**MARK. D.P. DATSON**  
 ARCHITECTURAL CONSULTANT LTD  
 MRICS, MB Eng  
 TREWORLAS CHAPEL, TREWORLAS,  
 RUAN HIGH LANES, TRURO,  
 CORNWALL, TR2 5LN.  
 TEL: (01872) 501153  
 MOBILE: 07831 122080  
 mark@treworlas.freemove.co.uk



Client  
 Mr + Mrs M. Rowe

Job Title  
 Proposed Agricultural  
 Building for Feed / Fodder Store  
 at  
 Lower Penhallow Farm  
 Ruan High Lanes  
 Truro

Drawing Title  
 Existing Site Plan +  
 Site Sections x-x + y-y

Scale 1:250 @ A1 + 1:500 @ A3

Date March 19 Drawn by M.D.

Dwg. No.	Rev.
M.R. 0002	