

CONTINUOUS PIR-CIPP

MAX PITCH 42"

UNDERDROUN WITH 9 PLASTERBOARD T SKIM.

GOOM WICE GETTIES HANDENILS AND LANSING. 900- HIGH HAMMAIL, HOOME WIM HT LANGE

THEREMALITE (OR MENTL) BLOCKWOOL WHER LESS.


- STONE ENTERNAL LENS (RE-USED FROM EXISTING SITE) WITH


CENTRES MORROSTALLS, 450 CENTRES VERTICALS.


STRINGS STEEL TIES DETLIEDY LEMIES OF PARTIE TOO

PURPLE MADE STRUCTURE AS SHOUR ON PLAN

MAX INSE MOME THE TREAD ZHOW.

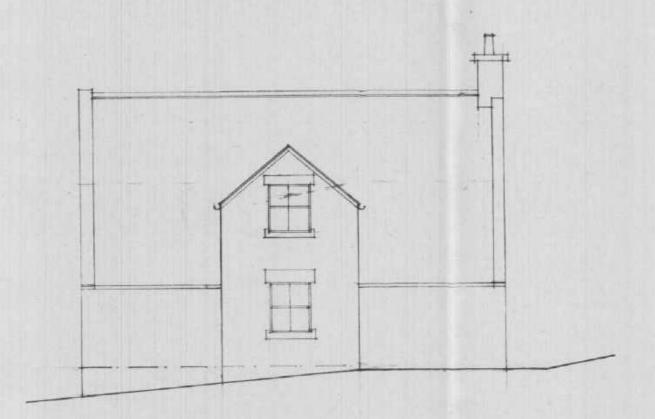

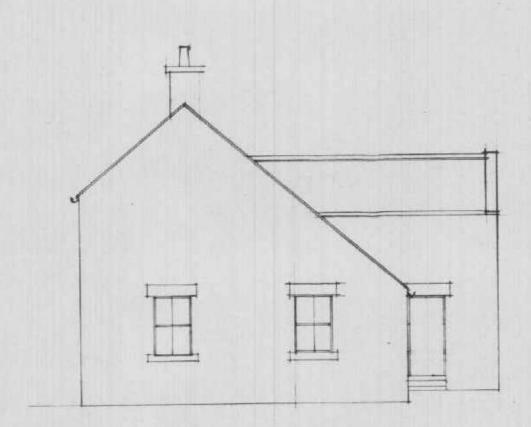

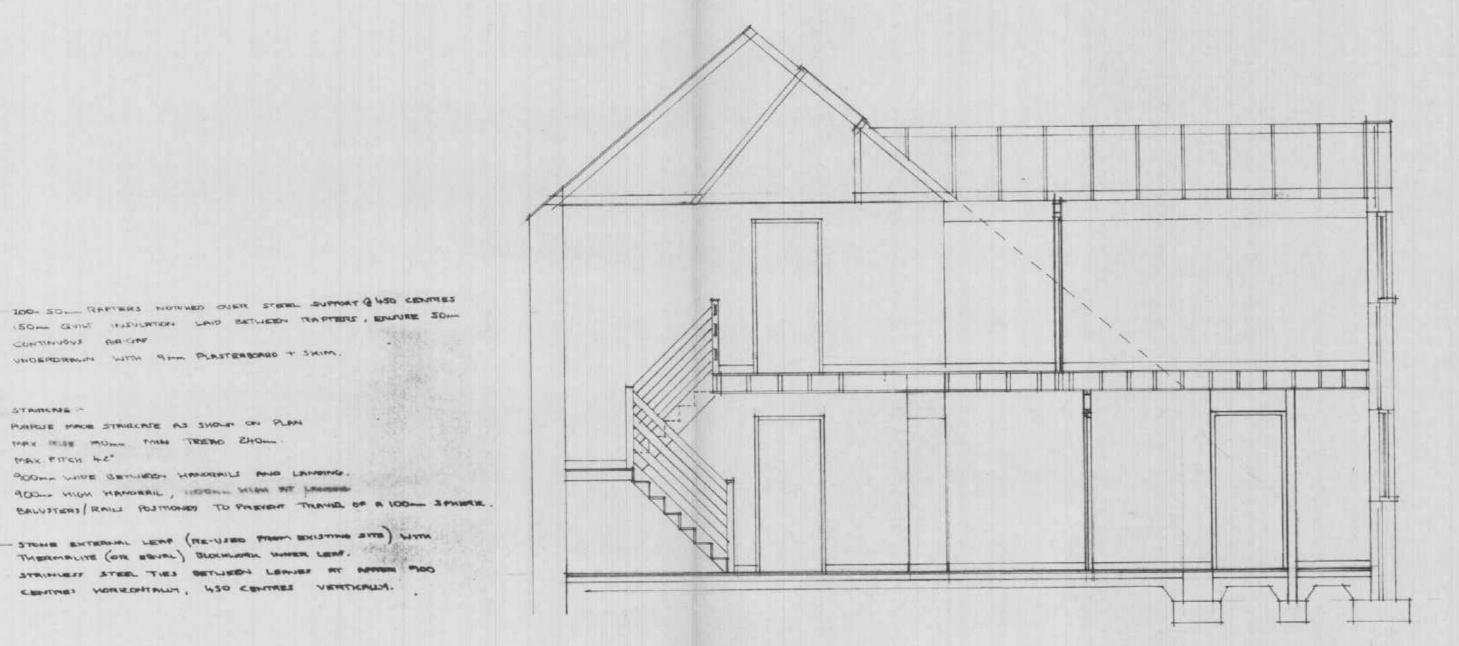

ROOF TRUSSES TO SPECIALIST PREMERCINEE LONGITUDINAL DIAGONAL AND CEILING THE-BRACING AS BS SEER PARTS MES.

PROPRIETORY TRUSSED RAPIERS @ 450 CENTRES ---TO SPECIALIST MANAGETHE. 38 - 25 - TANRUSED BATTERS AT REQUIRED GUALE ON UNTERRABLE SARWHID FEET


150- QUILT INSULATION LAID BETWEEN TRUSSES -100mm HALF ROMD OWNER WITH 75mm DOMENTES

38- GYPROX PRICED URETHANE INJULATING BORRO . TO DRY- LINE EXISTING AND PROPOSED WALLS ON IZMM DABS .

2.25 M 75 SCH FLOOR STOLETS @ 600 CENTRES -H- T+G WENROL FLOORING OVER. UNDERDRICH WITH THE PLANTERSONED + SHIP 150 + 150 - REINF. COME. LIMPLE DIER NEW -WESTER IN EXISTING WILL. To ENG. PRINTE.

More WETROC TIG PLOORING ON 40 -INSULATION (RWS OR 6) ON 100mm COME, FLOOR SUMB ON 1200 GNAGE VISQUEEN VARBUR SHREET ON ISO WELL RELIED RED BLINCED HARDIORE

. The WEYROR T. G. FLOORING ON HOLL ROCKWOOL FLOORSLASS ON 1000 CONCRETE FLOOR SLAD ON 1200 GAVOE VIZANEZH VAROUR GARRIER ON 150- WELL ROLLED AND BLINDED HAROCORE -700 + 300 - CONCRETE FOUNDMONTONE AT GOOME GETTIN CHONNO FEART

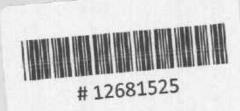



ANGUS LEYBOURNE & CO.
ARCHITECTS

MOUNT HOUSE OFFICE, SPRINGWELL, GATESHEAD, NE9 7YU

Tel; (091) 416 0777


IOR PROPOSED CONVERSION to 4no DWELLINGS: NEWFIELD FARM: MINSTERACRES for Mr P CUTHBERT

SECTIONS ! ELEVATIONS PROPOSED

DATE

DRG No.

external walls. Stone (he used from existing site) with 67mm cavity filled with theckwood his viation batts. Stainless steel wall ties as befor looming load bearing cone blocks with 12mm plaster finish.

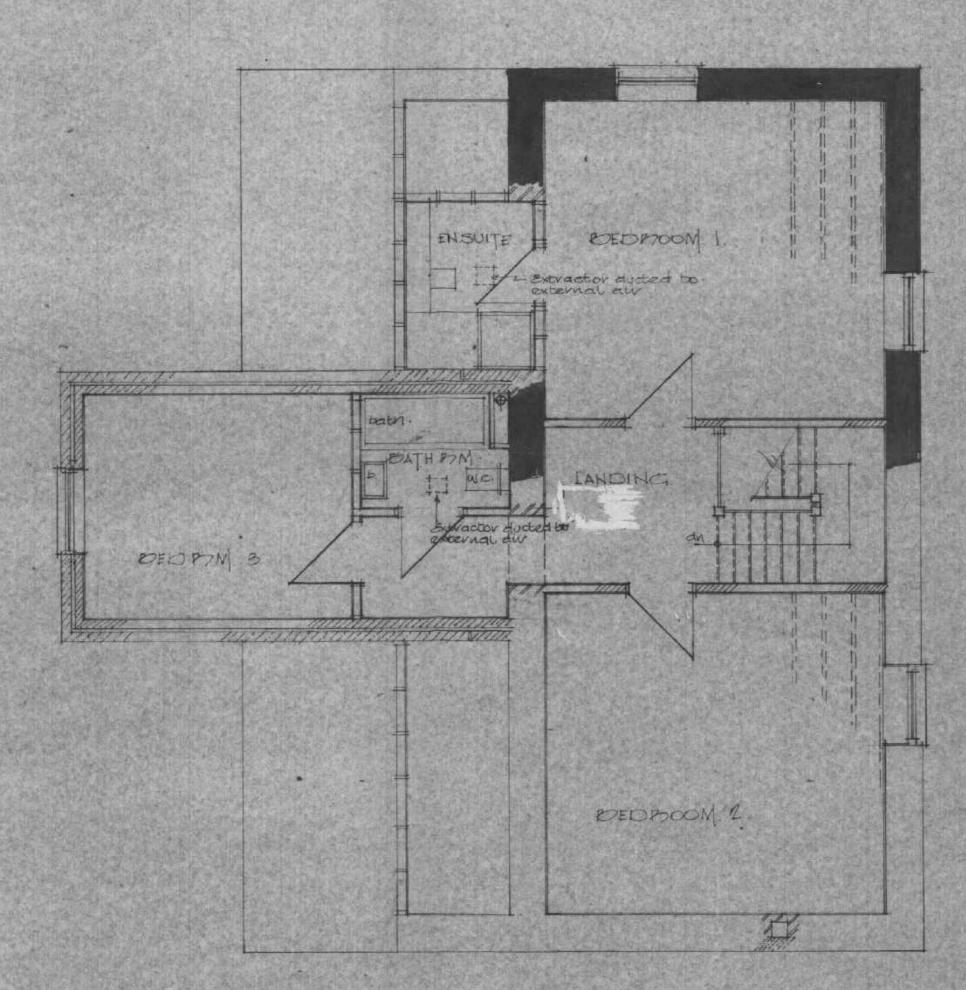


HALL MOOLS LE SIS

WALL KEY

Indicates wall demolished and rebuilt by june 17/22 1992 - stonework criticised by planners - see photographs

Indicates wall demolished june 17/22 1992

Indicates wall demolished june 17/22 1992

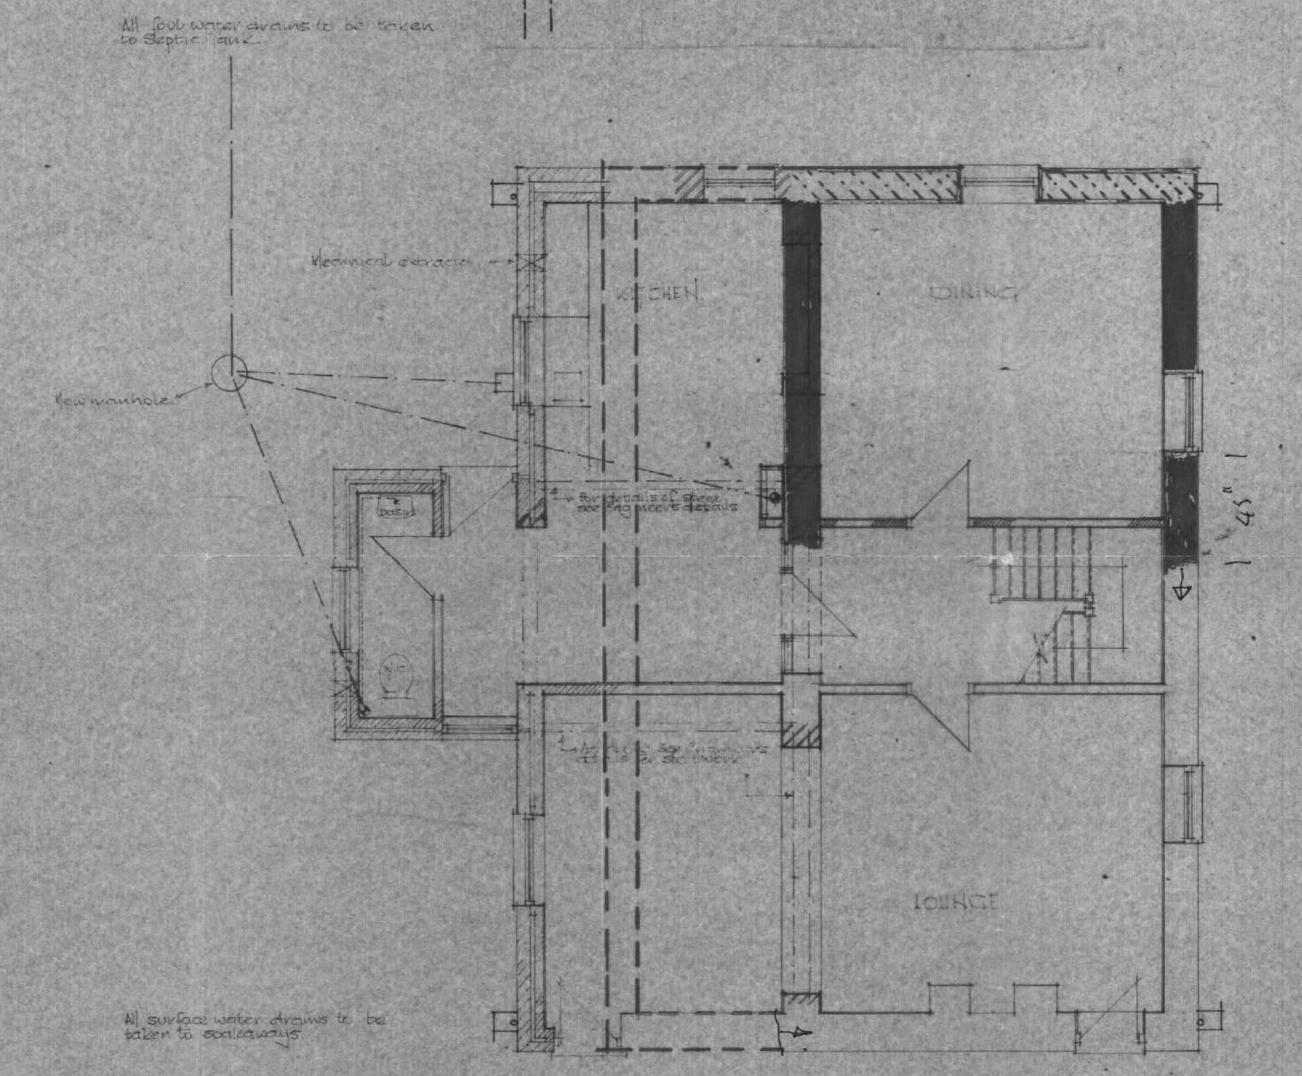

GROUND FLOOP, PLAN

PROVISIONAL CONSTRUCTION NOTES.

ALL LIGHTELS TO BE SWEETSTEEL (SEE PLAN FOR REF.) WITH MIN. ISO- END BENEINGS, DEC LAPTED OVER LINTEL,

DOM TO INTERNAL FACE OF EXTERNAL WALLS 32 -- OTPROC TAKED WRETHANE INSULATING BODING

THEOREM OF THE SAME HERES AND THE TO WINDOWS FINISH TO LA APPROVAL

REFER TO ENAMERS INFORMATION FOR SIRES TO BUILD UP OR REPLACE

EXISTING CONSTRUCTION TO BE RETRINED WHERE FOSSIBLE TOOM & HALF ROUND GUTTER WITH 75 MM DOWNAPES

TO GULLET . INTERNAL DOORS TO HAVE IZMA RESITES - 1004 SOME S.W.

MOUTURE RESISTANT WENEOC FLOORING TO BATHROOMS AND TOLLE

ON WHERE PHENOTH TO B.S. 45th BY MARLEN PLANCE (OR WHILL PARTIED)

40mm DIR. BATH WASTES , 32- DIR BASH WARTES

100 - SOIL STACK TO TERRIBUTE 900- AGOIS WINDOW HERD, WITH DURRBLE PLANTE COWL WASTE PIPE BUCERS 17-

394 ME VOWILLEWER SVB SOIL VENT THE

EVINACTION -TO EXTRACT MIN. 60 L SECONO. (XPELAIR WKG OR EGUAL) BATHROOMS TO HAVE ING ESTRACT FAN TO EXTRACT MIN 15 L SECOND INTERMITTENON. (XPELNIR LINE OR EQUIL WITH DIZO DELAY) . W.C. TO HAVE IND ENTRACTOR PAN TO EXTRACT AT 3 MIR CHANGES PER HOUR INTERMITTERING WITH ISMIN.

DVER RUN. ( APENIA DX100 HA OR EGIAL)




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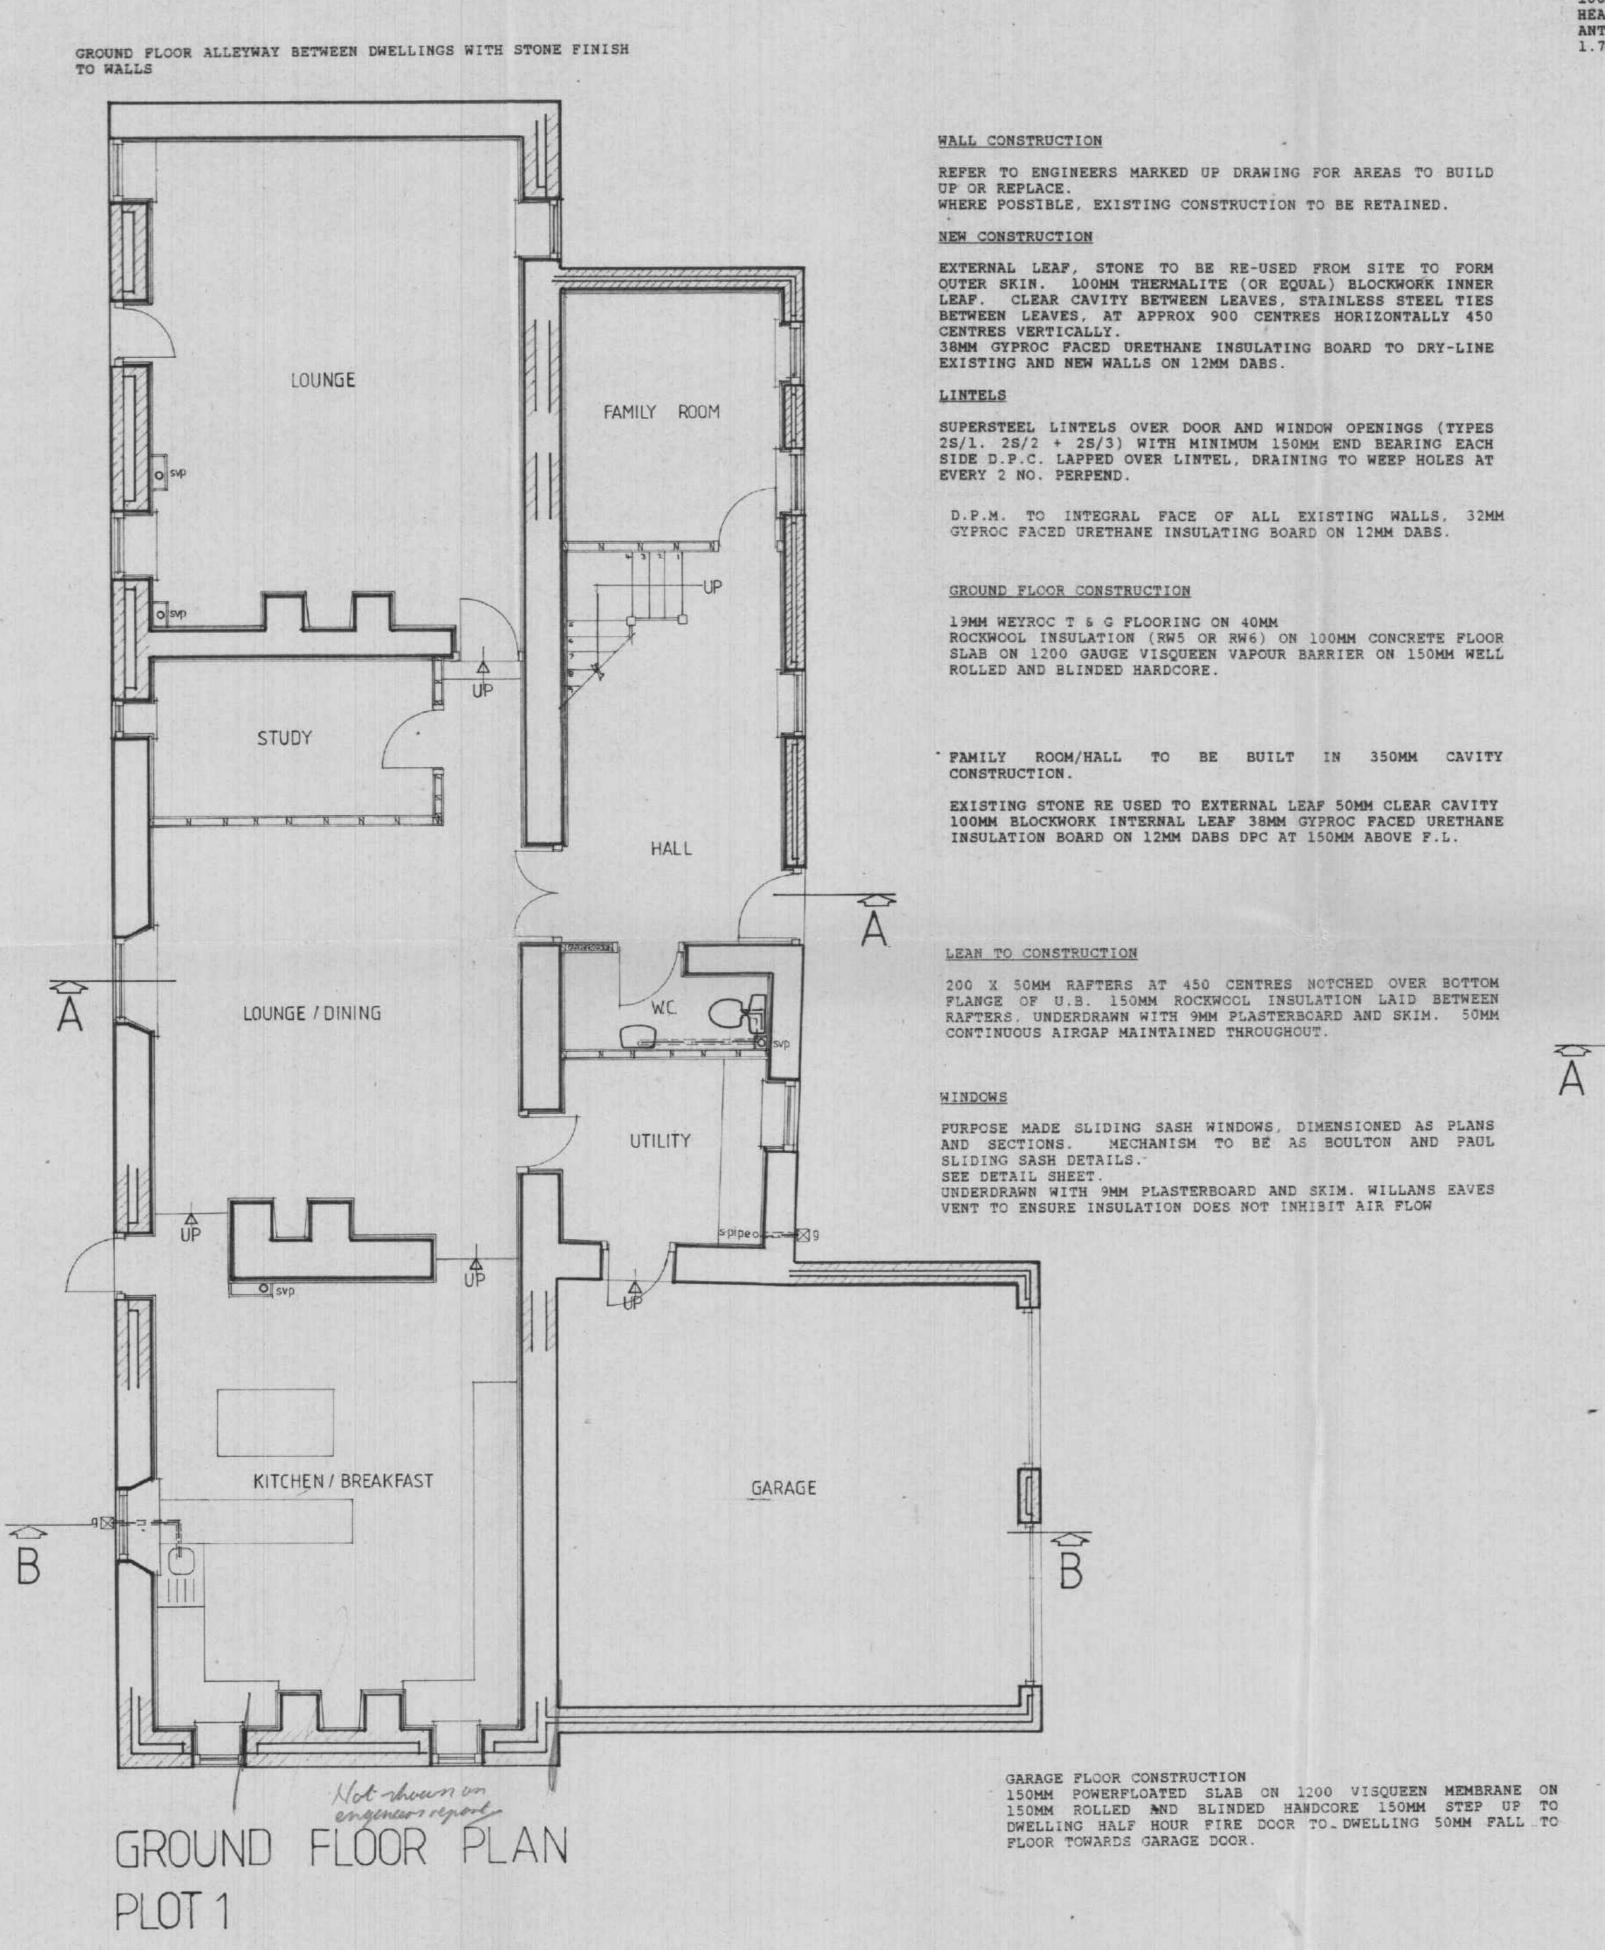
MOUNT HOUSE OFFICE, SPRINGWELL, GATESHEAD, NE9 741

Tel .091) 416 0777

PROPOSED


475 /03 A



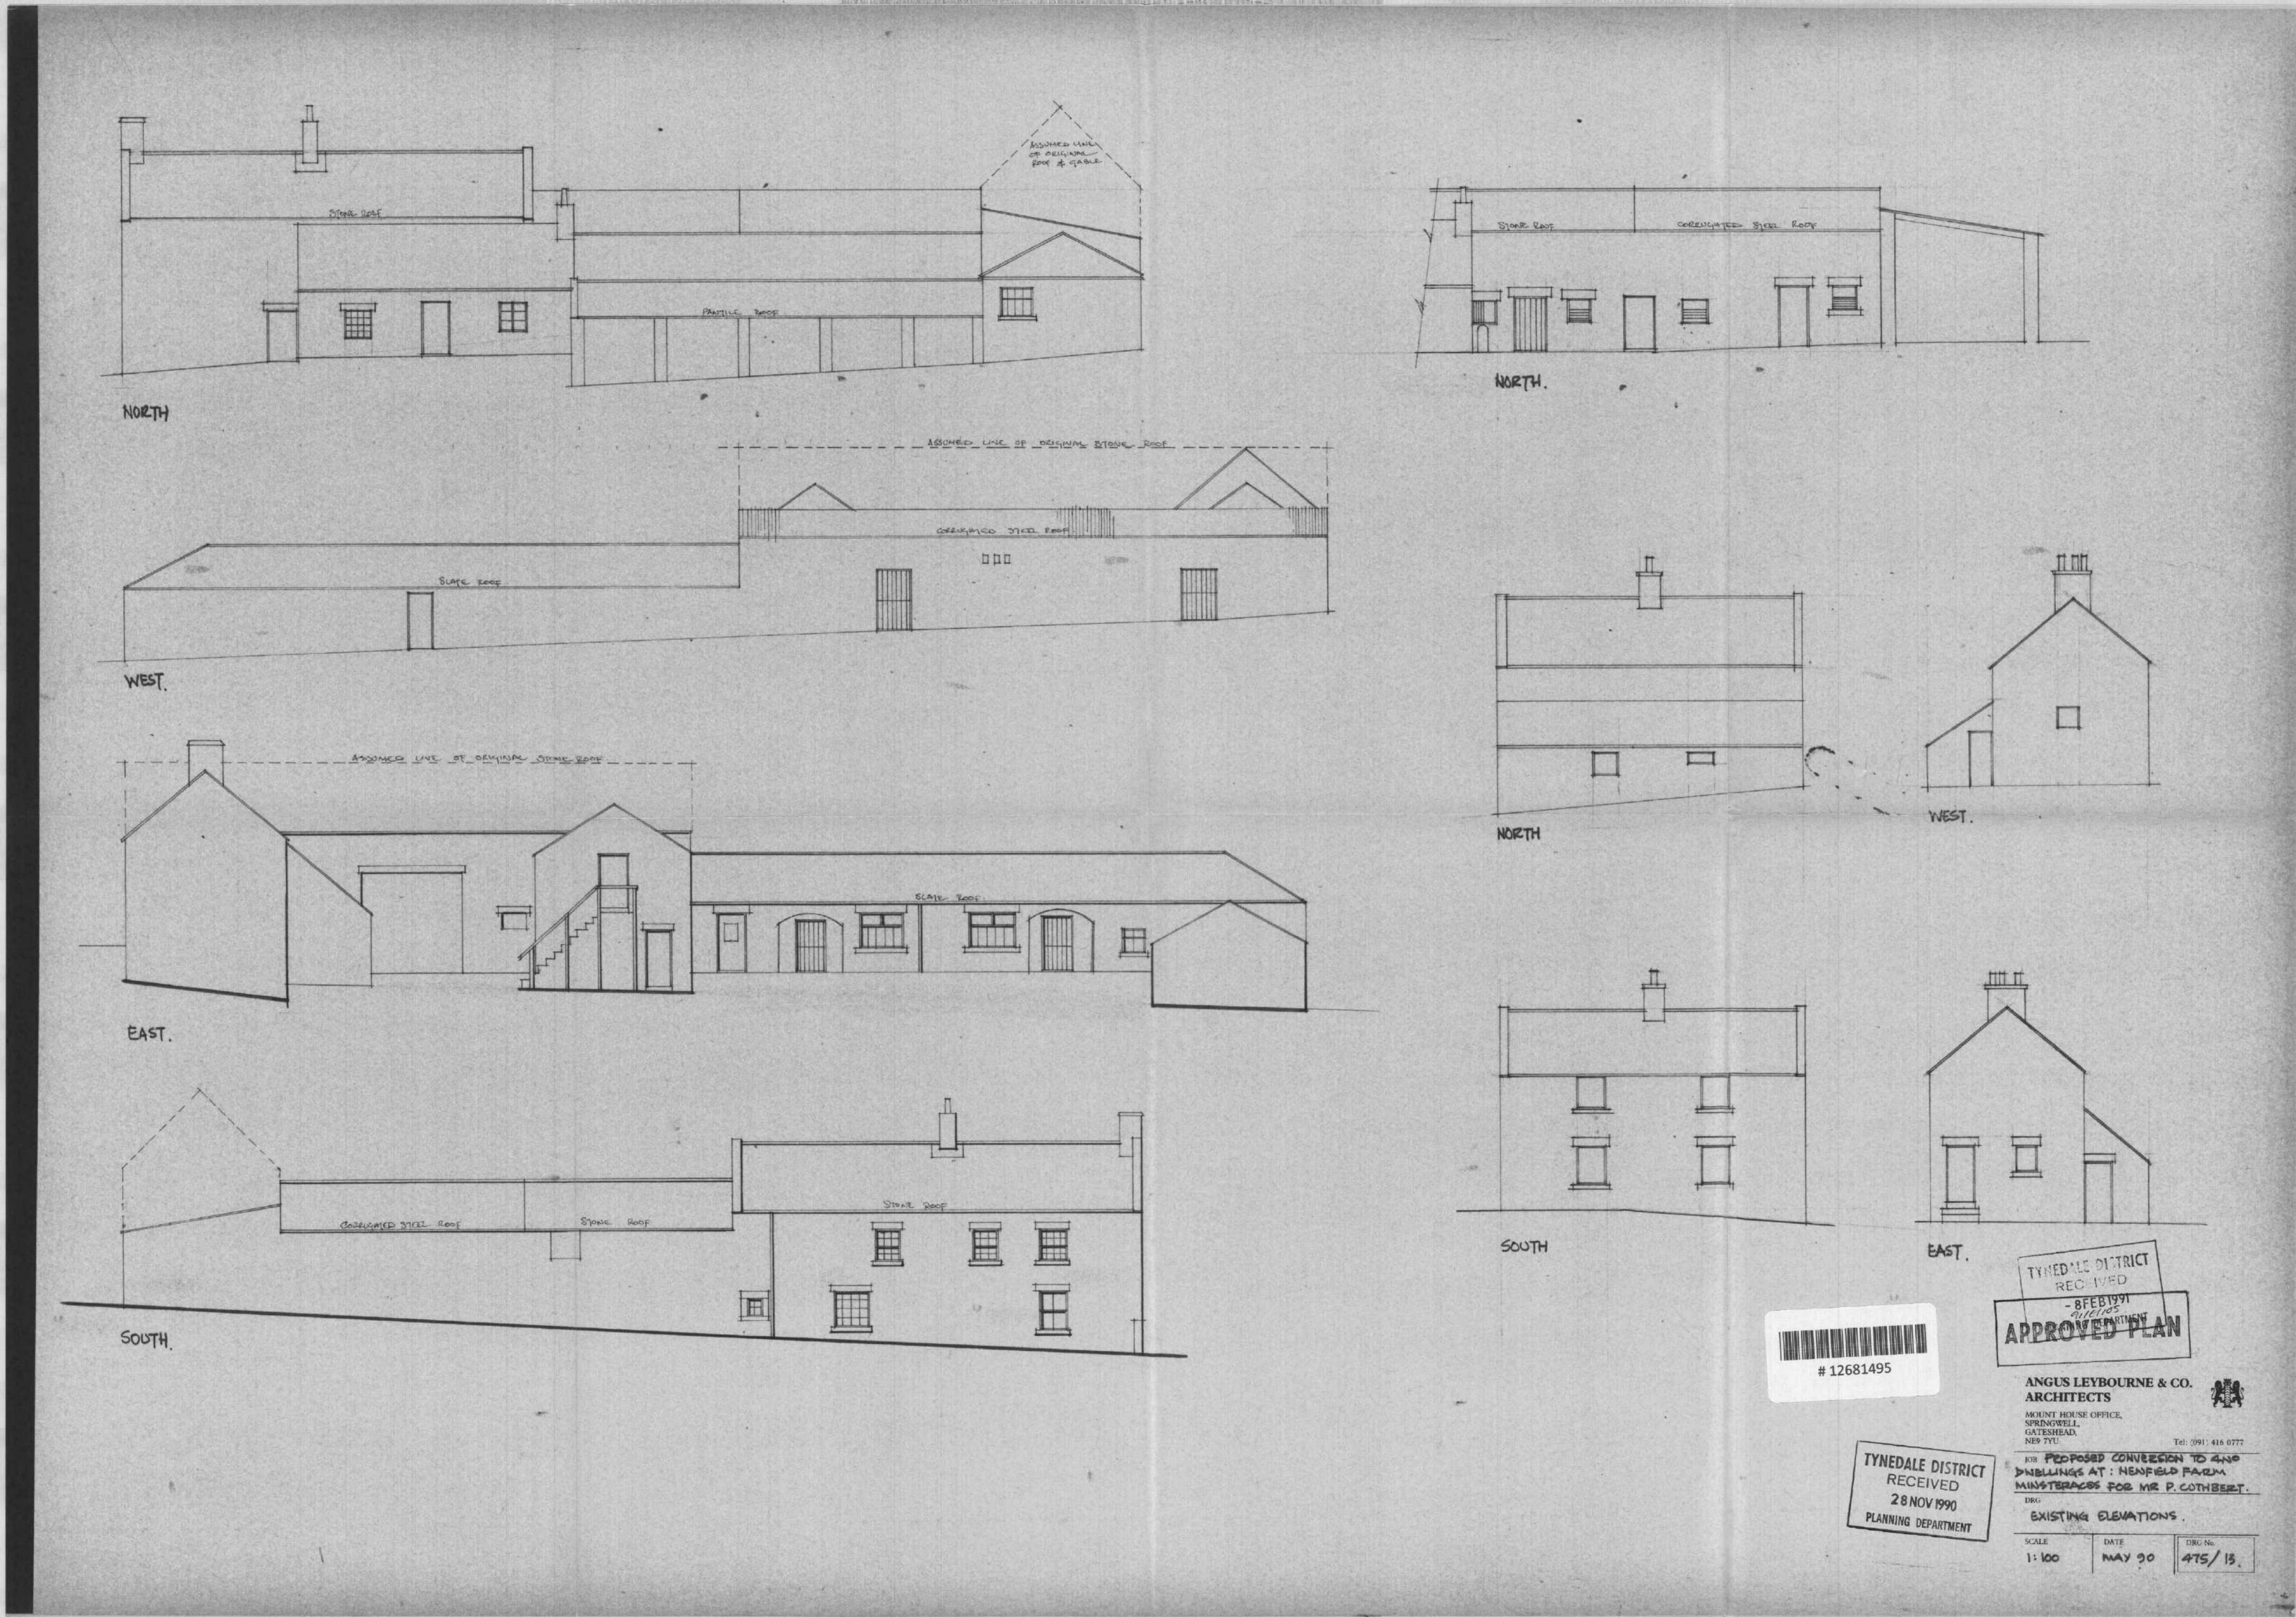

ALL WASTE PIPES TO BE U.P.V.C. ALL FITTINGS TO HAVE 75MM DEEP SEAL TRAPS ON WASTE PIPEWORK TO B.S. 4514 BY MARLEY PLASTICS (OR SIMILAR). 40MM DIAMETER BATH WASTES, 32MM DIA. BASIN WASTES. WASHING MACHINE TO HAVE 40MM DIA 750MM HIGH STANDPIPE 40MM DIA WASTE TO SINK AND TO SHOWER TRAYS. 100MM DIA. SOIL STACK TO TERMINATE 900MM ABOVE WINDOW ANTI VACCUUM TRAPS TO WASH BASIN WHERE WASTE PIPE EXCEED

HEAD, WITH DURABLE PLASTIC COWL.

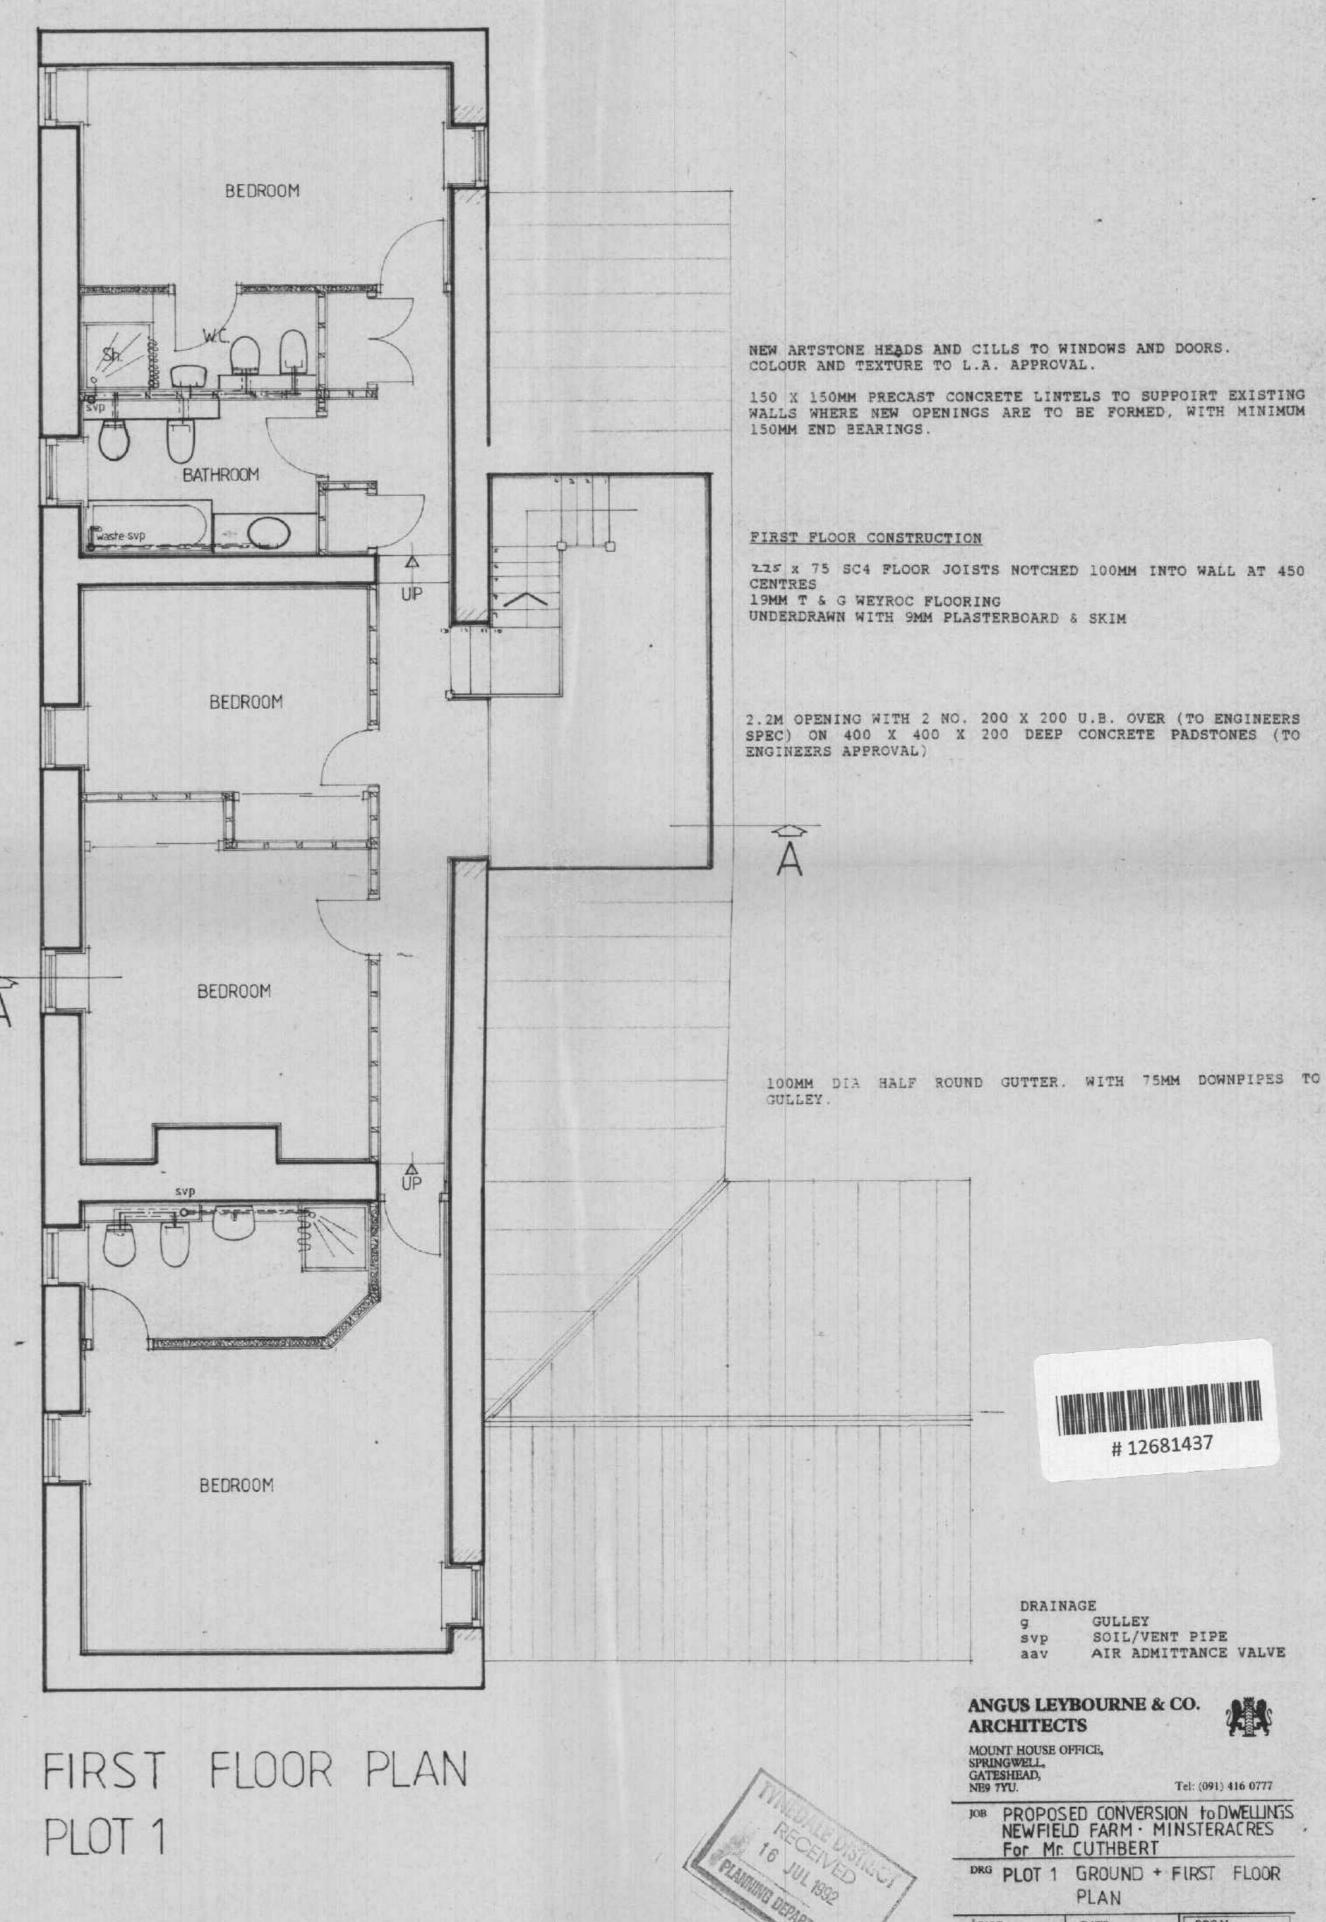

475 / 21

July 91

ROOF CONSTRUCTION

Proprieatory trussed rafters at 450 centres to Engineers design on 100 x 75mm wallplate.

38 x 25mm tanalised battens at required guage on untearable sarking felt.

M.S. Holding down straps at 1.8m centres to wallplate.

M.S. gable anchor straps to gables to first two rafters at 1.8m centres.

Longitudnal, diagonal and ceiling tie bracing as BS 5268 Part 3 1985

WINDOWS PURPOSE MADE SLIDING SASH WINDOWS, DIMENSIONED AS PLANS AND SECTIONS. MECHANISM TO BE AS BOULTON AND PAUL SLIDING SASH DETAILS. SEE DETAIL SHEET. 100MM DIA HALF ROUND GUTTER, WITH 75MM DOWNPIPES TO STATES SERVING COMPANY HIPPED ROOF TO PORCH, WITH 200 X 50MM HIP RAFTERS AND INTERMEDIATE RAFTERS ON 100 X 75MM WALL PLATE 100 X 50MM JANES AND STATES OF THE STATES MANASA MA CEILING TIES WITH 9MM PLASTERBOARD AND SKIM TO CEILING. FIRST FLOOR CONSTRUCTION 200 x 75 SC4 FLOOR JOISTS NOTCHED LOCMM INTO WALL AT 450 19MM T & G WEYROC FLOORING 150 X 150MM PRECAST CONCRETE LINTELS TO SUPPCIRT EXISTING UNDERDRAWN WITH 9MM PLASTERBOARD & SKIM WALLS WHERE NEW OPENINGS ARE TO BE FORMED. WITH MINIMUM 150MM END BEARINGS. # 12681411 The other states of the state o 150 X 150MM ARTSTONE HEADS TO WINDOWS OF PORCH PURPOSE MADE SLIDING SASH WINDOWS WITH 150MM ARTSTONE CILLS WALL CONSTRUCTION REFER TO ENGINEERS MARKED UP DRAWING FOR AREAS TO BUILD UP OR REPLACE. WHERE POSSIBLE, EXISTING CONSTRUCTION TO BE RETAINED. SECTION AA GROUND FLOOR CONSTRUCTION

PLOT 2

STONE COPINGS TO ROOF GABLE TO BE RE USED.

### NEW CONSTRUCTION

EXTERNAL LEAF, STONE TO BE RE-USED FROM SITE TO FORM OUTER SKIN. 100MM THERMALITE (OR EQUAL) BLOCKWORK INNER LEAF. CLEAR CAVITY BETWEEN LEAVES, STAINLESS STEEL TIES BETWEEN LEAVES, AT APPROX 900 CENTRES HORIZONTALLY 450 CENTRES VERTICALLY. 38MM GYPROC FACED URETHANE INSULATING BOARD TO DRY-LINE EXISTING AND NEW WALLS ON 12MM DABS.

# LINTELS

SUPERSTEEL LINTELS OVER DOOR AND WINDOW OPENINGS (TYPES 28/1. 28/2 + 28/3) WITH MINIMUM 150MM END BEARING EACH SIDE D.P.C. LAPPED OVER LINTEL, DRAINING TO WEEP HOLES AT EVERY 2 NO. PERPEND.

D.P.M. TO INTEGRAL FACE OF ALL EXISTING WALLS, 32MM GYPROC FACED URETHANE INSULATING BOARD ON 12MM DABS.

PLOT 2

19MM WEYROC T & G FLOORING ON 40MM ROCKWOOL INSULATION (RWS OR RW6) ON 100MM CONCRETE FLOOR SLAB ON 1200 GAUGE VISQUEEN VAPOUR BARRIER ON 150MM WELL ROLLED AND BLINDED HARDCORE.

NEW ARTSTONE HEADS AND CILLS TO WINDOWS AND DOORS.

COLOUR AND TEXTURE TO L.A. APPROVAL.

ALL WASTE PIPES TO BE U.P.V.C. ALL FITTINGS TO HAVE 75MM DEEP SEAL TRAPS ON WASTE PIPEWORK TO B.S. 4514 BY MARLEY PLASTICS (OR SIMILAR).

40MM DIAMETER BATH WASTES, 32MM DIA. BASIN WASTES. WASHING MACHINE TO HAVE 40MM DIA 750MM HIGH STANDPIPE 40MM DIA WASTE TO SINK AND TO SHOWER TRAYS. 100MM DIA. SOIL STACK TO TERMINATE 900MM ABOVE WINDOW HEAD, WITH DURABLE PLASTIC COWL. ANTI VACCUUM TRAPS TO WASH BASIN WHERE WASTE PIPE EXCEED

ANGUS LEYBOURNE & CO. ARCHITECTS

MOUNT HOUSE OFFICE, SPRINGWELL. GATESHEAD.

PROPOSED CONVERSION to DWELLINGS NEW FIELD FARM - MINSTERACRES


For Mr. CUTHBERT DRG PLOT 2, SECTION AA+BB

DATE July 91 475 / 27 ALL WASTE PIPES TO BE U.P.V.C. ALL FITTINGS TO HAVE 75MM DEEP SEAL TRAPS ON WASTE PIPEWORK TO B.S. 4514 BY MARLEY PLASTICS (OR SIMILAR).

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ANTI VACCUUM TRAPS TO WASH BASIN WHERE WASTE PIPE EXCEED 1.7M



GROUND FLOOR PLAN
PLOT 2
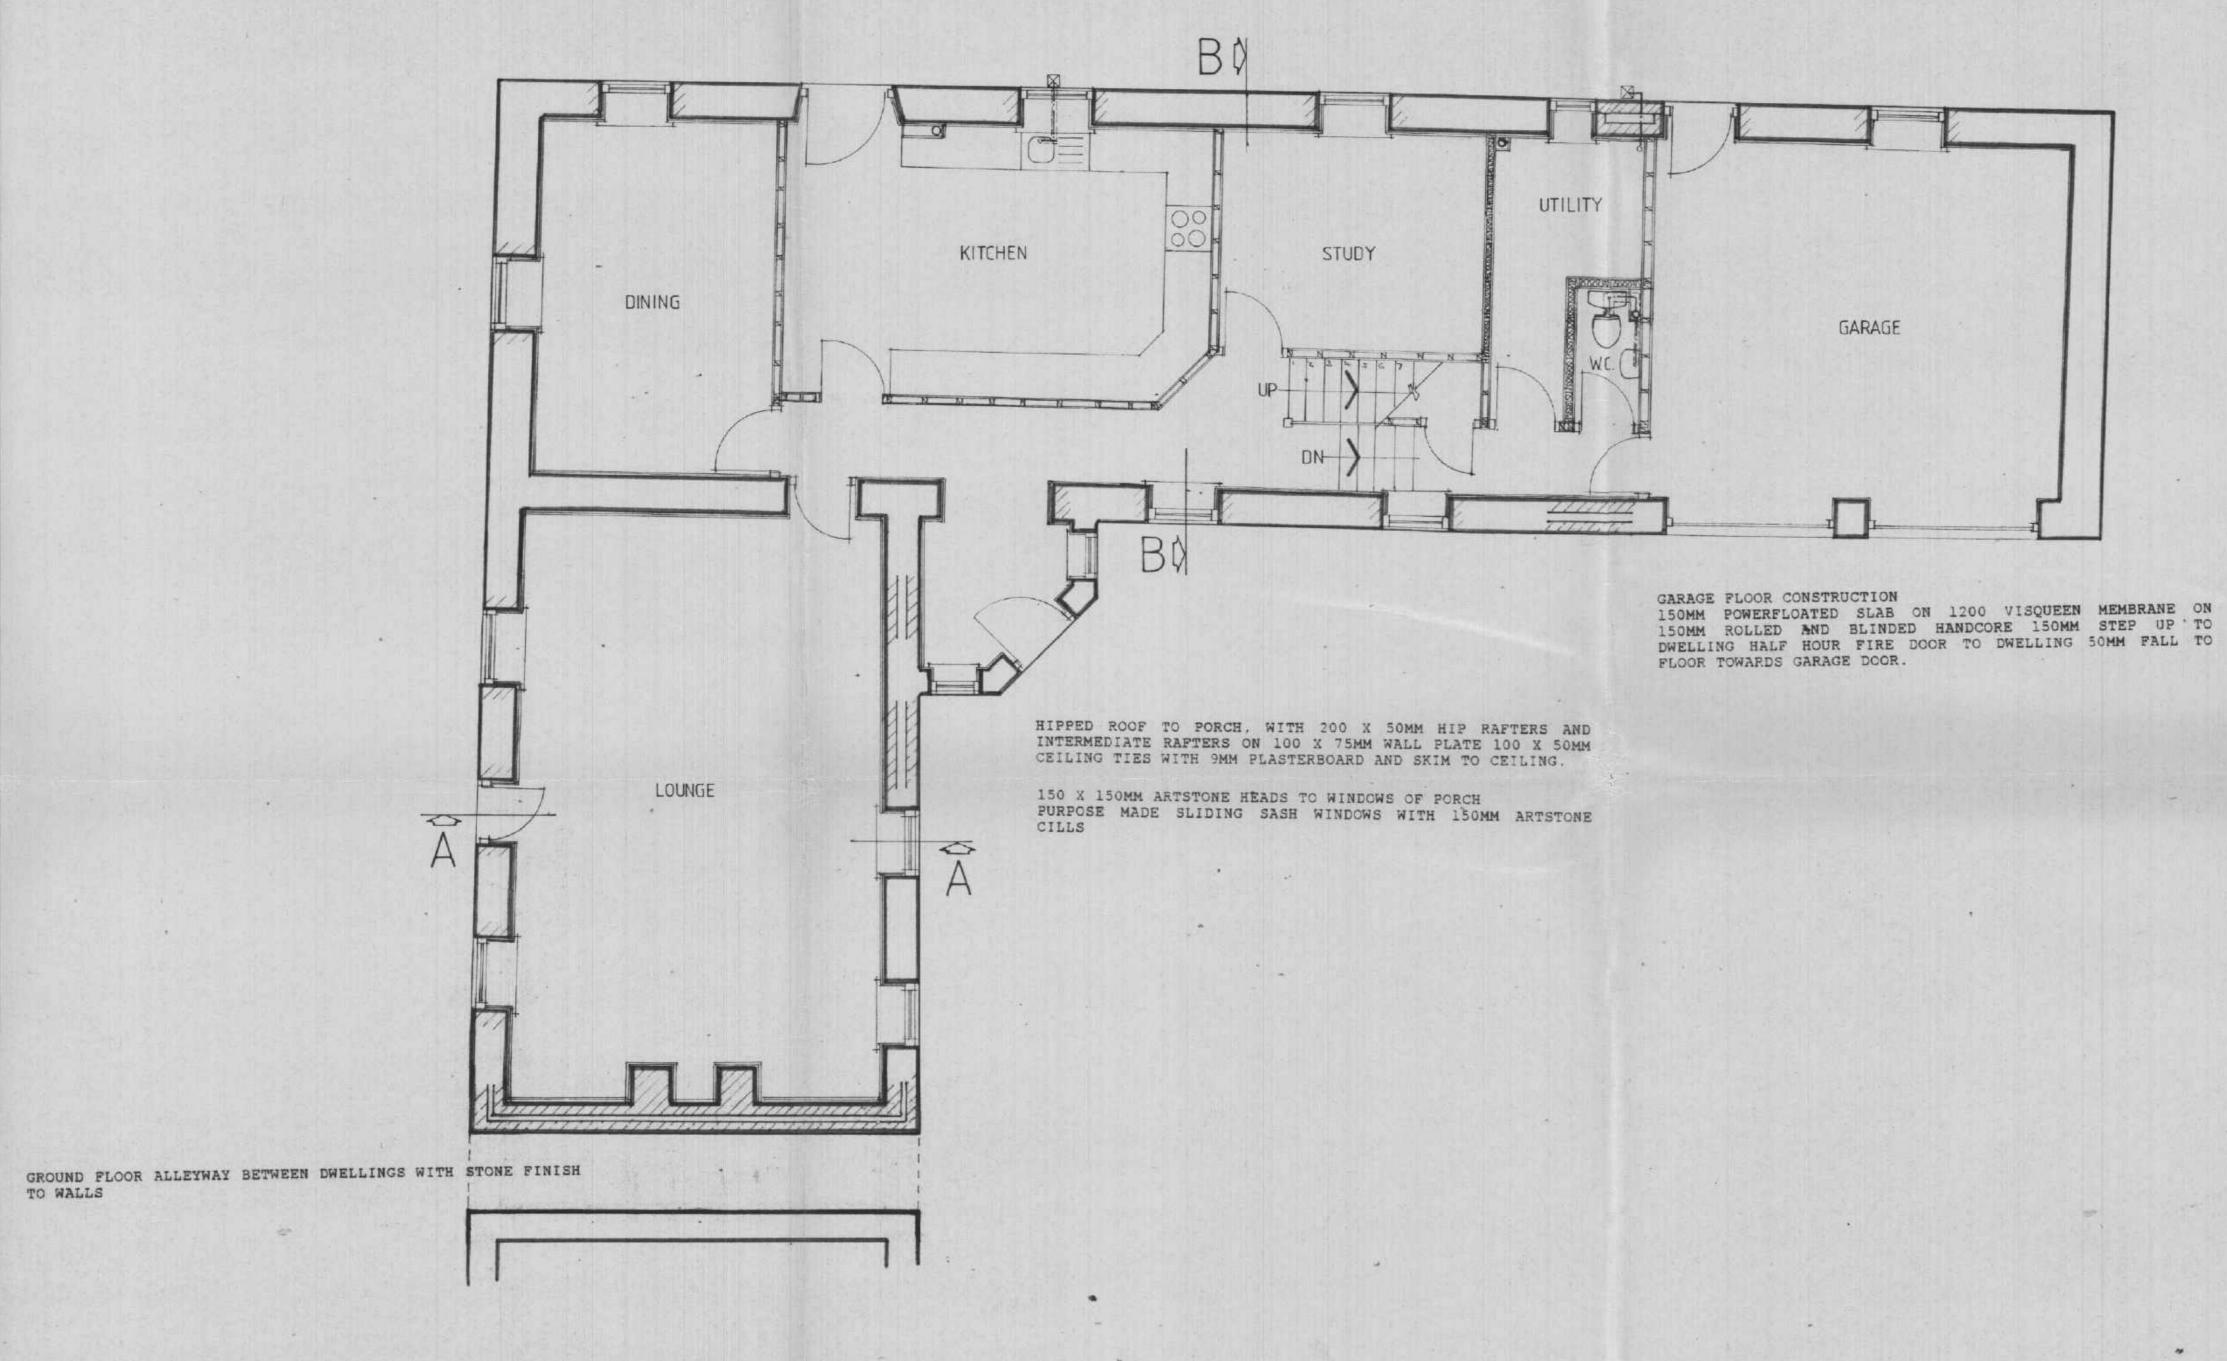
### GROUND FLOOR CONSTRUCTION

19MM WEYROC T & G FLOORING ON 40MM
ROCKWOOL INSULATION (RW5 OR RW6) ON 100MM CONCRETE FLOOR
SLAB ON 1200 GAUGE VISQUEEN VAPOUR BARRIER ON 150MM WELL
ROLLED AND BLINDED HARDCORE.

#### WALL CONSTRUCTION

REFER TO ENGINEERS MARKED UP DRAWING FOR AREAS TO BUILD UP OR REPLACE.
WHERE POSSIBLE, EXISTING CONSTRUCTION TO BE RETAINED.

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38MM GYPROC FACED URETHANE INSULATING BOARD TO DRY-LINE EXISTING AND NEW WALLS ON 12MM DABS.

### LINTELS

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### WINDOWS

PURPOSE MADE SLIDING SASH WINDOWS, DIMENSIONED AS PLANS AND SECTIONS. MECHANISM TO BE AS BOULTON AND PAUL SLIDING SASH DETAILS.
SEE DETAIL SHEET.

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NEW ARTSTONE HEADS AND CILLS TO WINDOWS AND DOORS. COLOUR AND TEXTURE TO L.A. APPROVZL.



DRAINAGE

GULLEY

SVP SOIL/VENT PIPE

aav AIR ADMITTANCE VALVE



ANGUS LEYBOURNE & CO.
ARCHITECTS
MOUNT HOUSE OFFICE

MOUNT HOUSE OFFICE, SPRINGWELL, GATESHEAD, NEG 7YII

PROPOSED CONVERSION to DWELLINGS
NEWFIELD FARM · MINSTERACRES
FOR Mr. CUTHBERT


DRG PLOT 2 GROUND FLOOR PLAN

50 DATE DRG No. 475 / 22

-Become the companies of the companies of the manner manner of the companies of the compan FIRST FLOOR CONSTRUCTION

200 x 75 SC4 FLOOR JOISTS NOTCHED 100MM INTO WALL AT 450 19MM T & G WEYROC FLOORING UNDERDRAWN WITH 9MM PLASTERBOARD & SKIM

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FIRST FLOOR PLAN PLOT 2
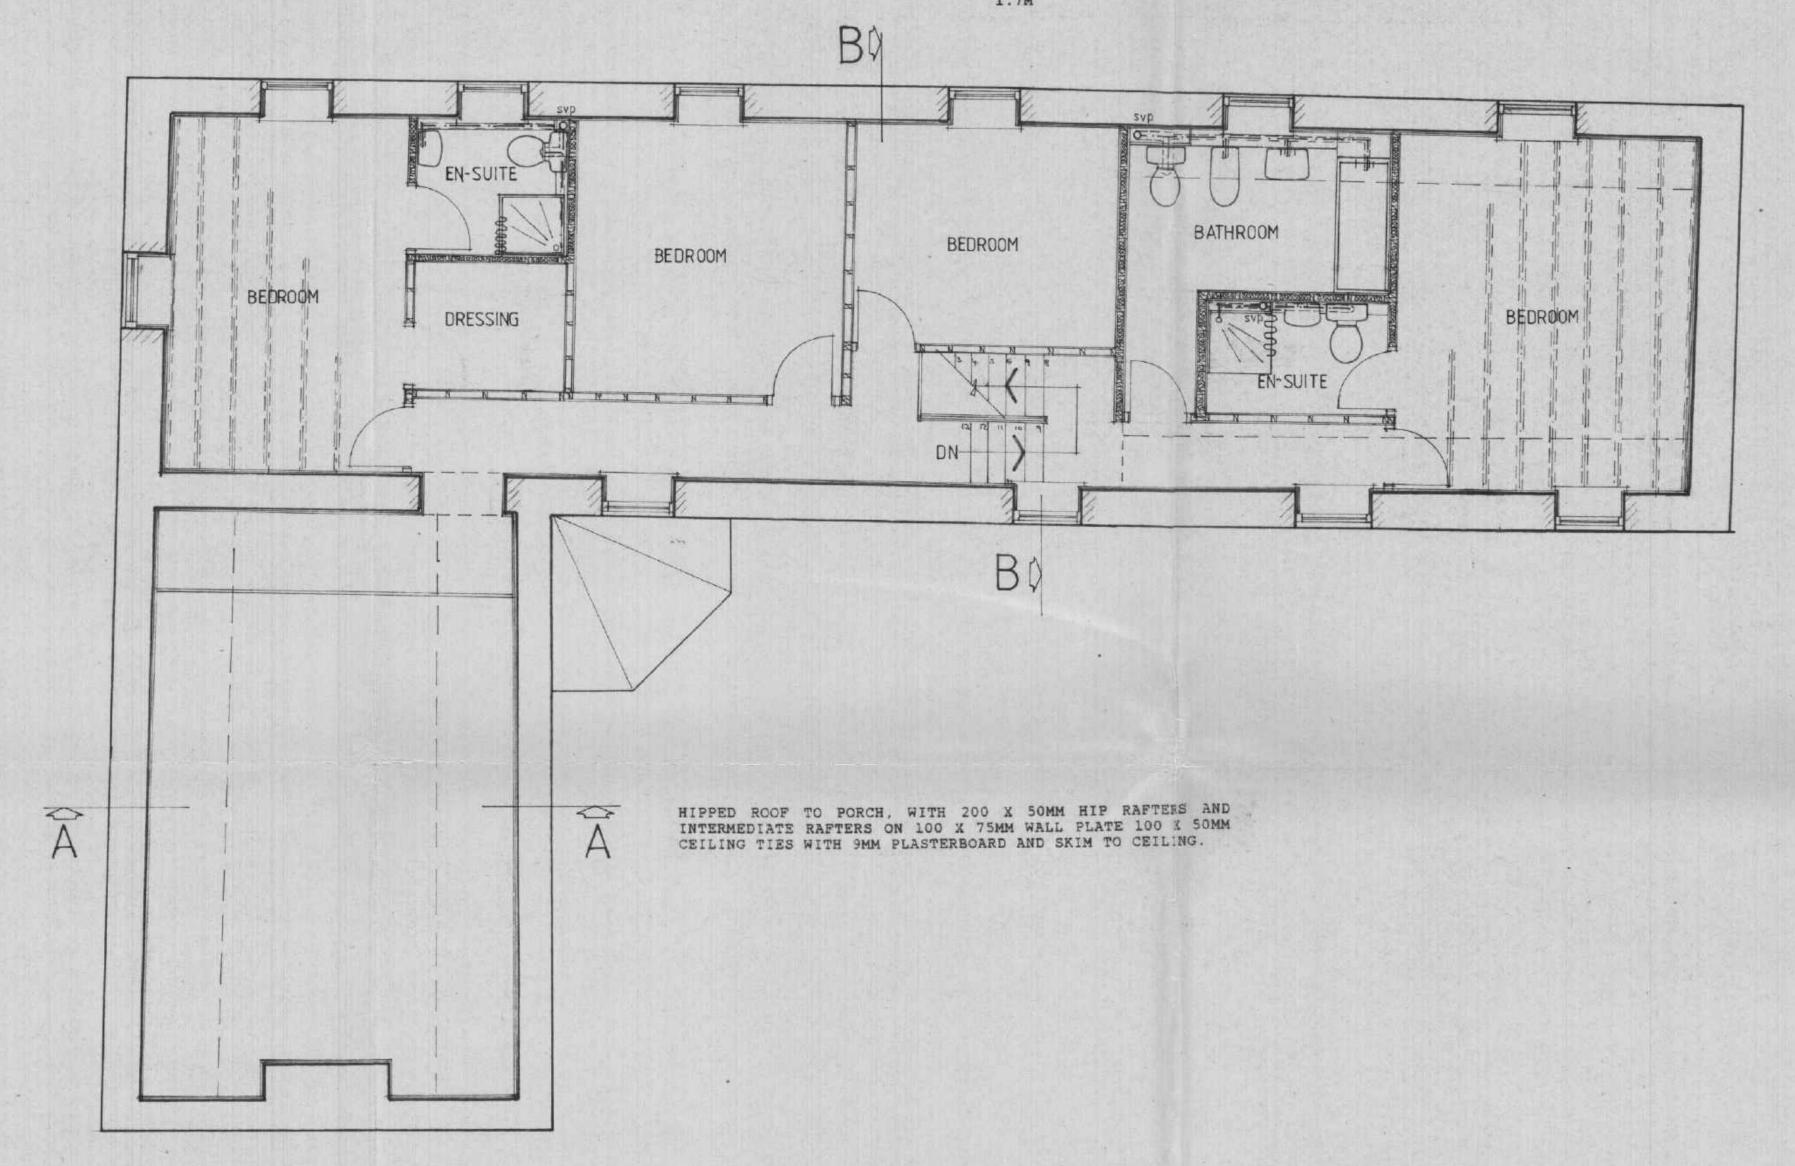
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### LINTELS

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150 X 150MM ARTSTONE HEADS TO WINDOWS OF PORCH PURPOSE MADE SLIDING SASH WINDOWS WITH 150MM ARTSTONE

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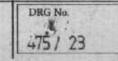
DRAINAGE g GULLEY
svp SOIL/VENT PIPE
aav AIR ADMITTANCE VALVE


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ARCHITECTS

Tel: (091) 416 0777 PROPOSED CONVERSION to DWELLINGS
NEWFIELD FARM · MINSTERACRES
FOR Mr. CUTHBERT

DRG PLOT 2, FIRST FLOOR PLAN

July 91



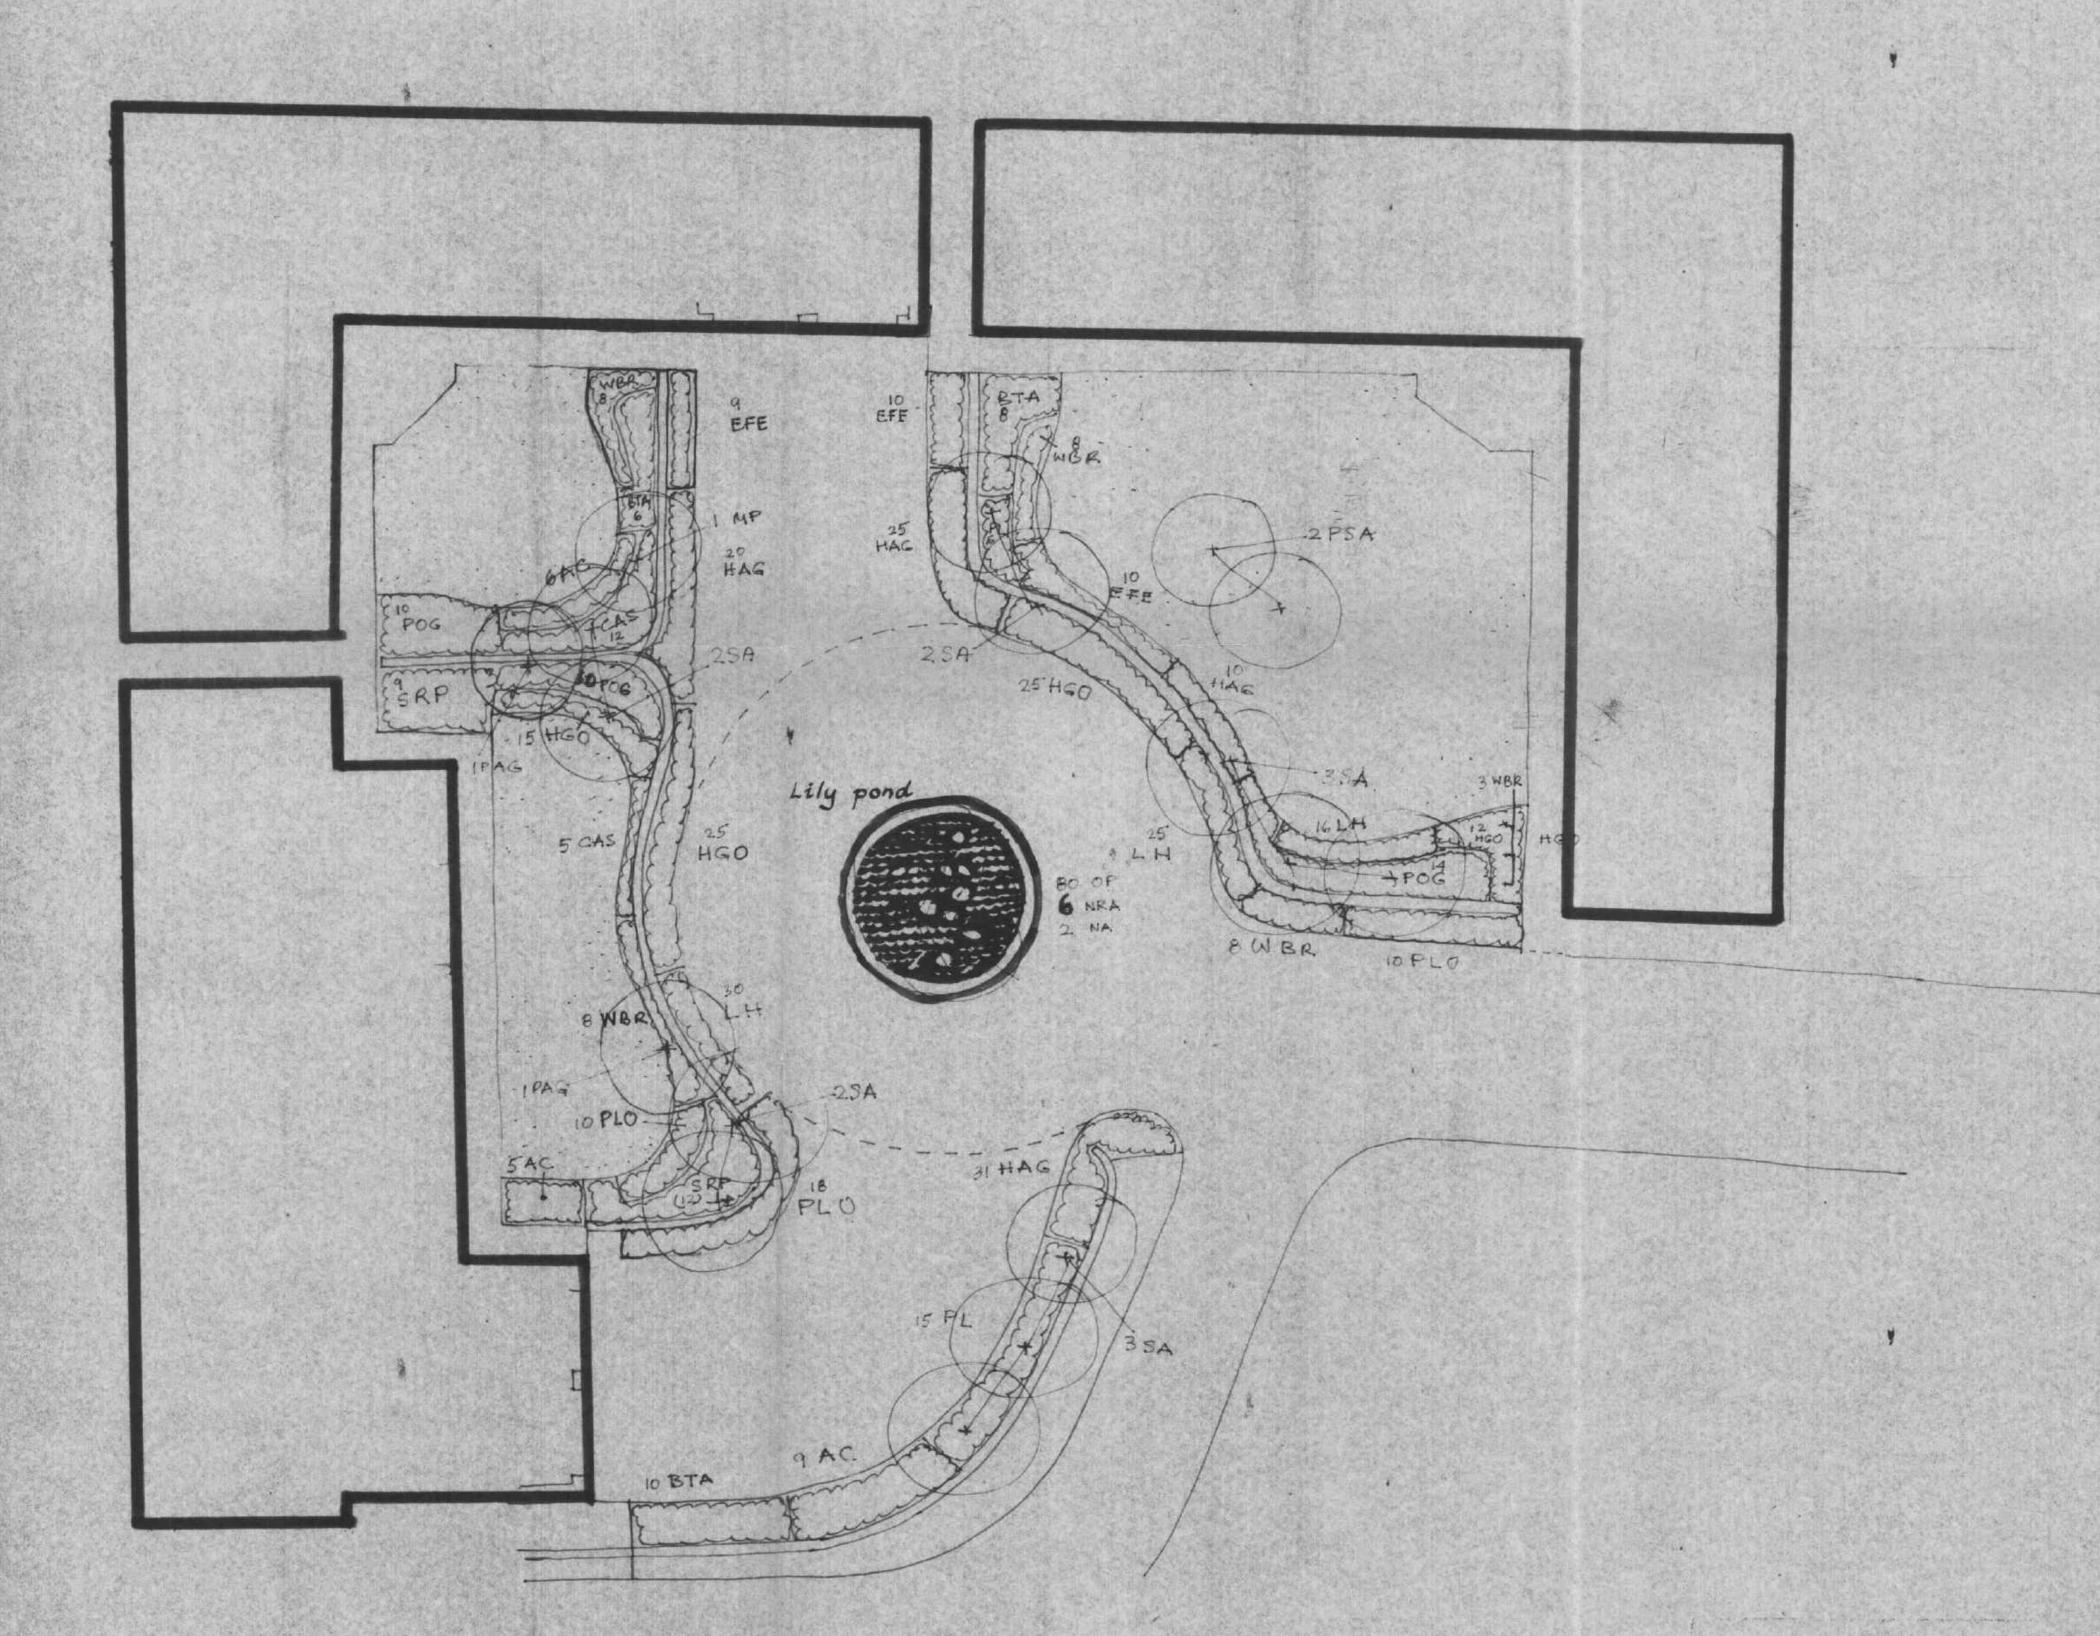

# TREE PLANTING


Key			SIZE.		NOS
SA	Sorbus	aucuparia	2 -3m	standards	12
MP	Malus	Profusion	2-00	standard	
PSA	Prunus	subhirtellu Autumnalis'	1-3m	slandards	_
PAG	Pranus	'Ama no Gawa'	3-4m	standurib	2


# SHRUB PLANTING

		EIZE	MOS ME	NOS.
AC	Amaldnchier conddensis	450 - 600 mm pot	1.5	20
BTA	Berberis thunbergit Authopurpur	-, 600-900 mm pot	2	24
CSA	Cornus alba 'Silirira'		2	17
EFE	Euonymus fortunii Emeralde	mety 300-450 mmpct	4	29
HAG	Hebe Autumn Gloru'	300 - 450mm pct	5	86
HGO	Hebe Great Came	300 - ASC mm port	A	77
LH	Lavandula Hideote	200 - 300 mm pot	٤	71
PL	Prunus laurocerasus	600 - 900 mm pot	2	21
PLO.	Prunus laurocerasus Ctto	Lyken' 300-450 mmpot	3	38
P06	Pyracantha 'Crange Glow'	450 - 600 mm pet	2.	24
SRP	Sambucus racemosa	600 - 900 mm	2.	21
WBR	Weigela. 'Bristol Rubu'	450 - 600 mm pct	3	35

# AQUATIC PLANTING

OP	Oxygenating	Plants: bunches of unrocted	80
NRA	Nymphaea	'Rose Arey'	6
NA	Nymphaea	`alba'	2

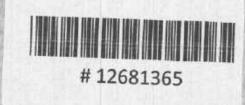

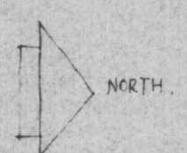

NEWFIELD FARM: MINSTERACES

LANDSCAPE PLAN SCALE 1: 100 AUG 1991


PLAN NO EDP / 918 / 1





ENVIRONMENTAL PARTNERSHIR
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Tel Tyneside: 091 230 1900
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Landscape Architects
Chartered Town Planners
Urban Designers
Reclamation and
Development Consultants

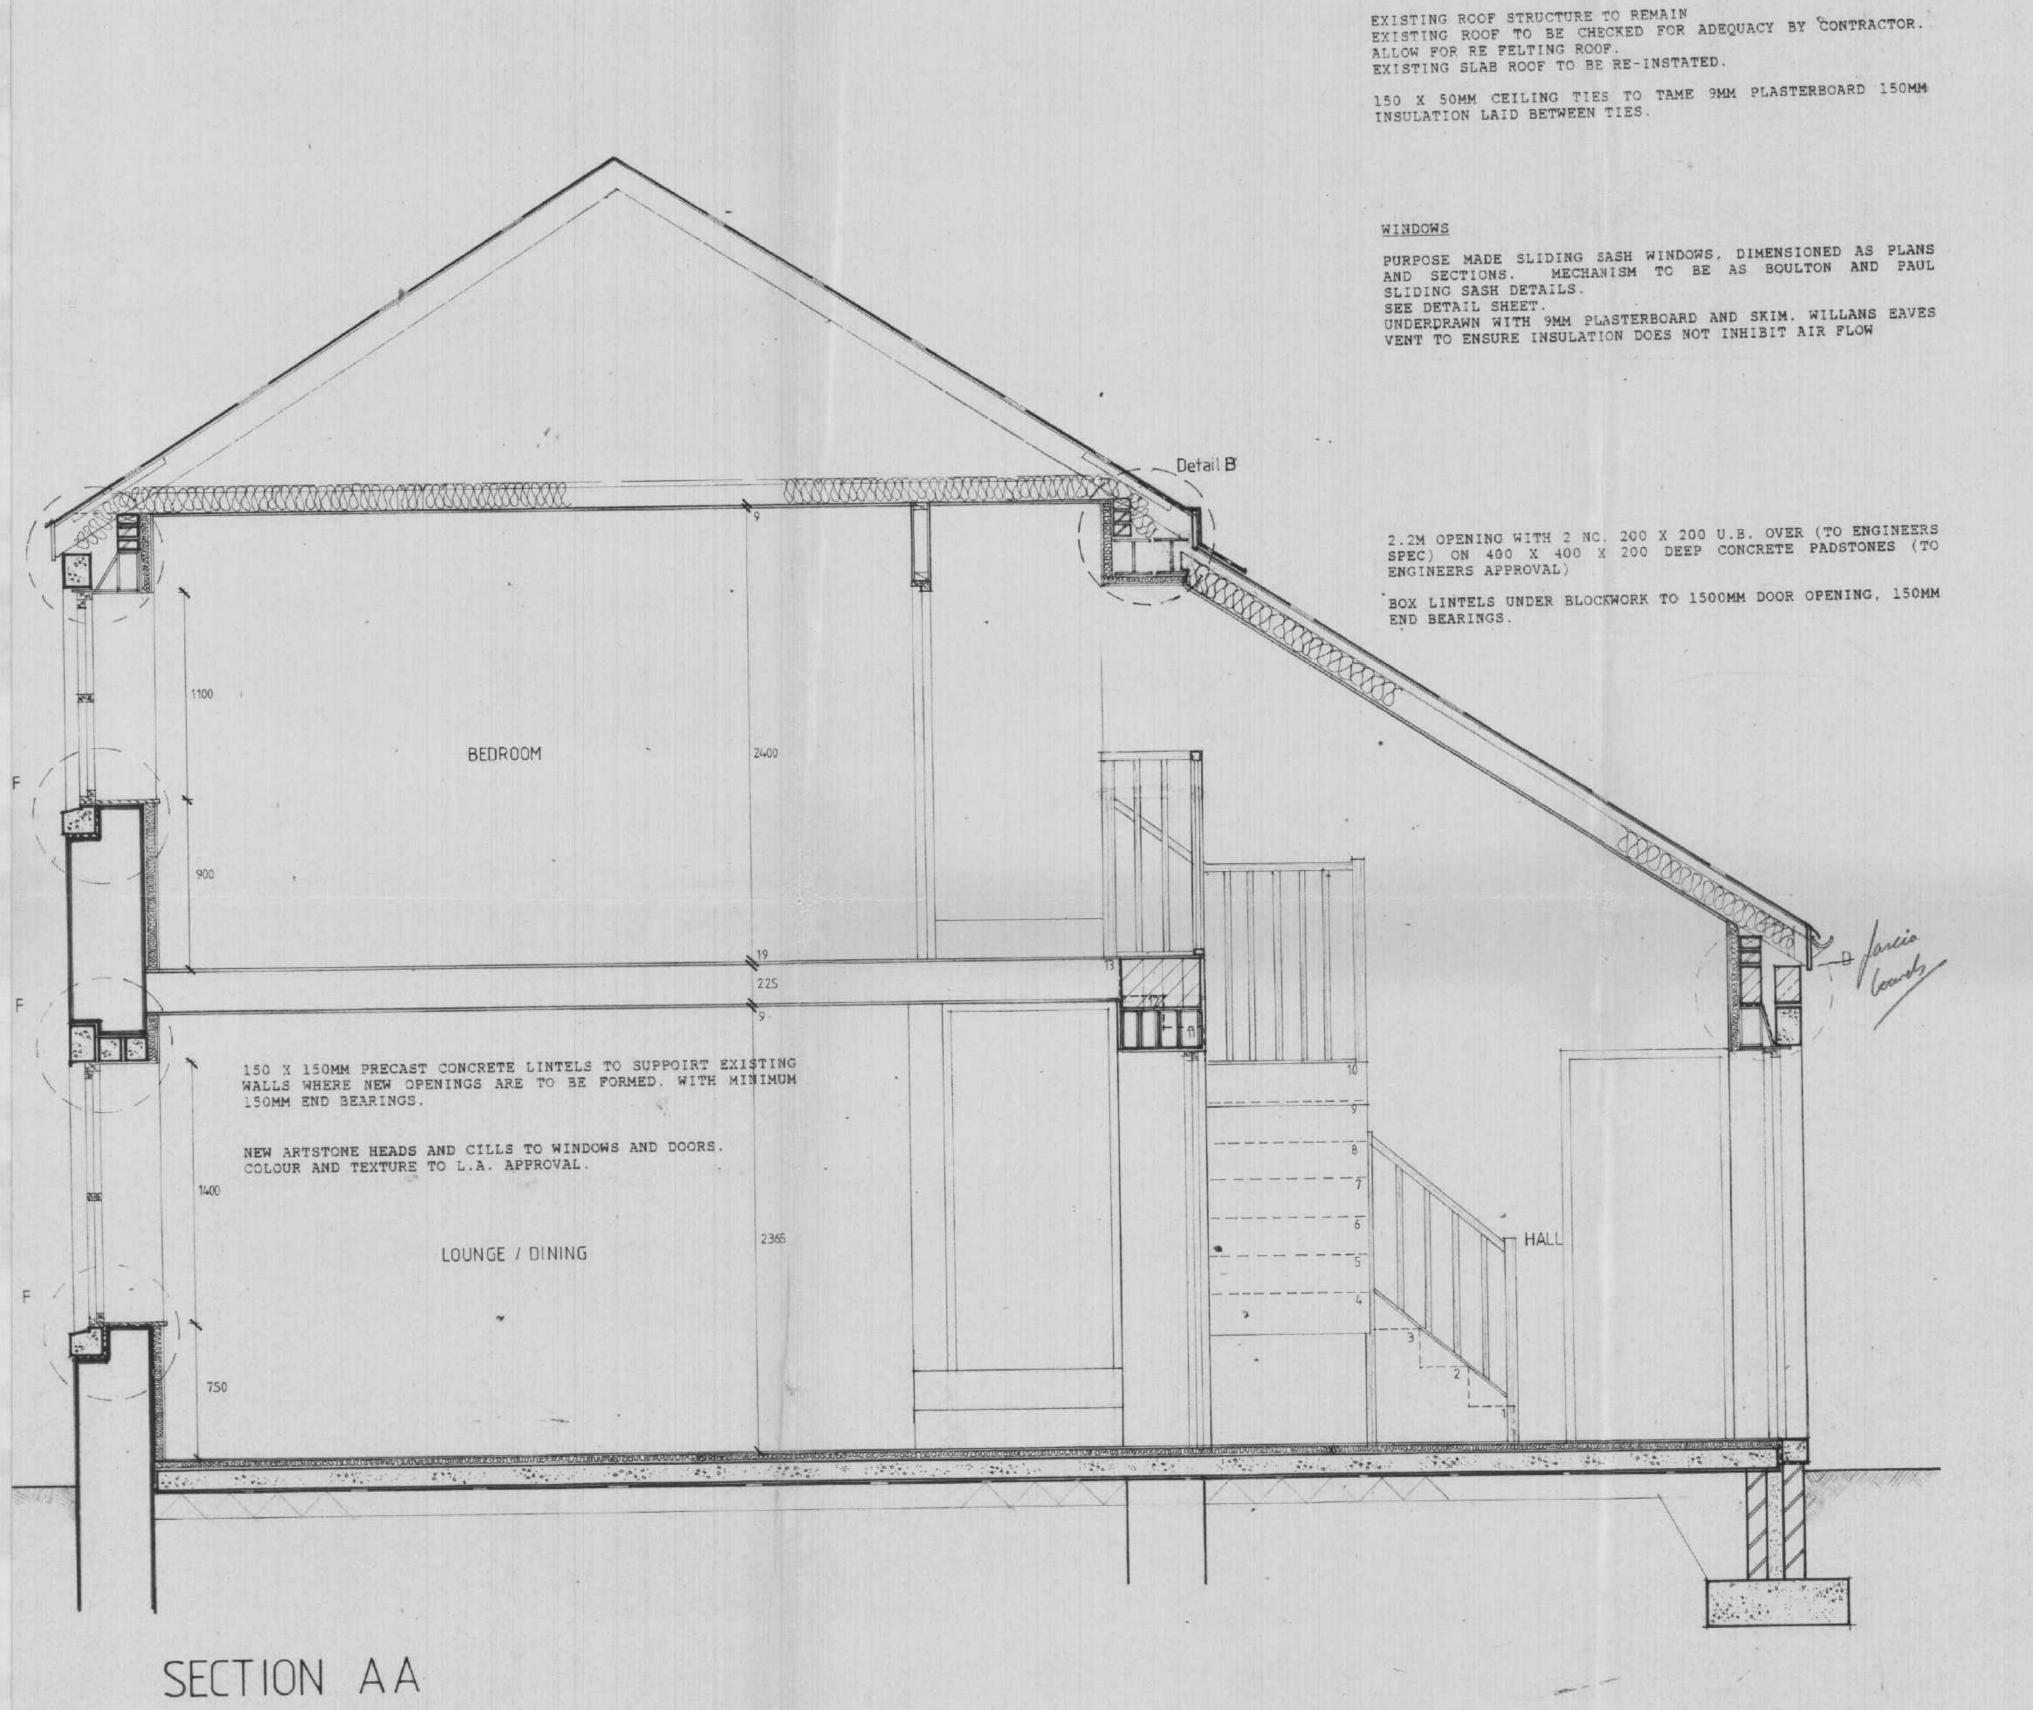

### WALL CONSTRUCTION

REFER TO ENGINEERS MARKED UP DRAWING FOR AREAS TO BUILD UP OR REPLACE. WHERE POSSIBLE, EXISTING CONSTRUCTION TO BE RETAINED.

### NEW CONSTRUCTION

EXTERNAL LEAF, STONE TO BE RE-USED FROM SITE TO FORM OUTER SKIN. 100MM THERMALITE (OR EQUAL) BLOCKWORK INNER LEAF. CLEAR CAVITY BETWEEN LEAVES, STAINLESS STEEL TIES BETWEEN LEAVES, AT APPROX 900 CENTRES HORIZONTALLY 450 CENTRES VERTICALLY. 38MM GYPROC FACED URETHANE INSULATING BOARD TO DRY-LINE EXISTING AND NEW WALLS ON 12MM DABS.

### LINTELS

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D.P.M. TO INTEGRAL FACE OF ALL EXISTING WALLS, 32MM GYPROC FACED URETHANE INSULATING BOARD ON 12MM DABS.

# LEAN TO CONSTRUCTION

200 X 50MM RAFTERS AT 450 CENTRES NOTCHED OVER BOTTOM FLANGE OF U.B. 150MM ROCKWOOL INSULATION LAID BETWEEN RAFTERS, UNDERDRAWN WITH 9MM PLASTERBOARD AND SKIM. 50MM CONTINUOUS AIRGAP MAINTAINED THROUGHOUT.

### FIRST FLOOR CONSTRUCTION

275 x 75 SC4 FLOOR JOISTS NOTTHED 100MM INTO WALL AT 450 19MM T & G WEYROC FLOORING UNDERDRAWN WITH 9MM PLASTERBOARD & SKIM

100MM DIA HALF ROUND GUTTER, WITH 75MM DOWNPIPES TO GULLEY .

FAMILY ROOM/HALL TO BE BUILT IN 350MM CAVITY CONSTRUCTION.

EXISTING STONE RE USED TO EXTERNAL LEAF 50MM CLEAR CAVITY 100MM BLOCKWORK INTERNAL LEAF 38MM GYPROC FACED URETHANE INSULATION BOARD ON 12MM DABS DPC AT 150MM ABOVE F.L.

# STAIRCASE


PURPOSE MADE STAIRCASE AS SHOWN ON PLAN MAX RISE 190MM, MINT. TREAD 240MM, MAX PITCH 42 900 WIDE STAIR AND LANDINGS 900 HIGH HANDRAIL 1100 HIGH AT LANDING POSITION BALUSTERS POSITIONED TO PREVENT THE PASSAGE OF A 100MM SPHERE.


# GROUND FLOOR CONSTRUCTION

19MM WEYROC T & G PLOORING ON 40MM ROCKWOOL INSULATION (RWS OR RW6) ON 100MM CONCRETE FLOOR SLAB ON 1200 GAUGE VISQUEEN VAPOUR BARRIER ON 150MM WELL ROLLED AND BLINDED HARDCORE.


A142 MESH REINFORCEMENT TO SLAB, 40MM COVER TO ALL SIDES WEAK MIX CONCRETE FILL BELOW DPC LEVEL

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July 91

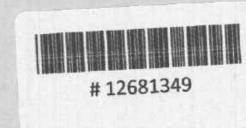
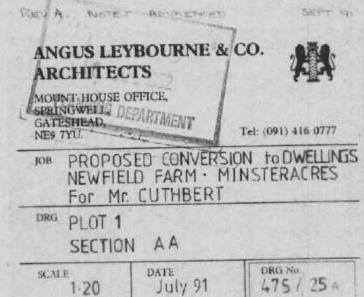
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ARCHITECTS

MOUNT HOUSE OFFICE, SPRINGWELL, GATESHEAD, NE9 7YU.

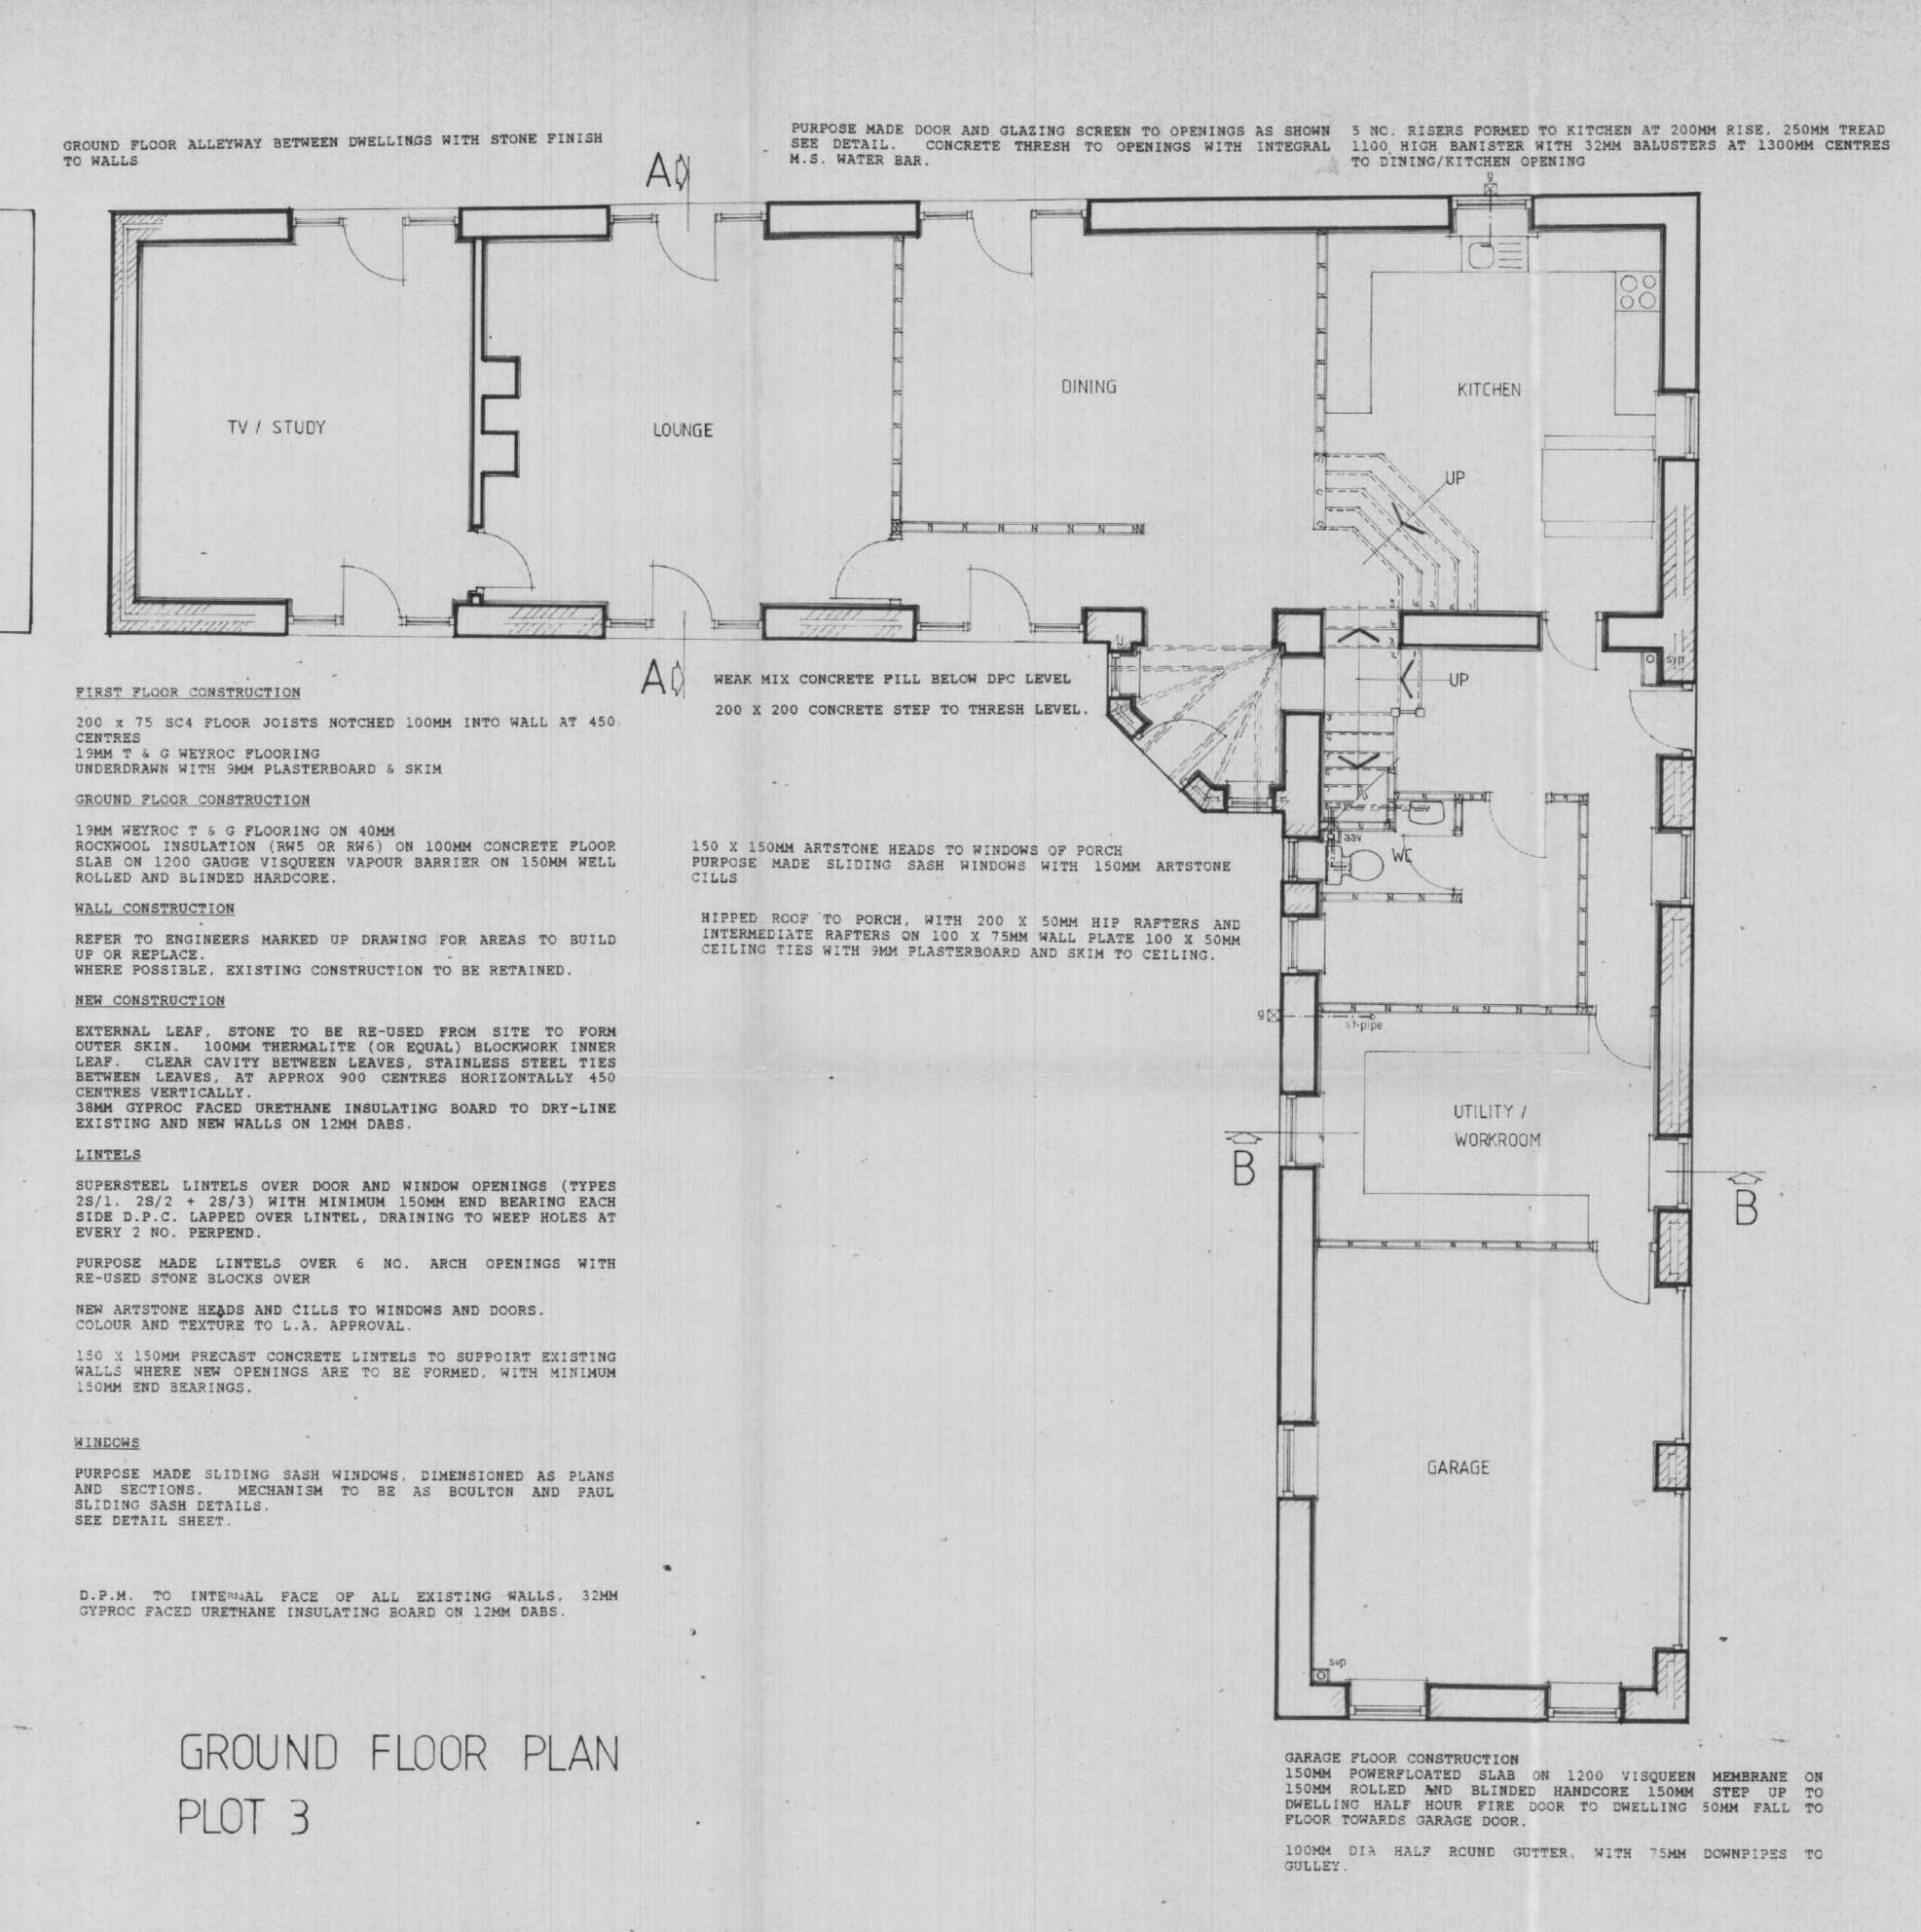DRAINAGE

JOB PROPOSED CONVERSION to DWELLINGS NEW FIELD FARM · MINSTERACRES FOR Mr. CUTHBERT


GULLEY


SOIL/VENT PIPE

AIR ADMITTANCE VALVE

PLAN GROUND + FIRST FLOOR

1:50 DATE DRG No. 475 / 24

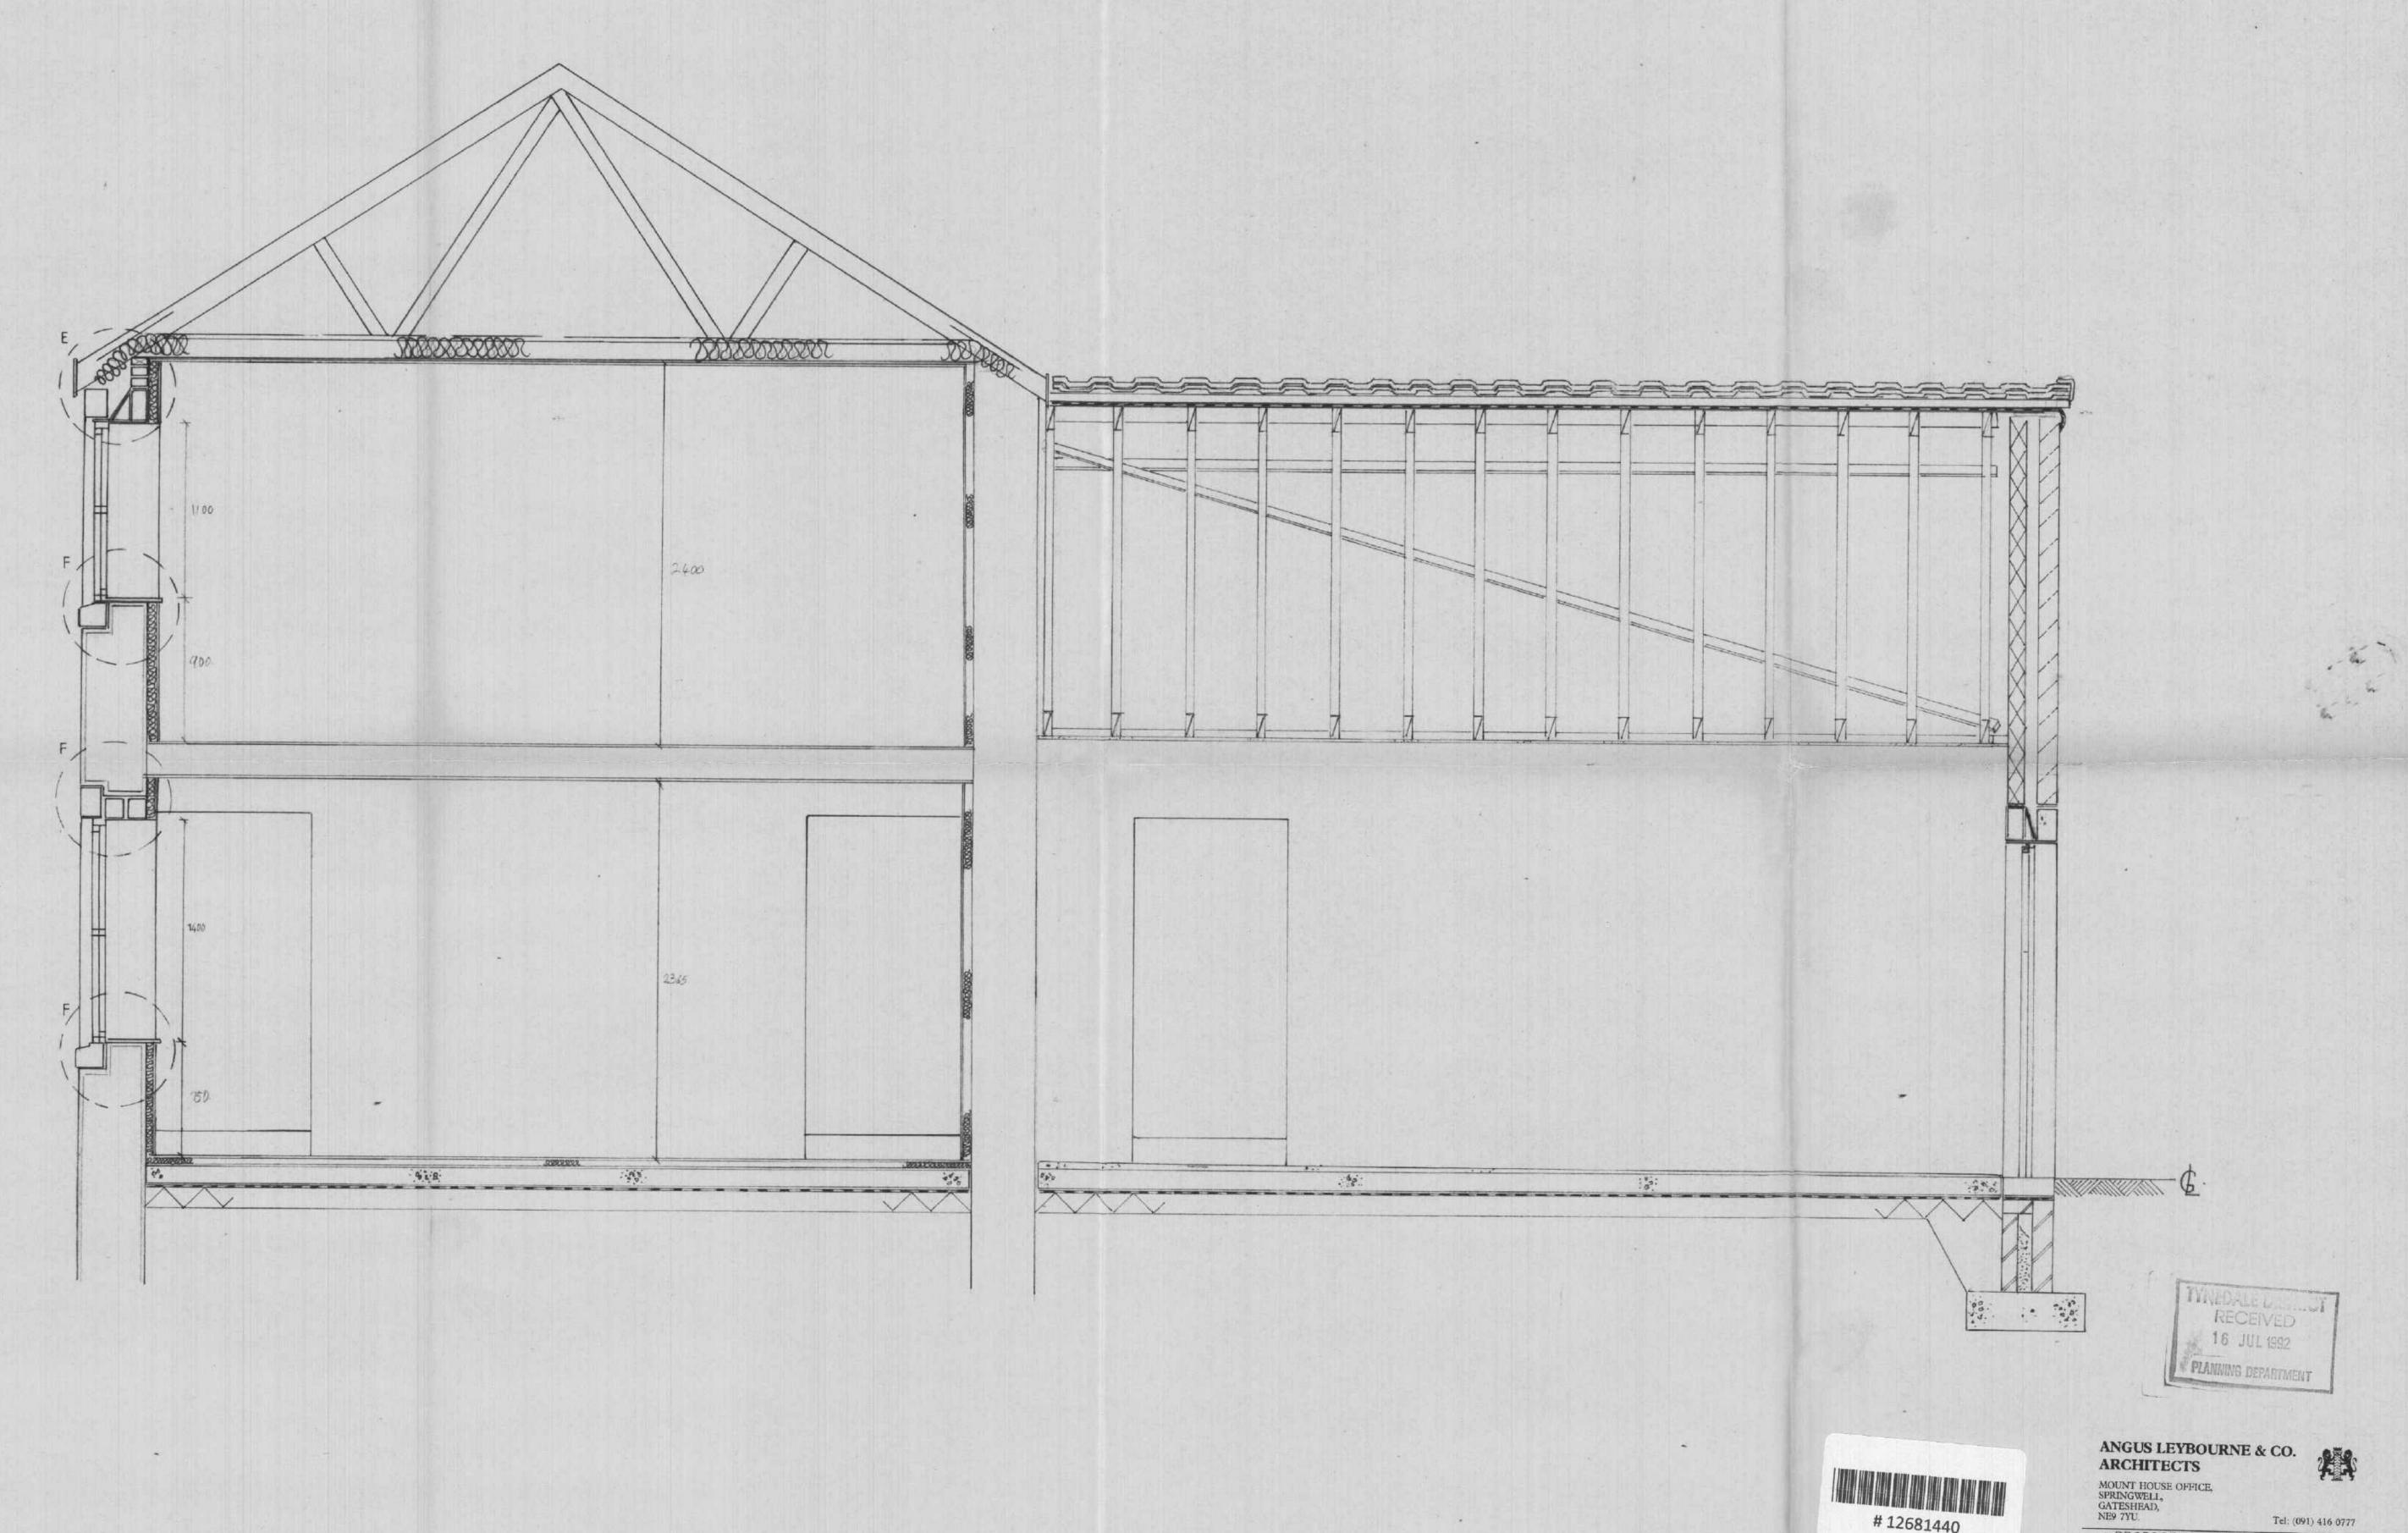

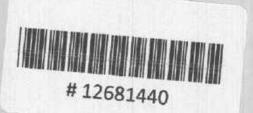

Tel: (091) 416 0777 JOB PROPOSED CONVERSION to DWELLING
NEWFIELD FARM- MINSTERACRES
for MR. CUTHBERT

DRG PLOT 1 SECTION- B-B

SCALE DRG No. DATE 1, 20 AUG 91 475/026