

ground floor plan

EXTERNAL WALLS: 15mm Render

100mm Concrete block

50mm Cavity

150mm Timber frame with insulation 25mm Insulation across frame

Vapour barrier 40mm Services void

12.5mm Plasterboard

Base wall to be 100m stone to match existing in lieu of blockwork and render

SUSPENDED FLOOR:

18mm Chipboard

200x50mm Timber joists at 400mm centres 200mm Insulation between joists

Vented solum

PITCHED ROOF: Concrete tiles

Battens & counter battens Breather Membrane

9mm Sarking

200x50mm Timber rafters with insulation bewteen

25mm Insulation across rafters Vapour barrier

12.5mm Plasterboard


WINDOW & DOORS:


uPVC double glzed to 1.2 U Value

RAINWATER GOODS: Black uPVC



south elevation

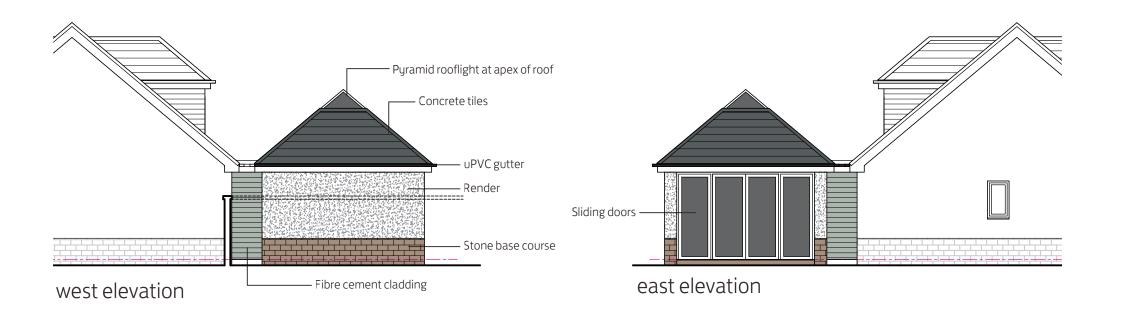

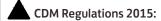

Notes:

The designs on this drawing and all drawings relating to it have been prepared with due consideration of the need to identify hazards and give regard to their elimination or minimization. Remaining hazards are noted on this drawing where applicable.

А	03 09 21	Specification Added	-
Rev	Date	Revision	Ву

Client: Mr & Mrs Fyfe

Project:

Coulters Brae Carmunnock Glasgow

Title

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Floor Plan and Elevations As Proposed

Issue Status : COMMENT	Scale: 1:100	Original Size : A3		
Date: August 2021	Drawn by:	Checked by:		

Project No:	Stage:	Drawing No:	Rev:
D1001	2 - Concept Design	G (2-) 001	А

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