




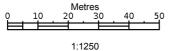

Produced 19 Mar 2022 from the Ordnance Survey MasterMap (Topography) Database and incorporating surveyed revision available at this date.


The representation of a road, track or path is no evidence of a right of way. The representation of features as lines is no evidence of a property boundary.



Supplied by: Stanfords 19 Mar 2022 Licence: © Crown Copyright and database rights 2022 OS100035409 Order Licence Reference: OI1530262 Centre coordinates: 377919 421629



2, Hyacinth Cl, Haslingden, Rossendale BB4 6JU

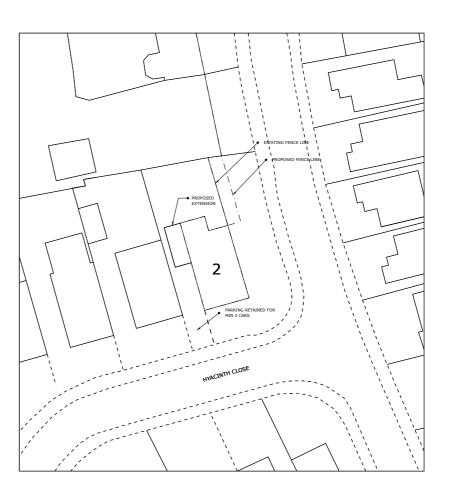

1:500 BLOCK PLAN



ANY ALTERATION OR DEVIATION MUST BE CONFIRMED WITH THE ARCHITECT/ENGINEER/LPA/ LABC PRIOR TO ANY WORKS BEING CARRIED OUT. IT IS THE CONTRACTORS SOLE RESPONSIBILITY T CONFEM ALL SITE MEASUREMENTS PRIOR TO ANY ORDERING OR COMMENCEMENT AS NO RESPONSIBILITY IS ACCEPTED OR IMPLIED BY THE ARCHITECT/ENGINEER ETC.

THE DRAWINGS AND INFORMATION HERIN IS AND REMAINS SOLELY THE PROPERTY OF THE ARCHITECT ANY UNAUTHORISED USE/COPYING/SHARING/PUBLICATION/SUBMISSION ETC WILL NOT BE

1:1250

@A3

ANY UNBOUNDALSED SOLVED.


PERMITTED
UNDER COPYRIGHT LAW/INTELLECTUAL PROPERTY. THIS USE ALSO EXTENDS TO THAT OF THE
LPA/LABC
AND CHECKS MUST BE MADE TO SATISFY THE SOURCE OF THE DOCUMENT PRIOR TO USE.

PROJECT/JOB/DWG NO/ MR/001/01

CLIENT


MISS MANDY ROSCOE **SCALE** 1:500 **PROJECT**


Archtech Design Solutions Steve Jackson Dip con Dip arch 14 Maitland Place, Rossendale, Lancs BB4 6AT..... TEL 07792183353 PROPOSED EXTENSION AT 2HYACINTH CLOSE ROSSENDALE archtech-design@icloud.com Archtech-design.co.uk

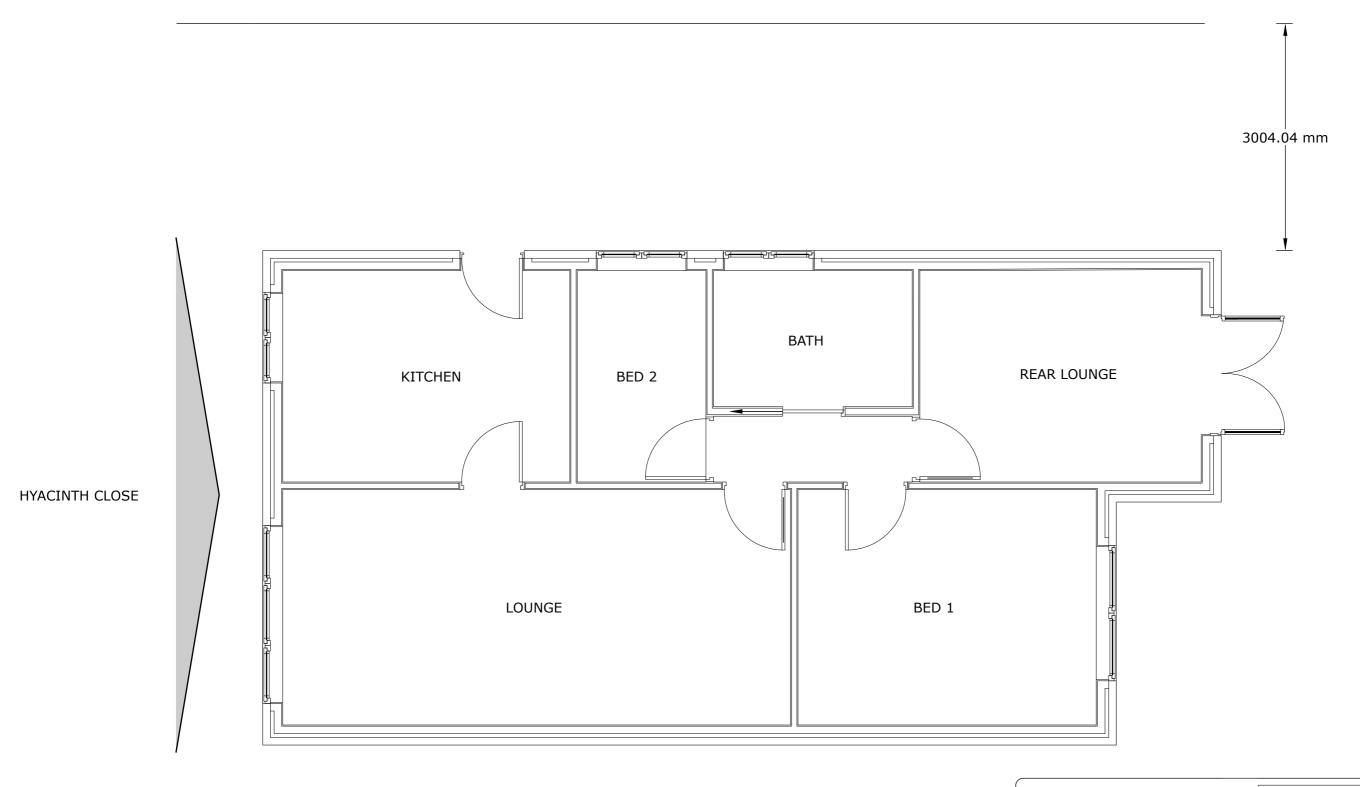

EXISTING FLOOR PLAN




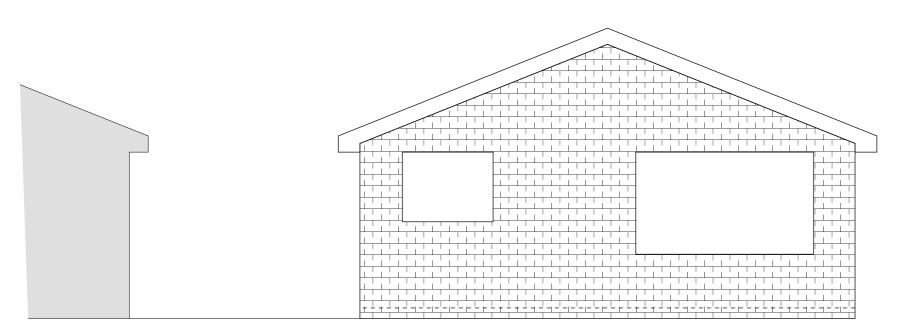

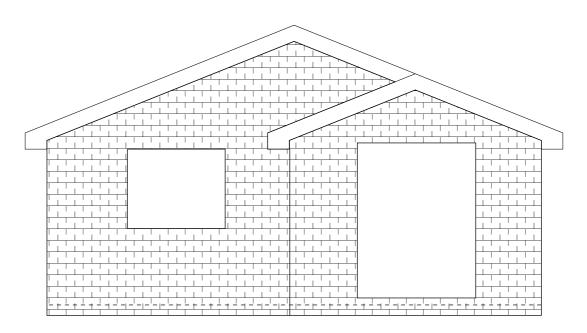


EXISTING REAR ELEVATION

EXISTING FRONT ELEVATION

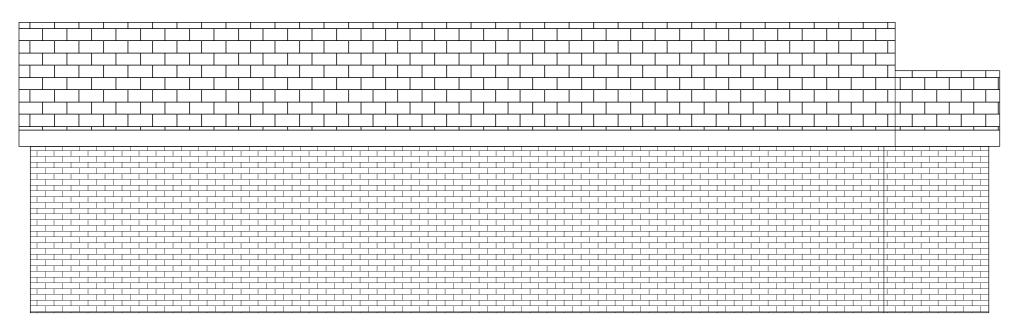

EXISTING SIDE ELEVATION

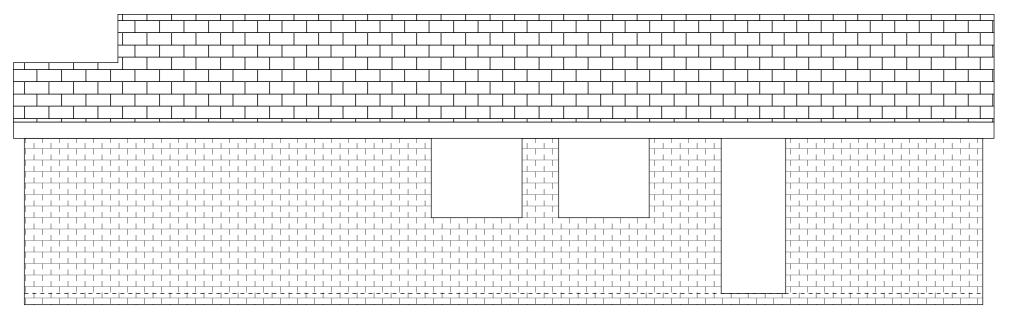

EXISTING SIDE ELEVATION



Archtech Design Solutions Steve Jackson Dip con Dip arch 14 Maitland Place, Rossendale, Lancs BB4 6AT..... TEL 07792183353 archtech-design@icloud.com Archtech-design.co.uk


PROJECT/JOB/DWG NO/ MR/002/01

CLIENT

MISS MANDY ROSCOE SCALE 1:50


PROPOSED EXTENSION AT 2HYACINTH CLOSE ROSSENDALE


PROJECT

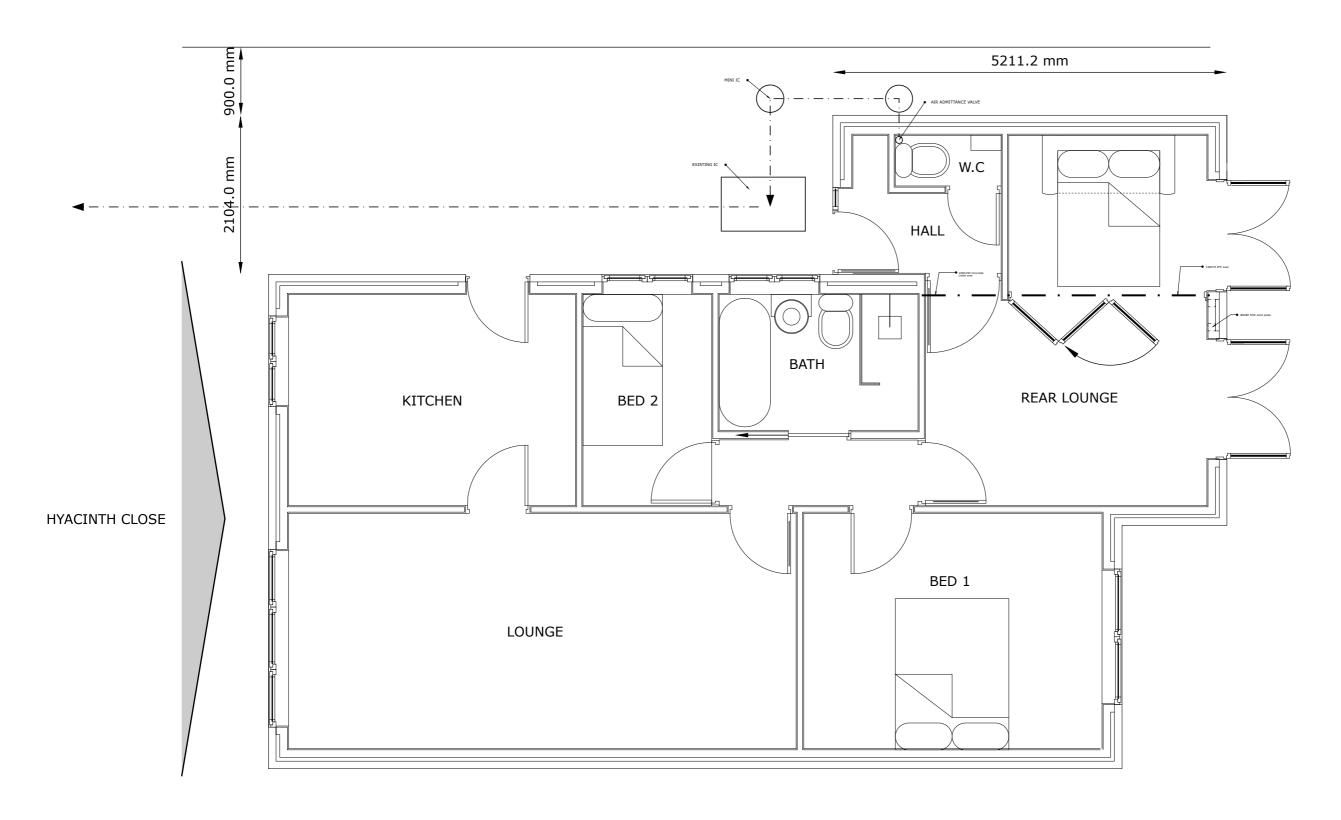



PROPOSED FLOOR PLAN



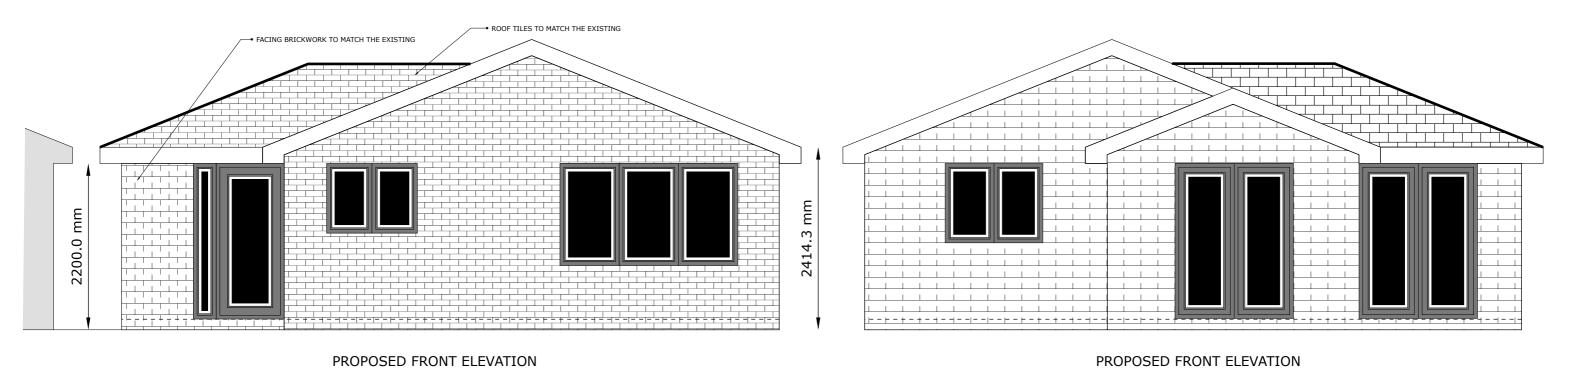

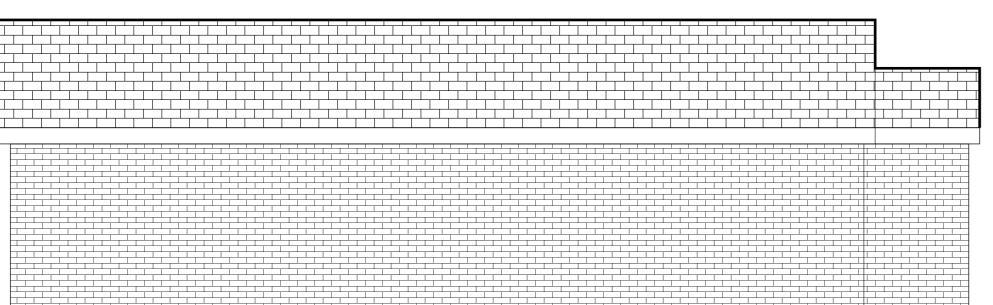

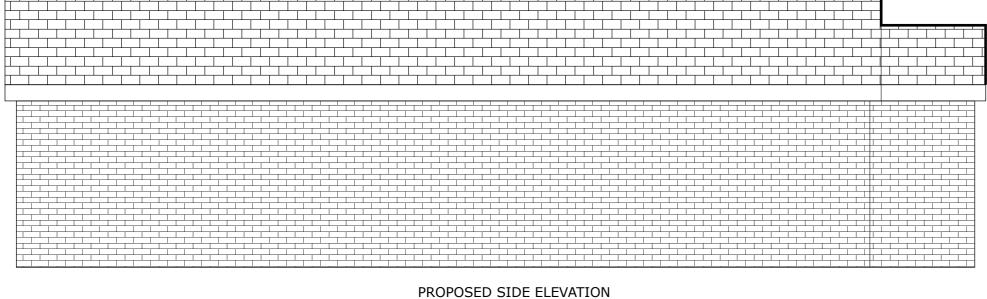

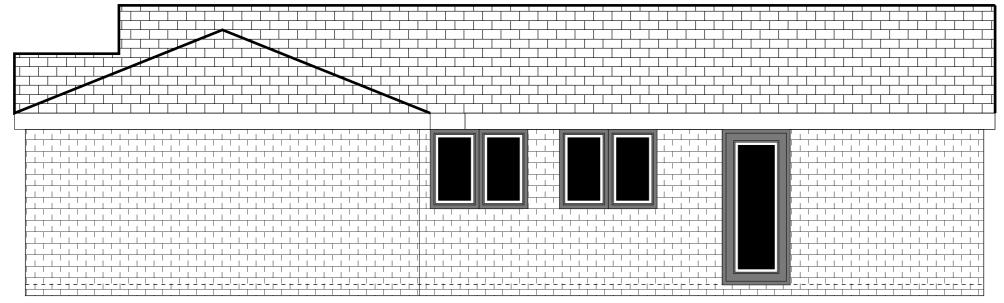



3515.5 mm

PROPOSED SIDE ELEVATION

N/B *** although heights are shown the "as built" supersedes All other dimensions***



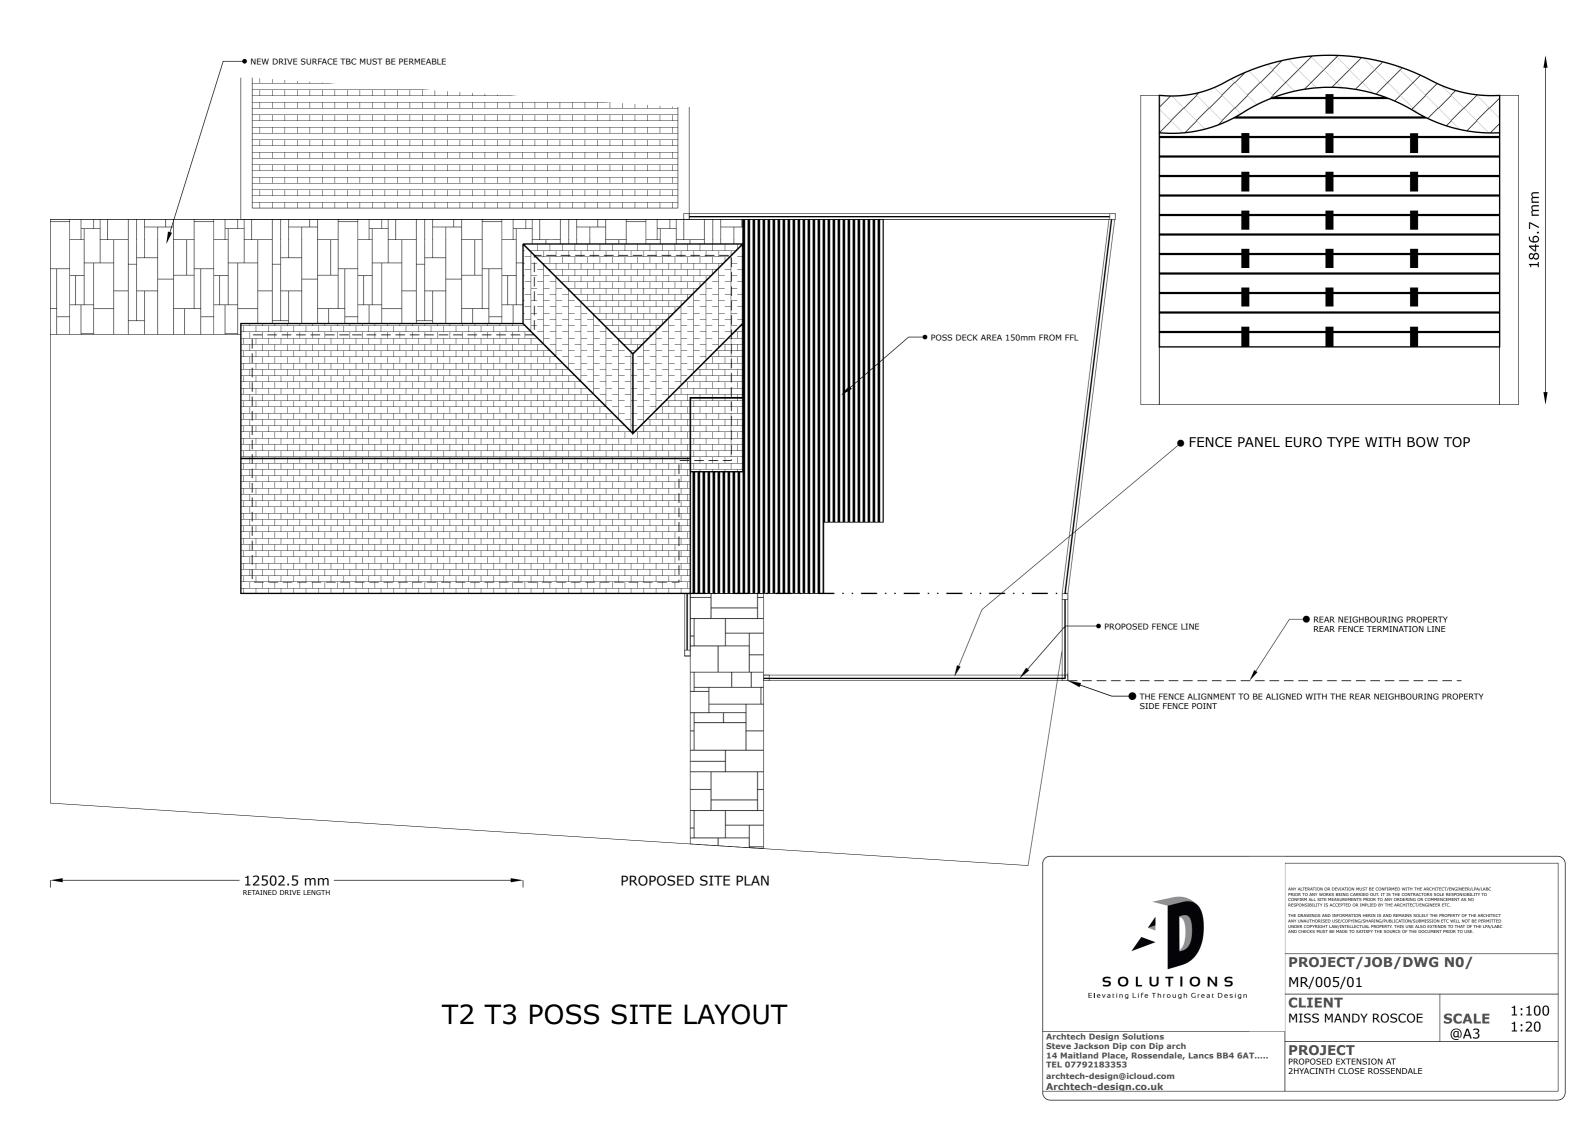

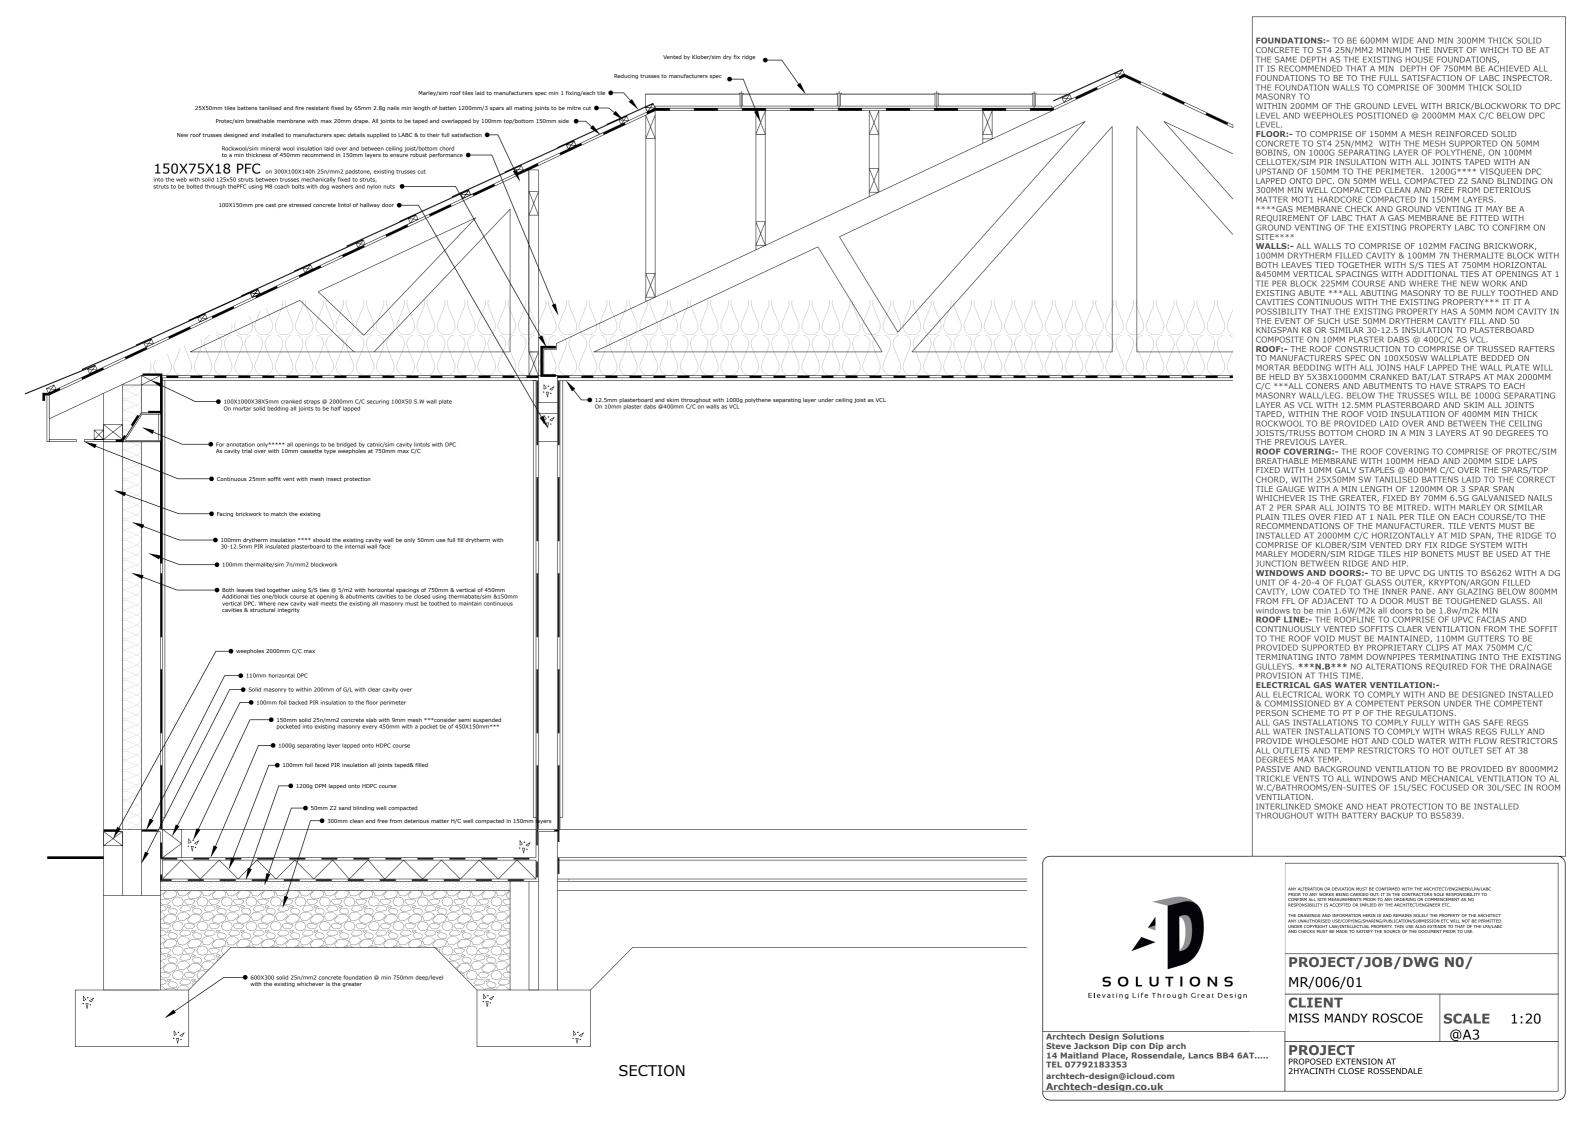

Miss M Roscoe

2 Hyacinth Close

Rossendale

BEAM A	SPAN 4.50N

LOAD	LOADING W1	START X1 LOA	DING W2 END X2	R1 COMP	R2COMP
UD o.w	0.2	0	L	0.35	0.35
RD roof dead	6	1.1	2.6	4.24	4.76
RLrooflive	6	1.1	2.6	4.24	4.76
			Total load 18.70	8.84	9.86
		dead	4.59	5.11	
		live	4.24 4.76		

Maximum B.M. = 12.6 KNm at 1.81m. from R1

Maximum S.F. = 9.8 KN at R1

Live load deflection = 7.35 X 10⁸ /EI at 1.78 m. from R1 (E in N/mm², I in cm⁴)

Total deflection = 15.1 X 10⁸ /El at 1.78 m. from R1

Use 2No 150X75X18PFC \$355

BENDING: $P_{bc} = 141.9 \text{ N/mm}^2 \text{ (table 3b)}$ $f_b = 109.9 \text{ N/mm}^2 \text{ OK}$

SHEAR: fs = 12.0 N/mm² (Ps 140 N/mm²) OK

LIVE LOAD DEFLECTION = 4.2 (L/841) OK

TOTAL DEFLECTION = 8.5 mm)L/409

BEARINGS

146X37 UB STIFF BEARING LENGTH, b1 = t + 1.6r + 2T = 40.3 MM; OA b1 TAKEN AS 186.7 MM

LOCAL DESIGN STRENGTH OF MASONRY (FACTORED) = 0.700N/mm²

R1: 200X100X100h (use 140h) mm PADSTONE

Factored reaction = 4.59 X 1.4 + 4.24 X 1.6 = 13.22 KN

Factored stress under padstone = 0.66 N/mm²

R2: 225X100X100h (use 140h) mm PADSTONE

Factored reaction = 5.11 X 1.4 X 4.76 X 1.6 = 14.76 KN

