

## Low Level Path Lighting

Lanea Path Lighting Bollard with PIR sensor.

### Benefits :

- LED mains wired.
- Low level height, only 40cm high.
- LED bulbs installed into this pillar lamp are in such a manner that they shine downwards onto cascading reflectors, keeping all light at low level.
- Integrated PIR sensor, keeping light levels low and only on when required.
- Range 2-8metres, set at 5m as shown.
- Lighting duration (5 seconds to 6 minutes ) are configurable.
- Detects movement at an angle of 90 degrees .





### KEY TO SYMBOLS




**OWNERSHIP BOUNDARY**  
 AREA = 5818 m2

**SITE BOUNDARY**  
 SITE AREA = 4370 m2

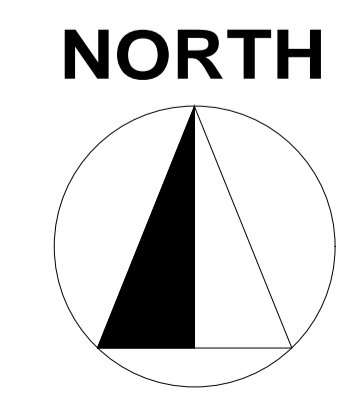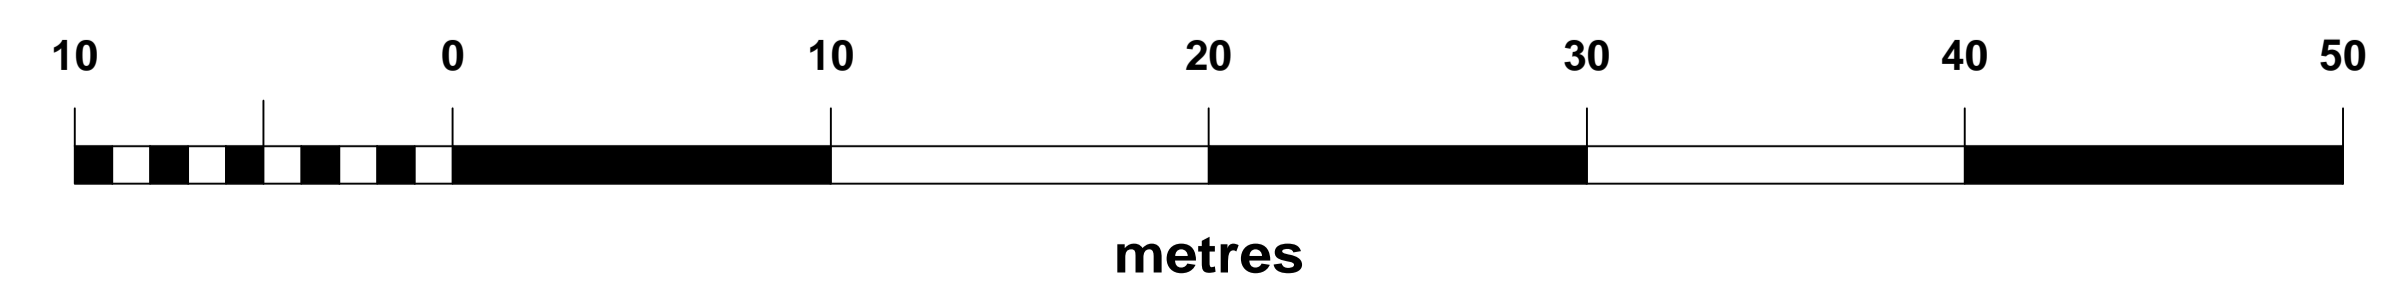

Date	Description	Rev	By
Revision Description			

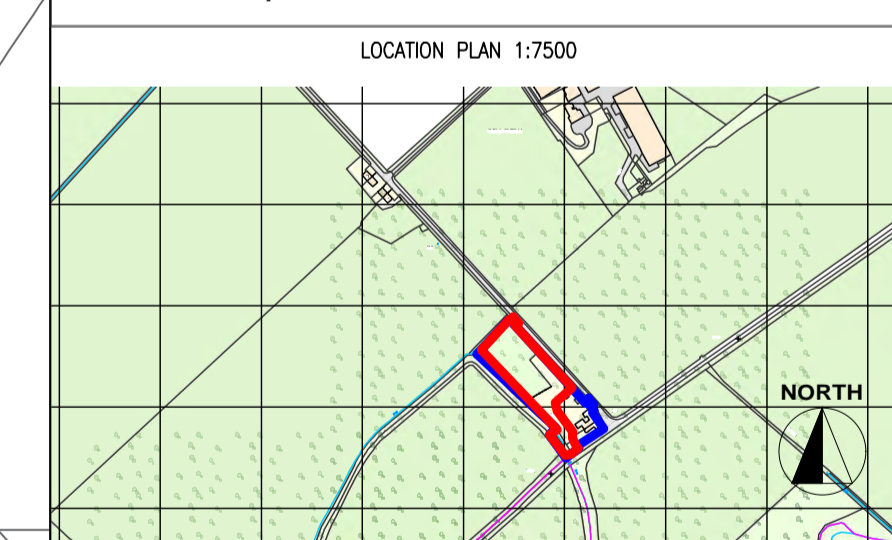

Project:  
**Proposed Glamping Site - For Naomi Michell**  
 1 Hassington Blue Houses, Kelso  
 TD5 7RA

Drawing Title:  
**LIGHTING PLAN**

Drawing Number:  
**211022-01-08**

Revision:  
 Date: 31.01.2022  
 Scale: 1:200 @ A1  
 Drawn By: TA  
 CAD Dwg File: -  
 Checked By: EC

Issue Status:  
**Full Planning Application**