



### KEY:

#### SITE BOUNDARY LINE


------ PROPOSED HANAGAR BUILDING LINE

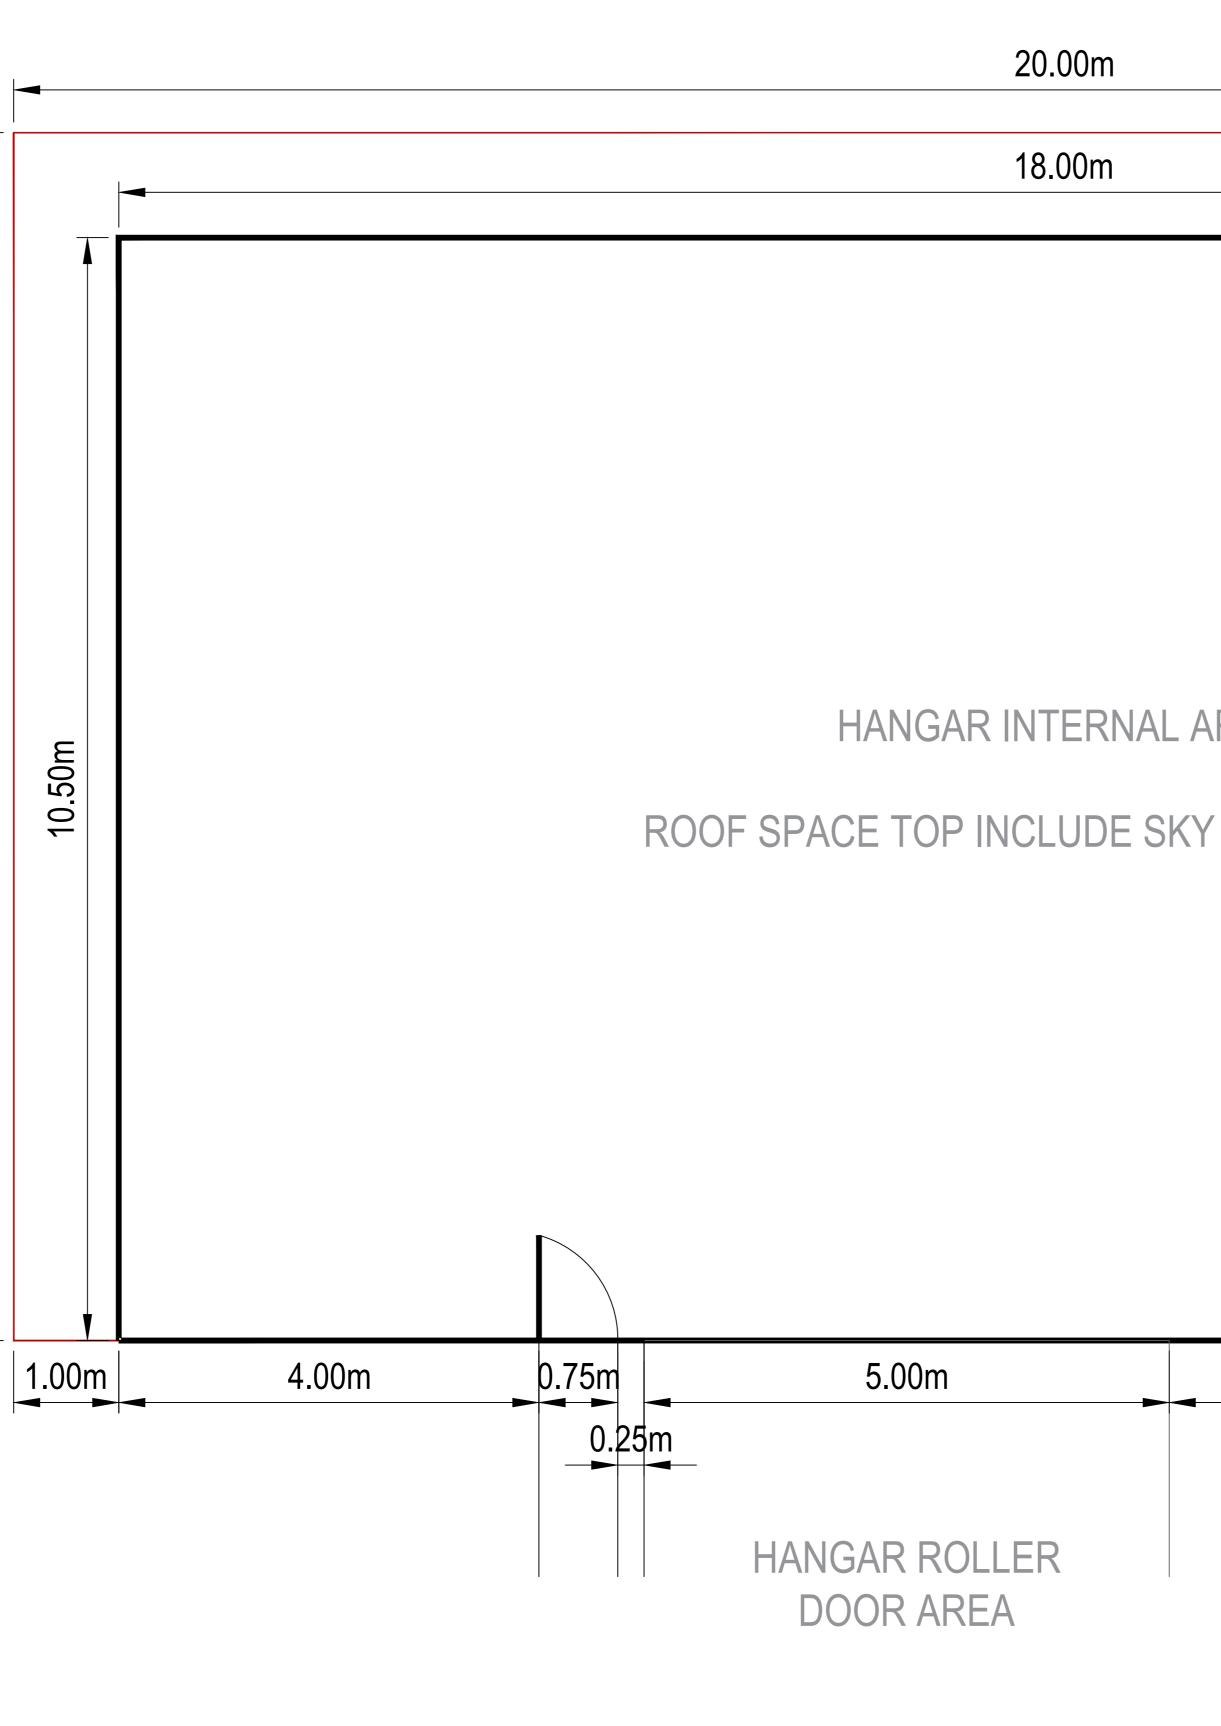

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REA		UNDAI
LIGHT PANELS		SITE BOUNDARY
		S
8.00m	1.00m	

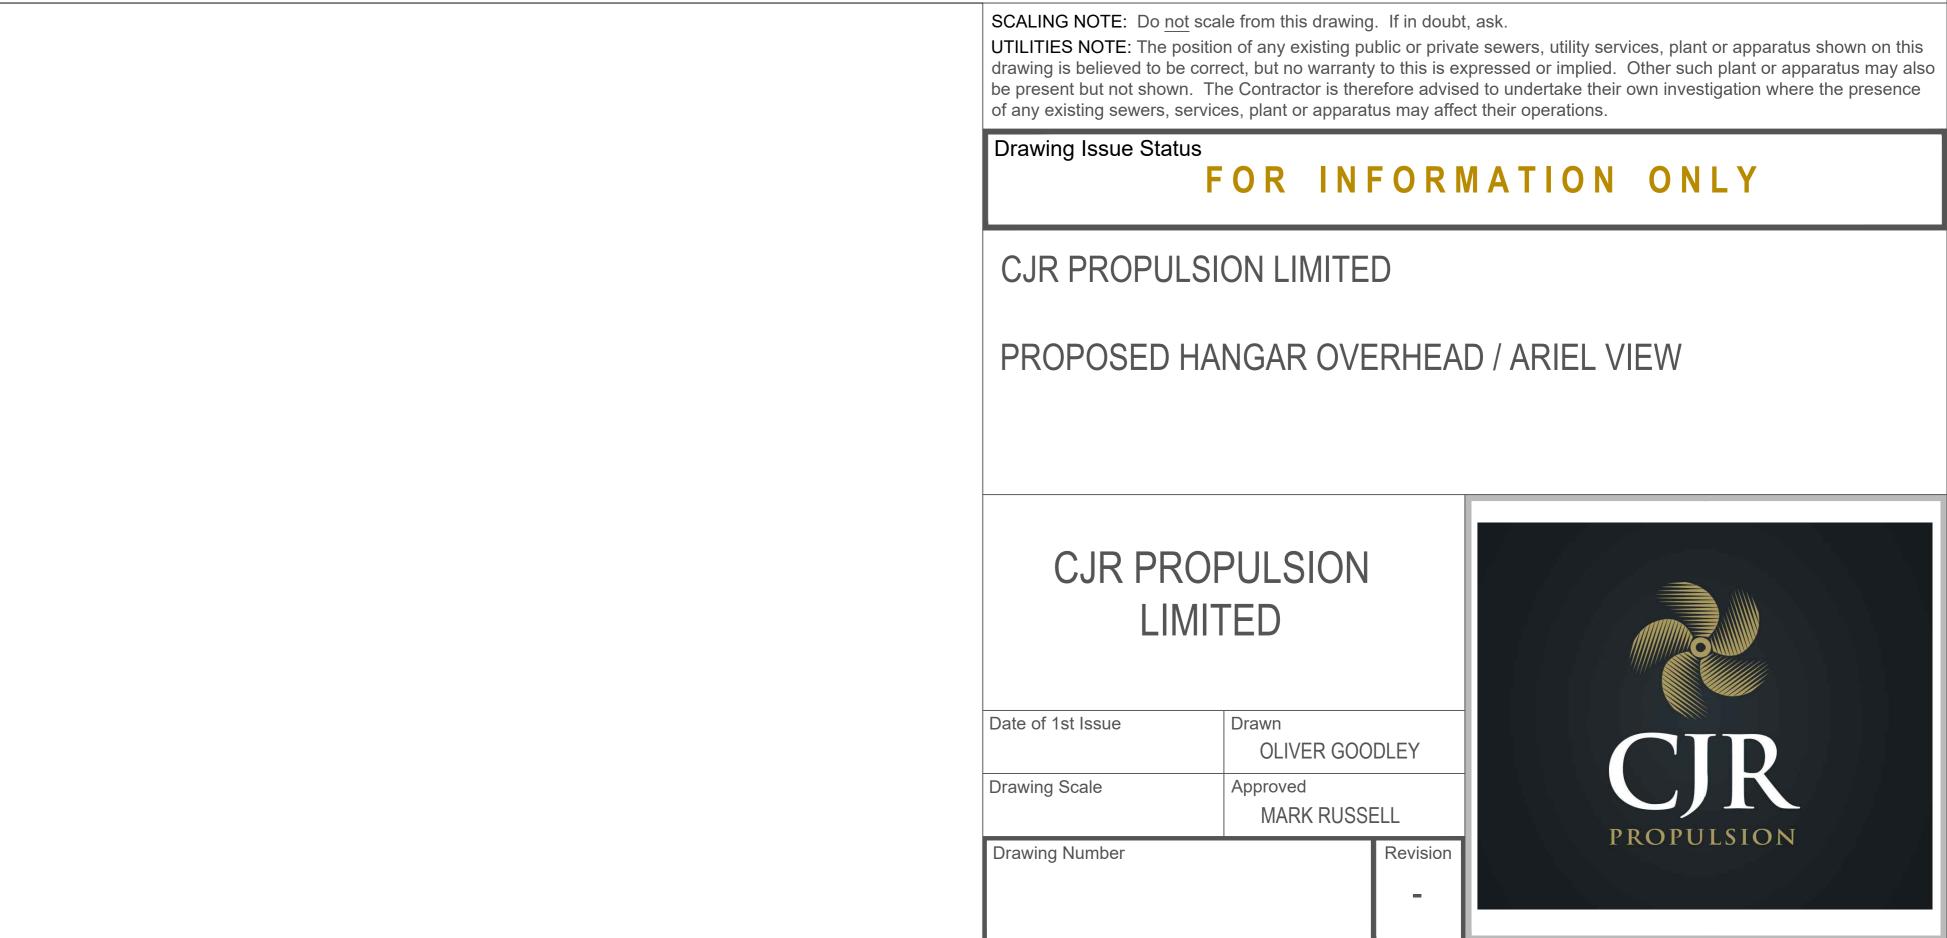


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Drawing Scale

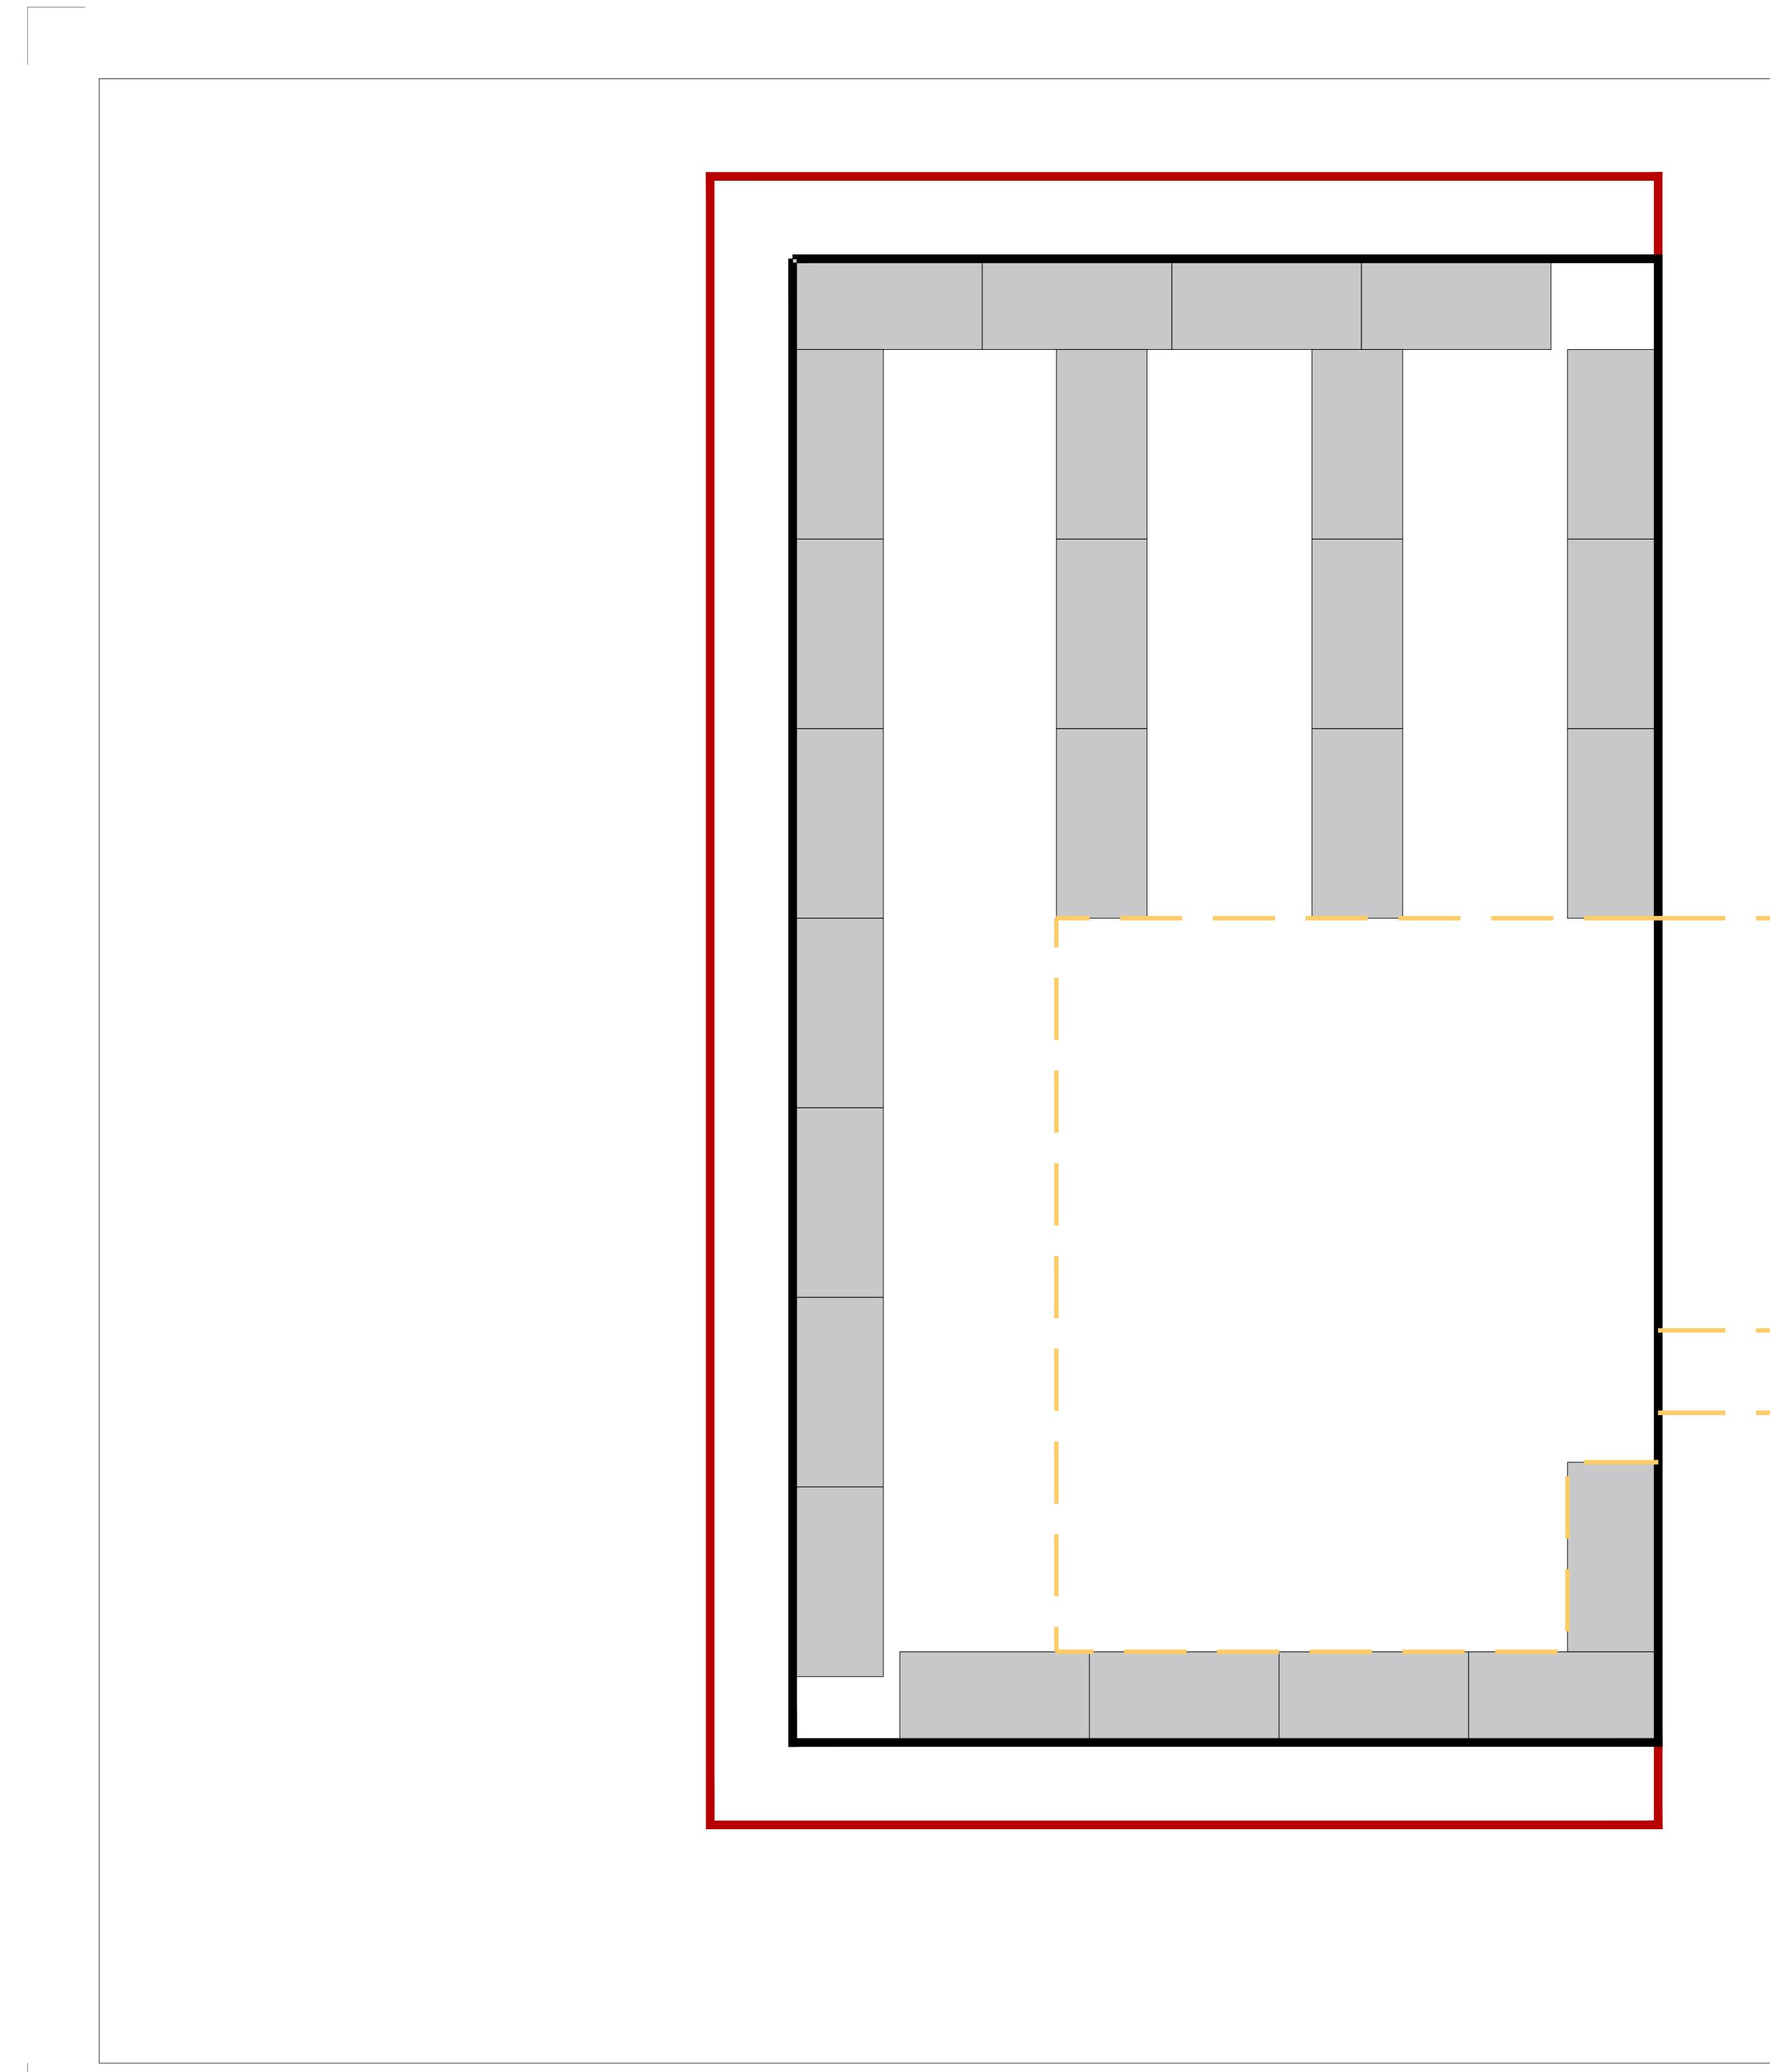Drawing Number

Date of 1st Issue



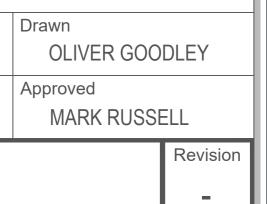

## PROPOSED HANGAR INTERNAL LAYOUT


### CJR PROPULSION LIMITED

CJR PROPULSION

LIMITED

#### Drawing Issue Status FOR INFORMATION ONLY

SCALING NOTE: Do <u>not</u> scale from this drawing. If in doubt, ask. UTILITIES NOTE: The position of any existing public or private sewers, utility services, plant or apparatus shown on this drawing is believed to be correct, but no warranty to this is expressed or implied. Other such plant or apparatus may also be present but not shown. The Contractor is therefore advised to undertake their own investigation where the presence of any existing sewers, services, plant or apparatus may affect their operations.

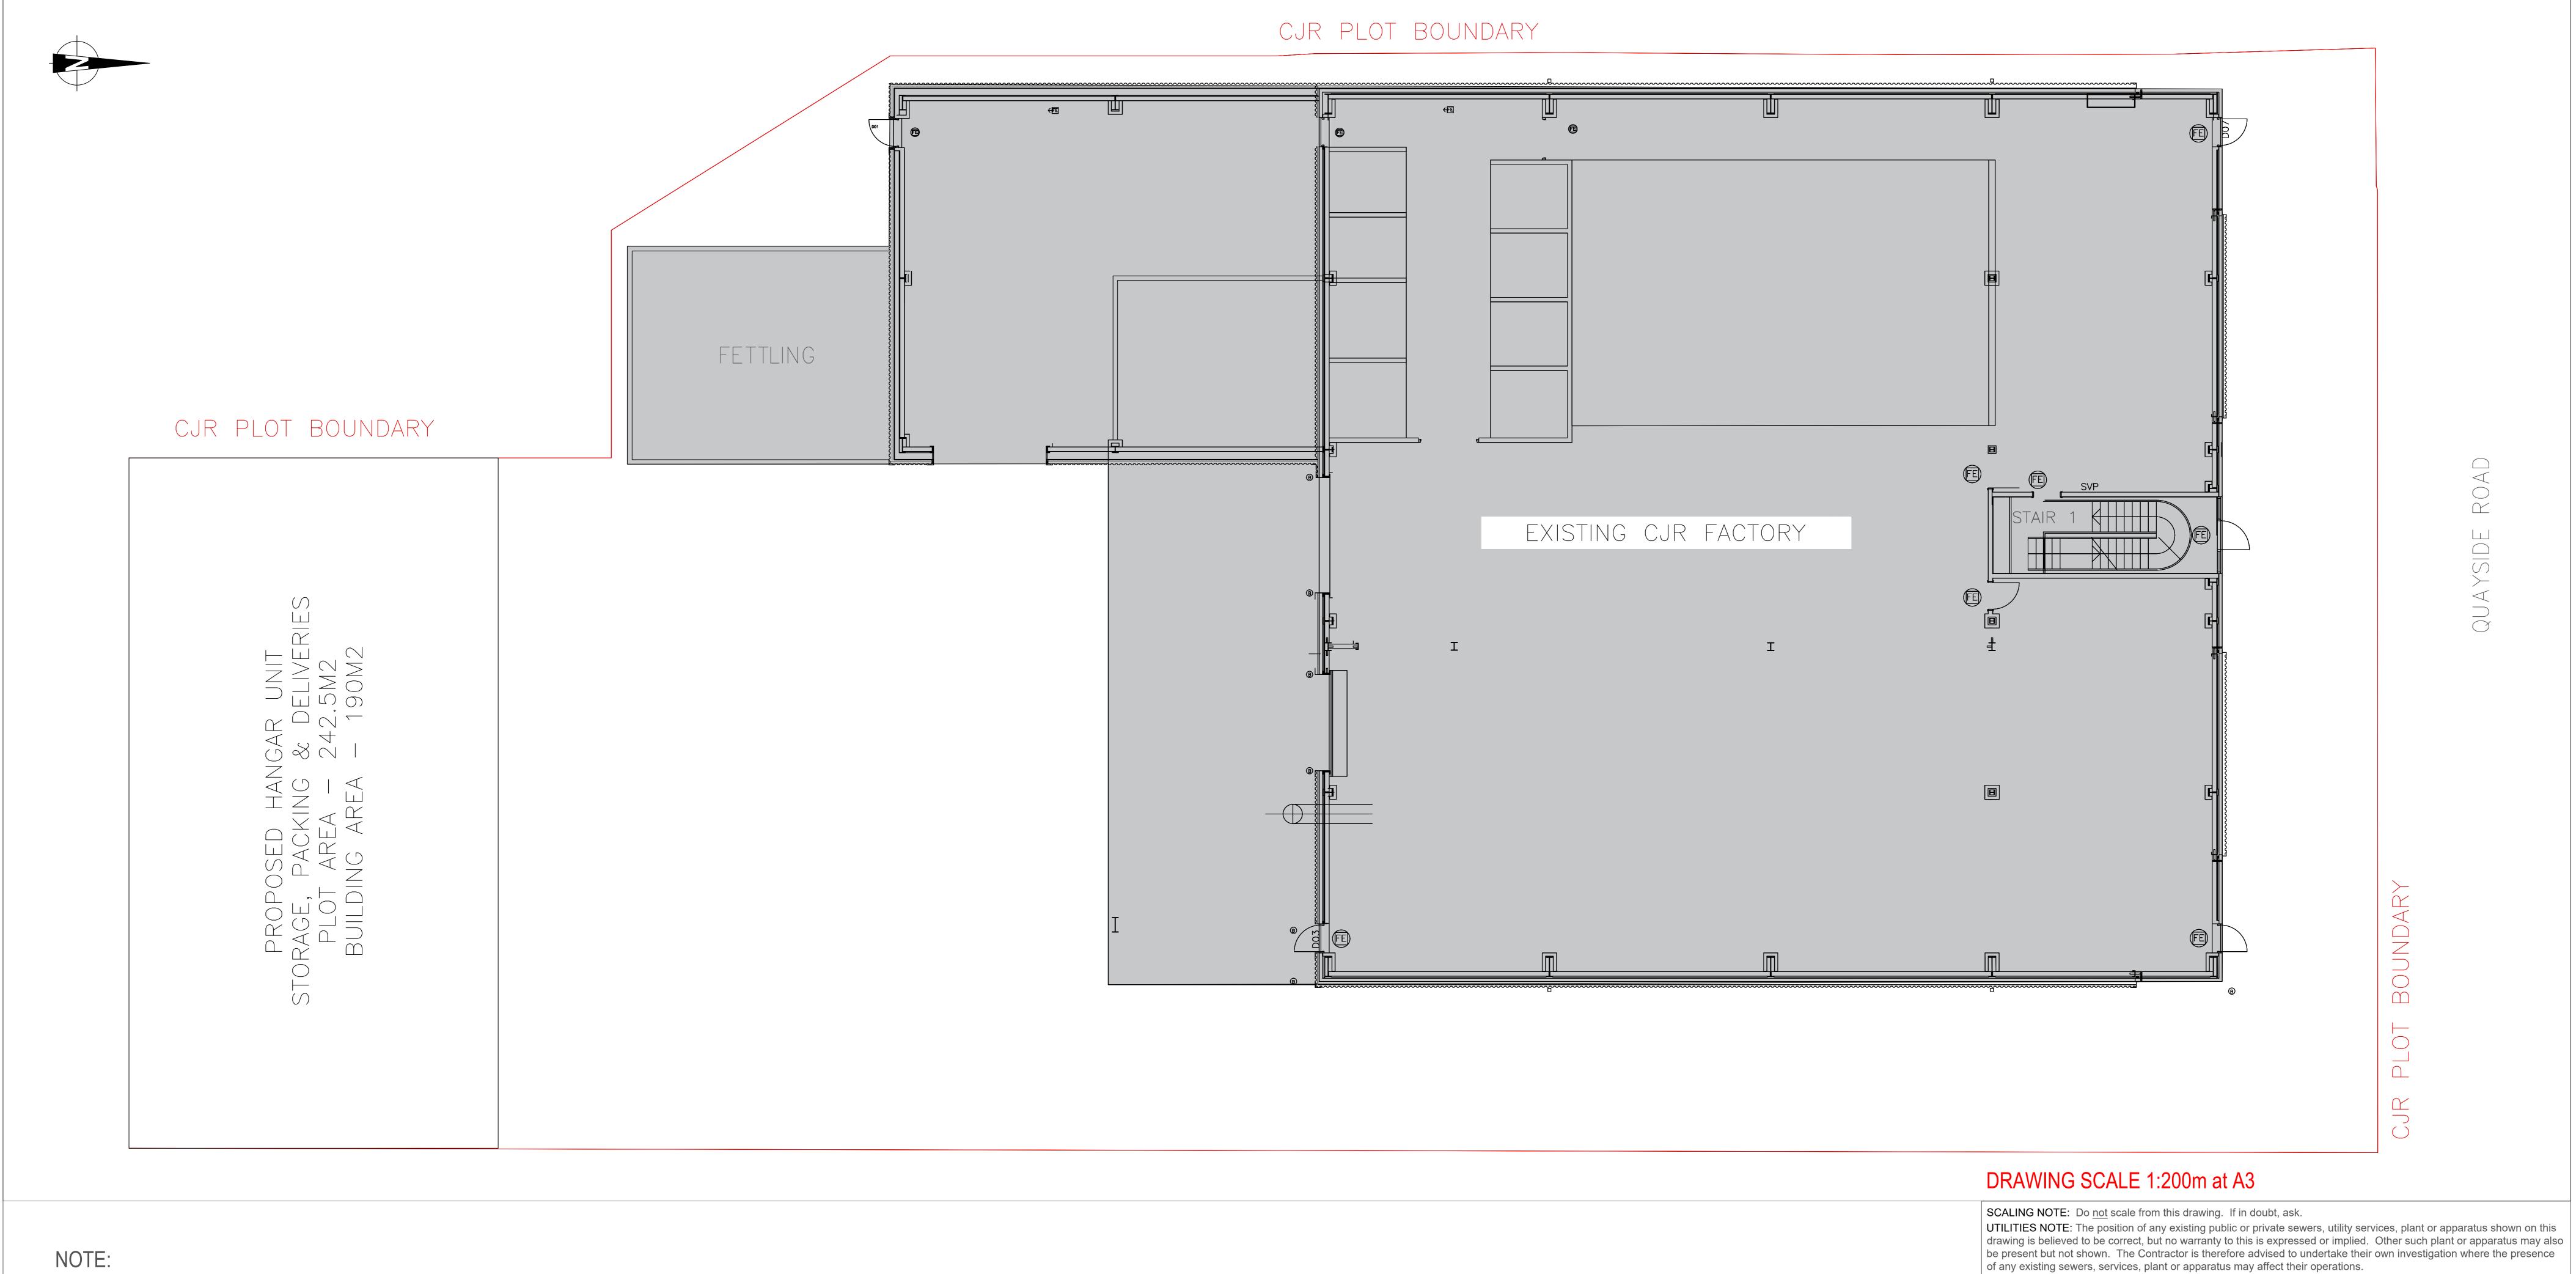

- REFER TO IMAGE LAYOUT PLAN FOR PHOTOS.
- REAR IMAGES SHOWN IN GREEN. Ζ.
- FRONT IMAGES SHOWN IN PURPLE. 3.


	]	

PULSION TED	
ILU	
 Drawn OLIVER GOO	DLEY
Approved MARK RUSSE	ELL
	Revision

## NEW HANGAR UNIT, LOCATED REAR YARD


### SION LIMITED

## FOR INFORMATION ONLY

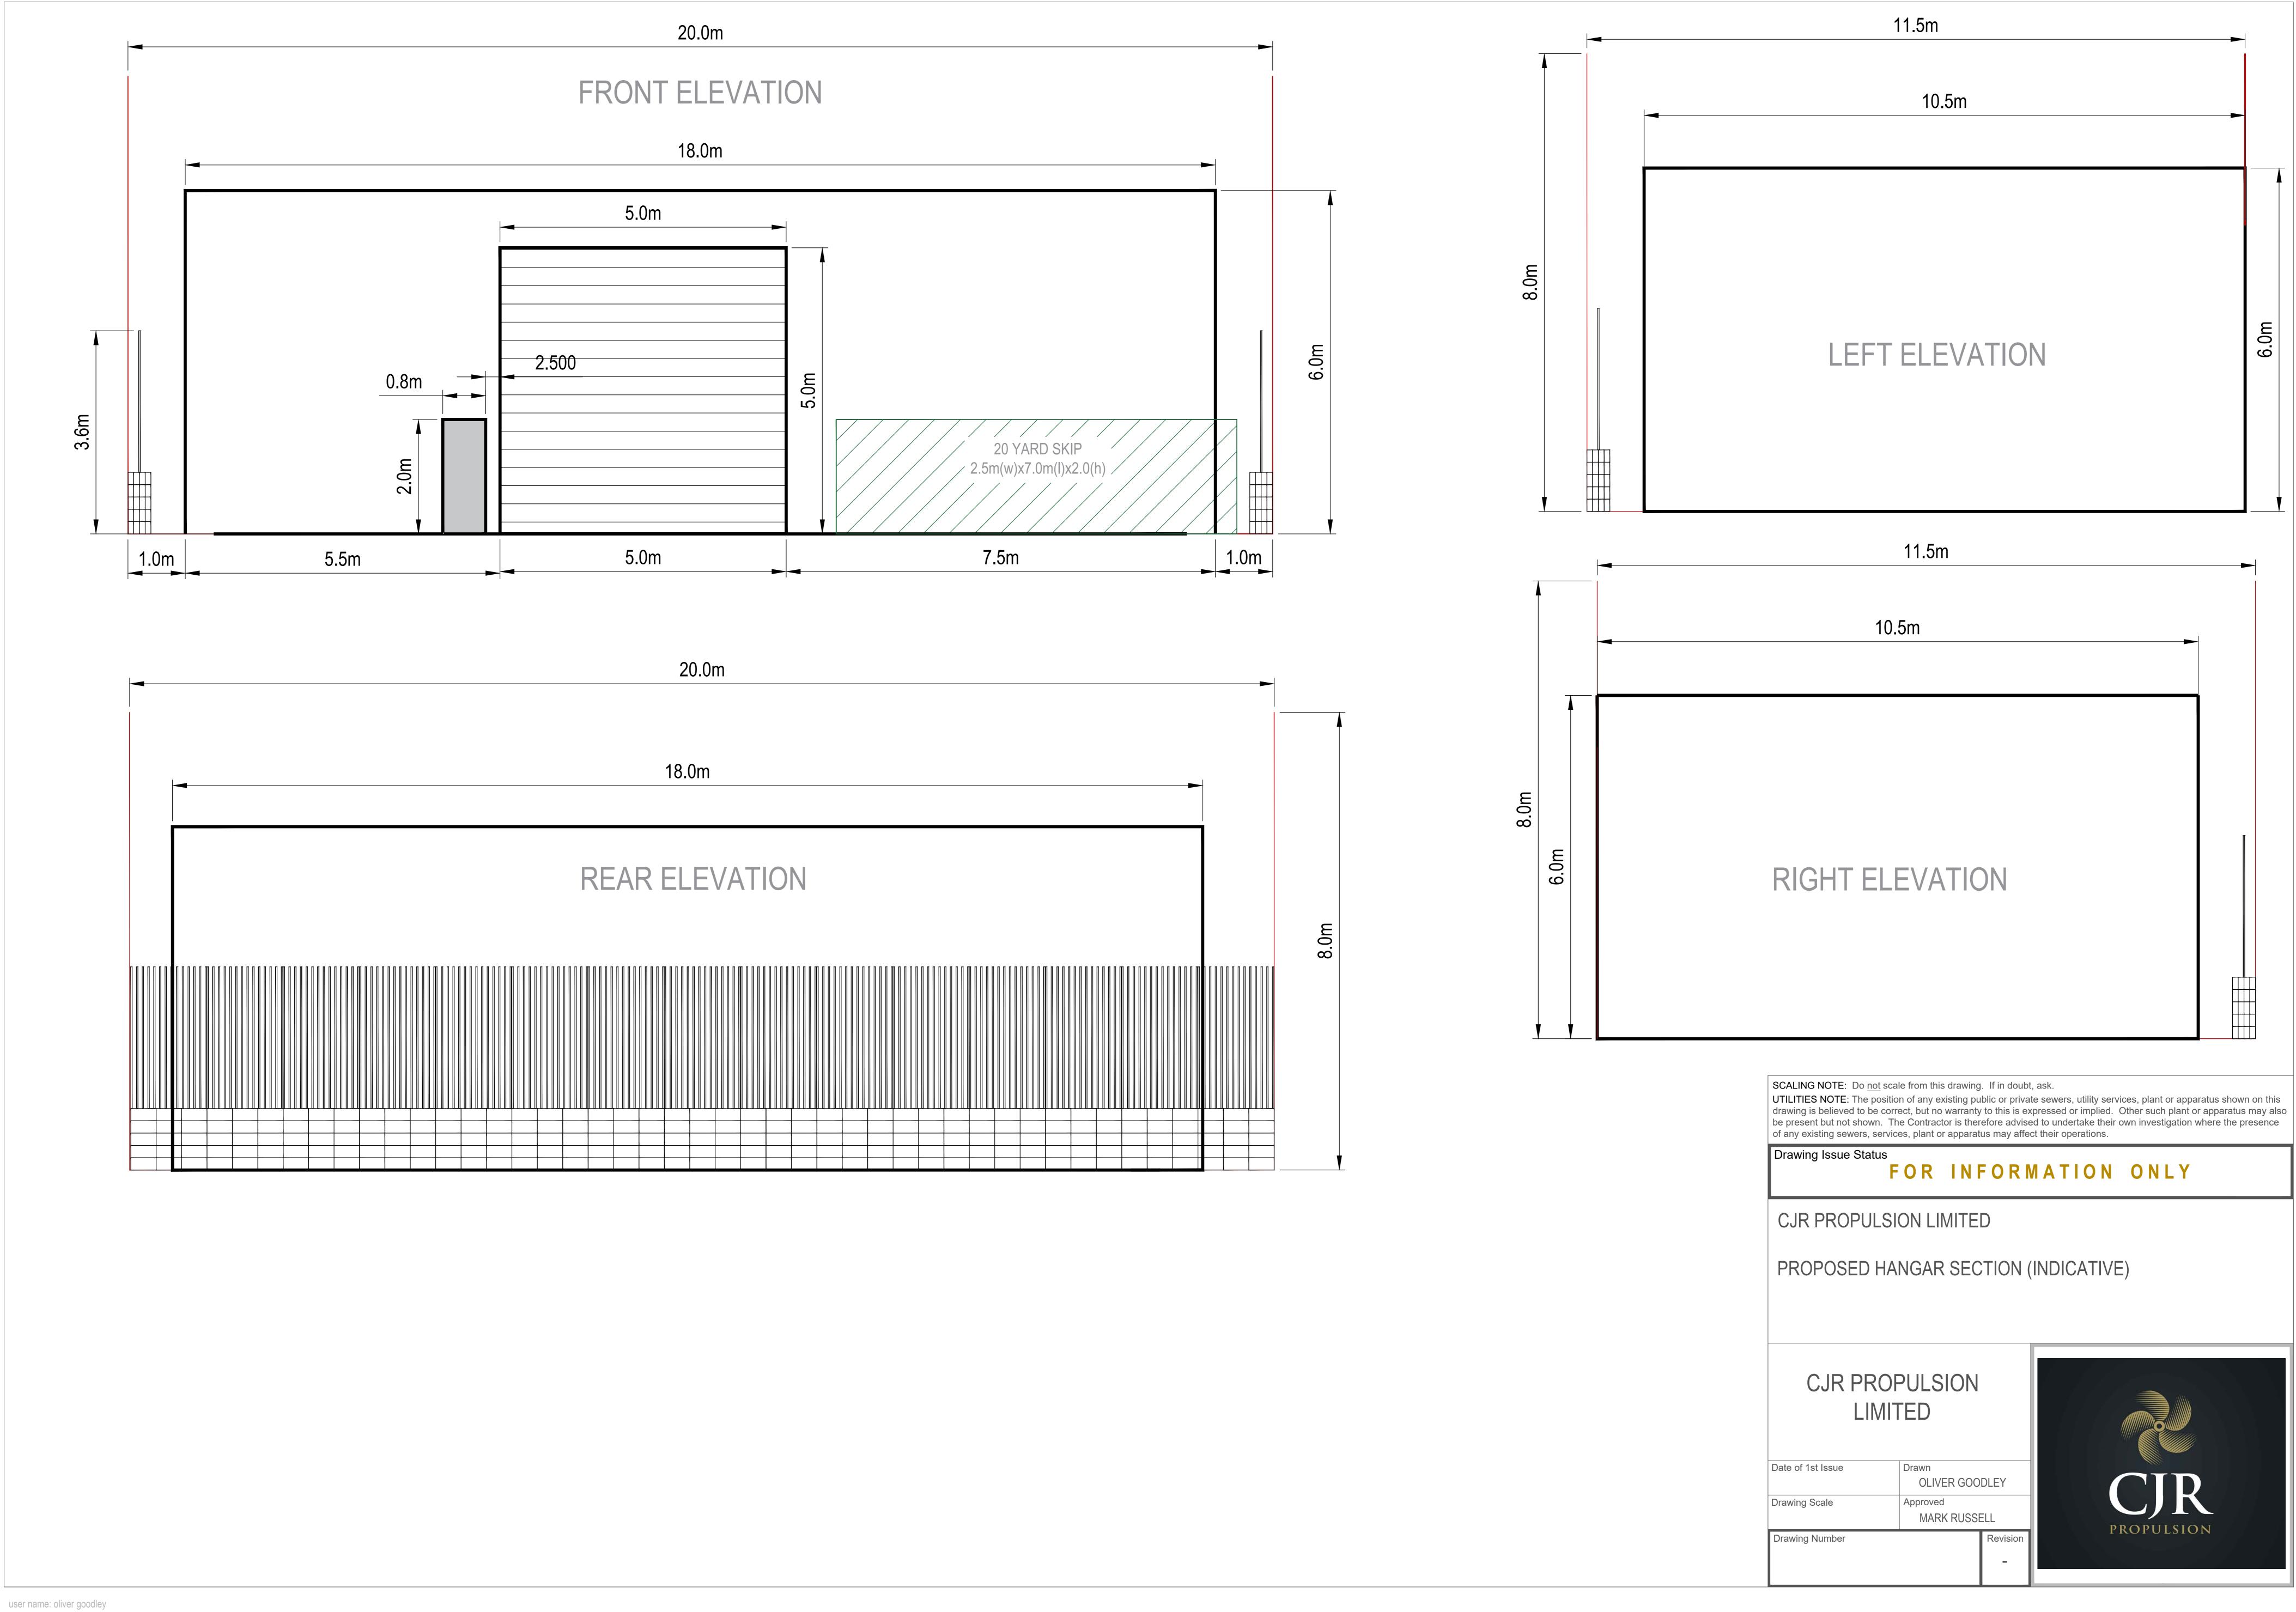

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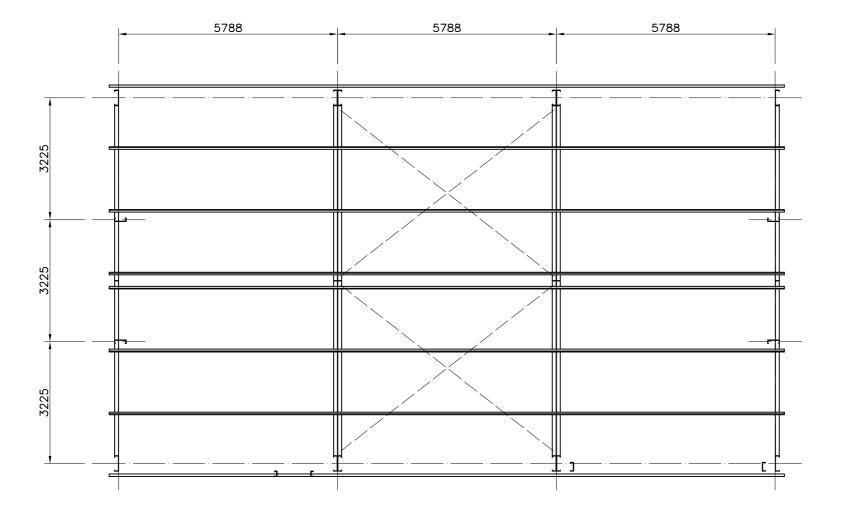
### Base Plan

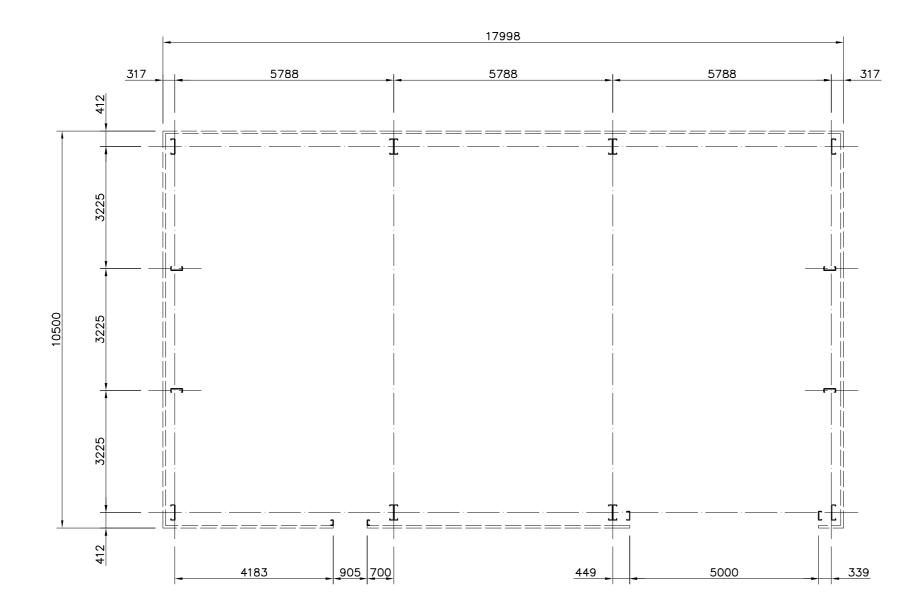

Notes:		
Revisions:		
<b>/</b> Omega	Steel Building S	Solutions
A456 Longb	usiness Park bank, Bewdle ire, DY12 21	
	2 544210	
omegasteelbuil	dingsoutions.	co.uk
Steel Framed Building		
at Southampton, S018 1AD		
for CJR Propulsion LTD		
23/02/2022	Scale: 1 : 1(	00
Base	Plan	
SCN1943	01	


### Roof Plan

-()





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Omoga		
<b>/</b> Omega	Steel Building S	olutions
A456 Longt	usiness Park oank, Bewdle ire, DY12 21	
Tel 0156	2 544210	
omegasteelbuil	dingsoutions.	co.uk
Steel Framed Building		
at Southampton, S018 1AD		
for CJR Propulsion LTD		
23/02/2022	Scale: 1 : 1(	00
Roof	Plan	
SCN1943	02	

### Right Gable Elevation

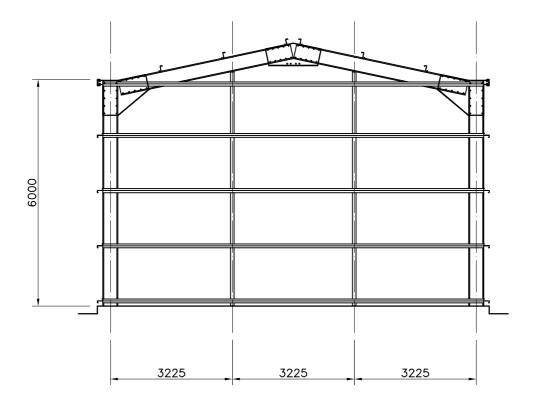


#### Left Gable Elevation

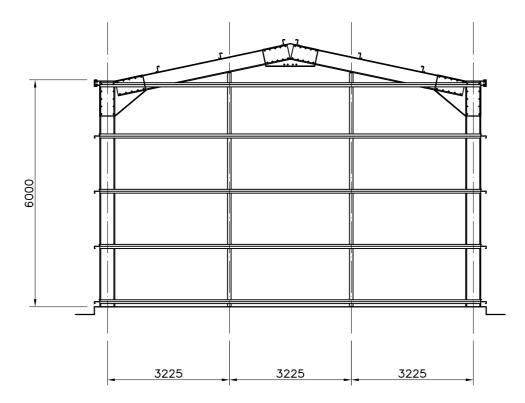


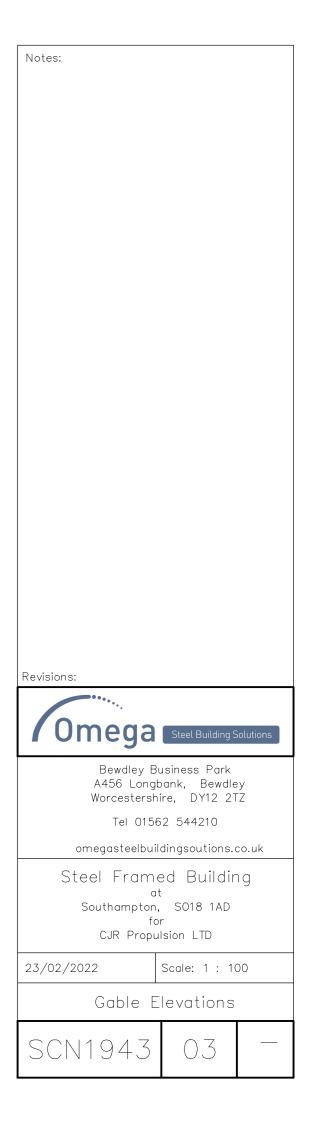

## Back Elevation

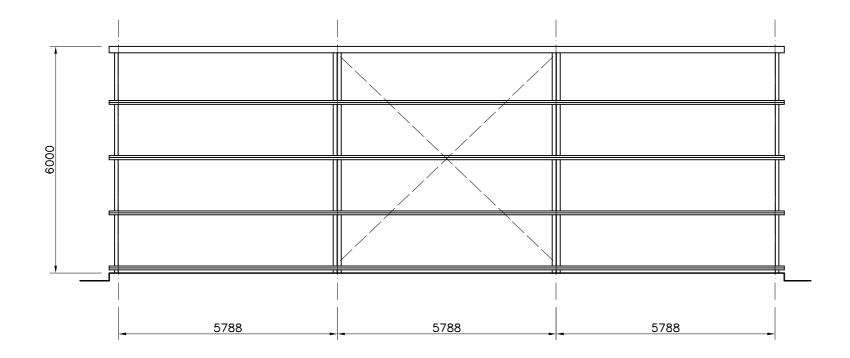


Front Elevation

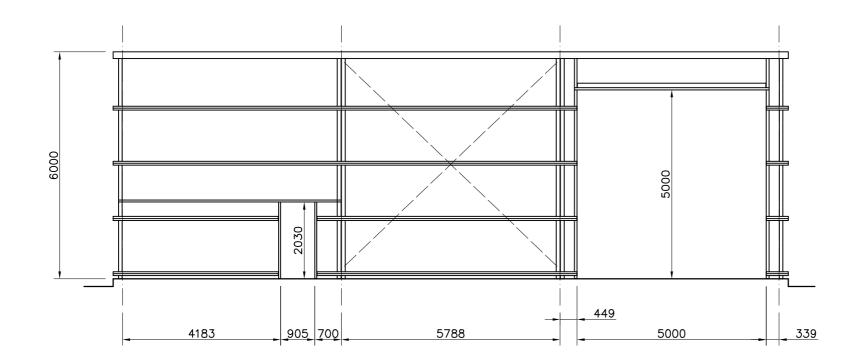


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<b>/</b> Omega	Steel Building S	Solutions
A456 Long	usiness Park oank, Bewdle ire, DY12 21	
	52 544210	2
omegasteelbui	ldingsoutions.	co.uk
Steel Framed Building		
at Southampton, S018 1AD		
for CJR Propulsion LTD		
23/02/2022	Scale: 1 : 10	00
Front and	Back Elev	vations
SCN1943	04	

## Cross Section

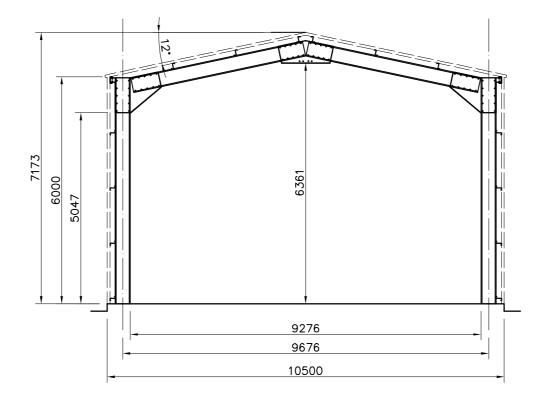


Notes:		
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Omoga		
<b>/</b> Omega	Steel Building S	olutions
A456 Long	usiness Park bank, Bewdle ire, DY12 21	
Tel 0156	62 544210	
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Steel Framed Building		
at Southampton, S018 1AD		
for CJR Propulsion LTD		
23/02/2022	Scale: 1 : 1(	00
Cross	Section	
SCN1943	05	

## Back Elevation

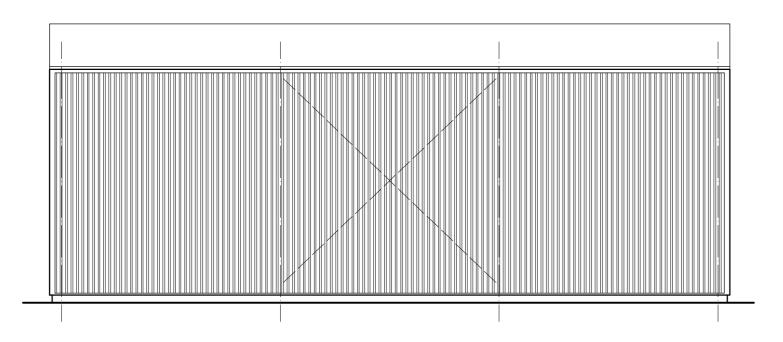


## Front Elevation

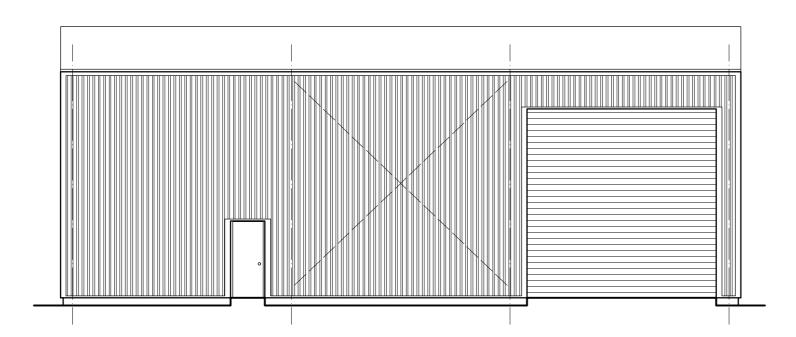



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fc CJR Propu		
23/02/2022	Scale: 1 : 10	00
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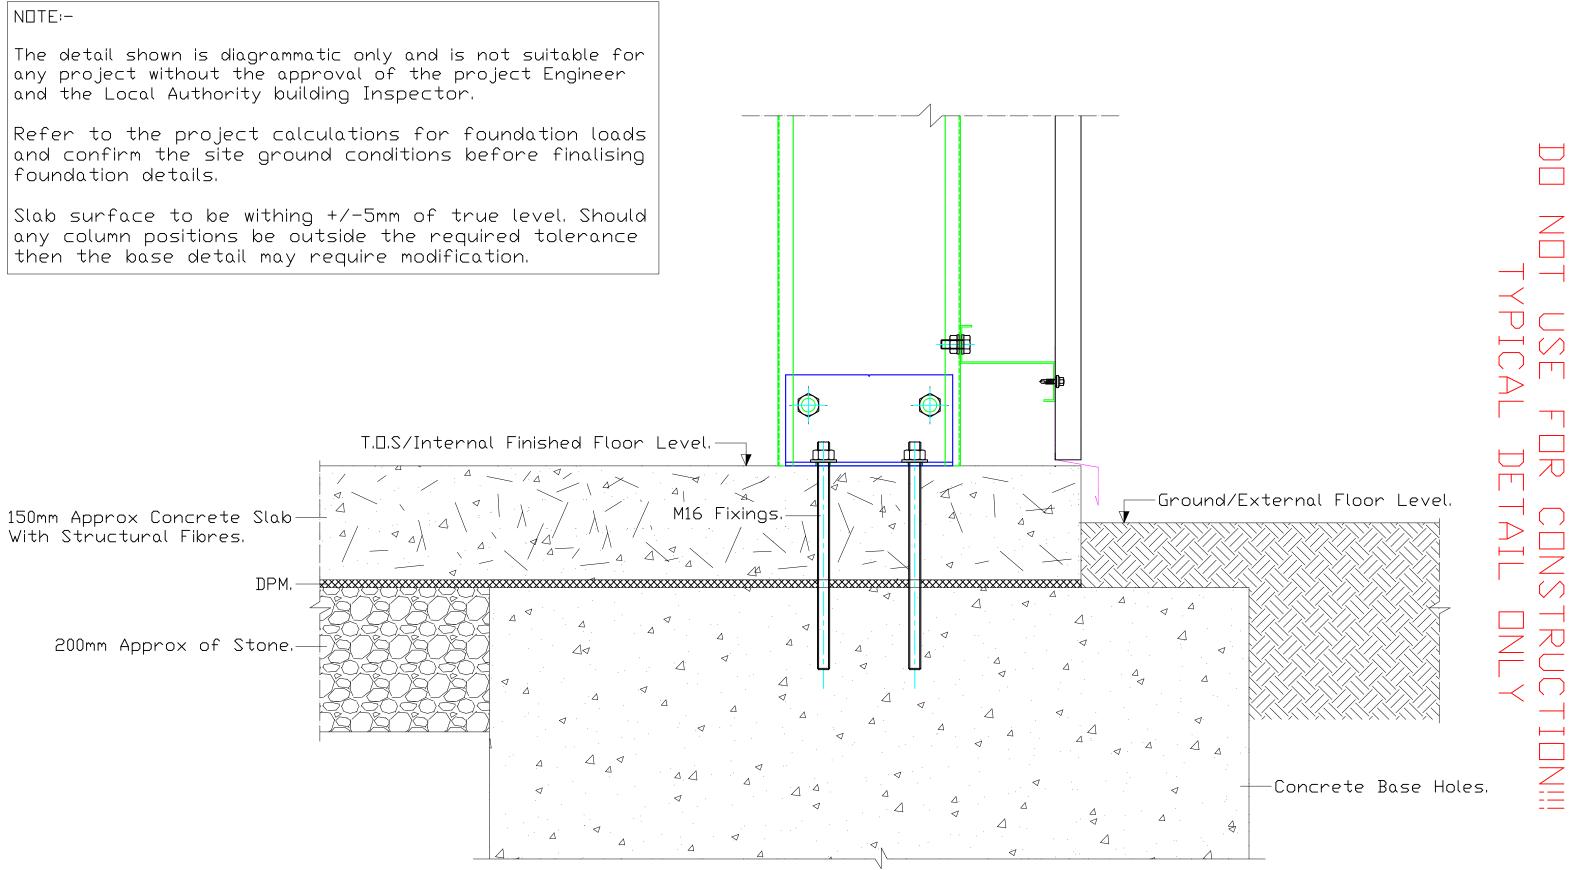
### Right Gable Elevation

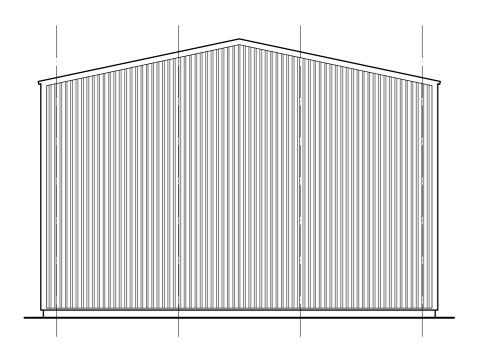

#### Left Gable Elevation




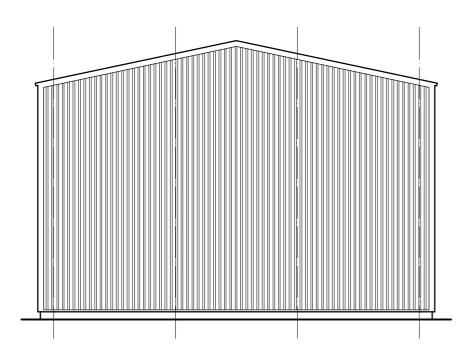

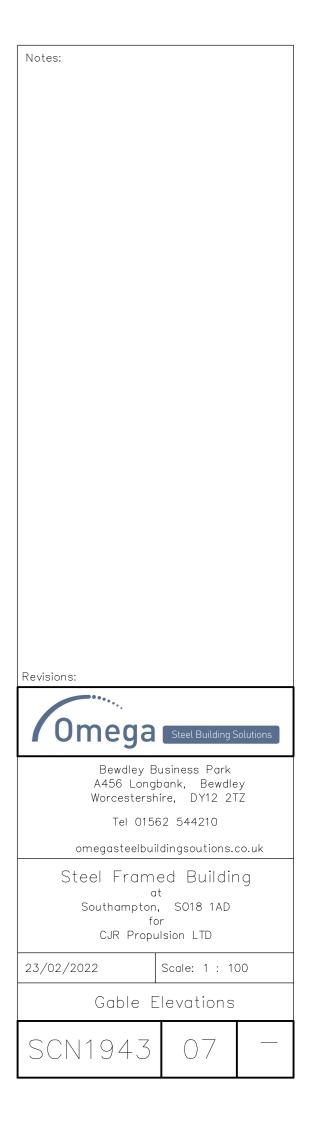


#### TYPICAL BASE DETAIL,



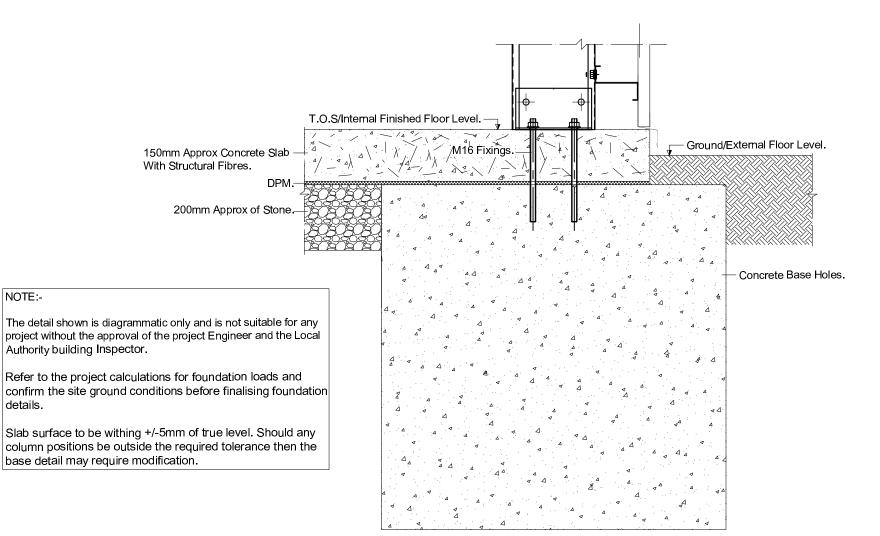

#### ENLARGED SECTION THROUGH ON BASE HOLES, SLAB AND MAIN COLUMN.

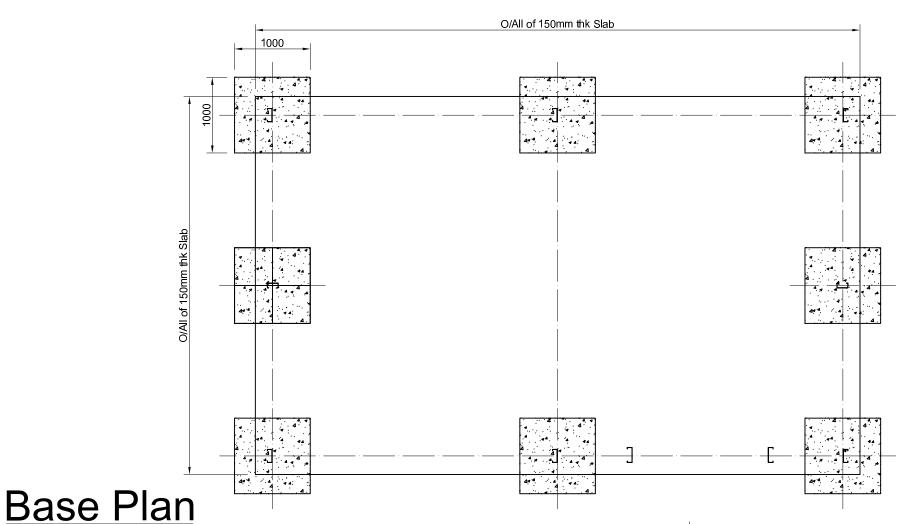

TYPICAL CONCRETE BASE HOLE ARRANGEMENT. (Not Construction issue Drawings)

Notes:




Bewdley Business Park A456 Longbank, Bewdley Worcestershire, DY12 2TZ

Tel 01562 544210

omegasteelbuildingsoutions.co.uk

Typical Ground Works Base Detail

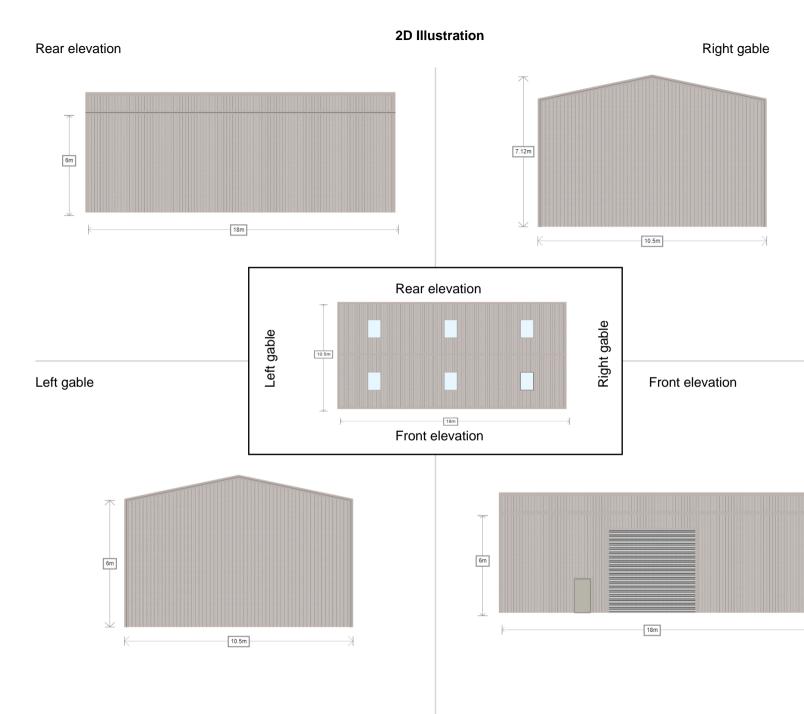




Bewdley Business Park Longbank Bewdley Worcestershire DY12 2TZ Tel 01562 544210 Email sales@steelbuildings.co.uk

Ref:-090222-0505 - RevB Site Address:-CJR Propulsion, 70-72 Quayside Road, Soutt Roof Pitch:- 12 Roof Cladding:-Kingspan RW 40mm Core Composite Panel Left Gable Cladding:-Kingspan RW 40mm Core Composite Panel Right Gable Cladding:-Kingspan RW 40mm Core Composite Panel Front Elevation Cladding:-Kingspan RW 40mm Core Composite Panel Rear Elevation Cladding:-Kingspan RW 40mm Core Composite Panel Rear Elevation Cladding:-Kingspan RW 40mm Core Composite Panel Rear Elevation Cladding:-Kingspan RW 40mm Core Composite Panel Rain Water system:- Trimline Roof Colour:- Goosewing Grey Wall Colour:- Goosewing Grey Rainwater System Colour:- Goosewing Grey

This drawing is for illustration purposes only and not a technical drawing. Door locations and sizes are indicative and may require adjustment,once final design and detailing is complete.

Full Technical drawings will be issued for approval with placement of order, along with a detailed order confirmation confirming full spec of building to be supplied

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Email sales@steelbuildings.co.uk

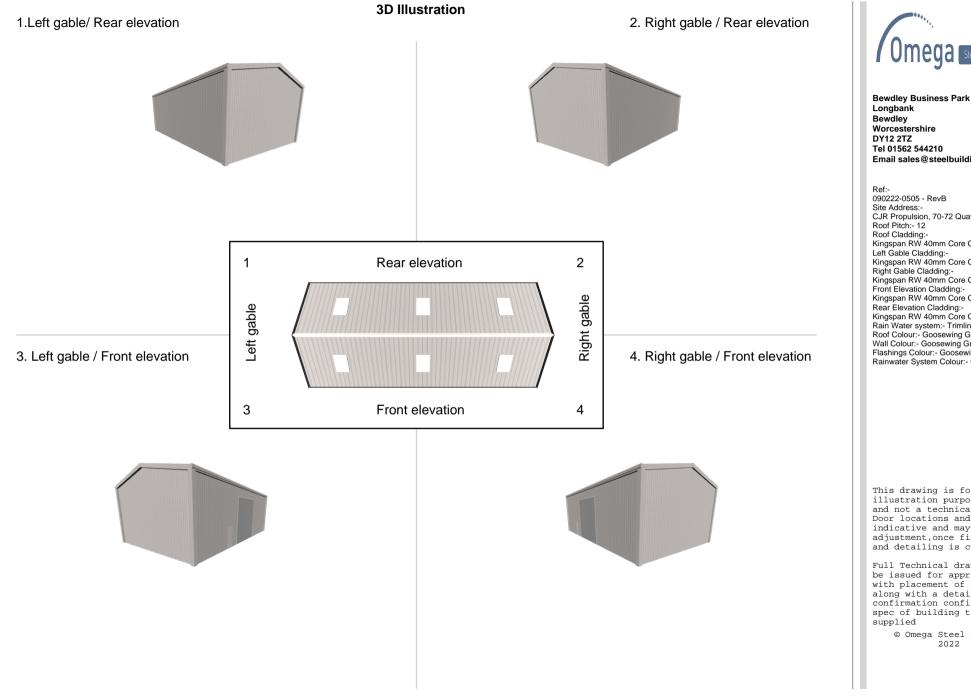CJR Propulsion, 70-72 Quayside Road, South Roof Cladding:-Kingspan RW 40mm Core Composite Panel Left Gable Cladding:-Kingspan RW 40mm Core Composite Panel Right Gable Cladding:-Kingspan RW 40mm Core Composite Panel Front Elevation Cladding:-Kingspan RW 40mm Core Composite Panel Rear Elevation Cladding:-Kingspan RW 40mm Core Composite Panel Rain Water system:- Trimline Roof Colour:- Goosewing Grey Wall Colour:- Goosewing Grey Flashings Colour:- Goosewing Grey Rainwater System Colour:- Goosewing Grey

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Full Technical drawings will be issued for approval with placement of order, along with a detailed order confirmation confirming full spec of building to be

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# HANGAR MATERIALS

- STEEL SUPERSTRUCTURE. 1.
- INSULATED EXTERIOR CLASSING (POLYMER OR SIMILAR). 2.
- GALVANIZED STEEL ROLLER DOORS. 3.



# SECURITY WALL/FENCING MATERIALS

- CONCRETE BRICKWORK. 1.
- BRICKWORK STEEL MESH. 2.
- PALISADE FENCING (2.5m). 3.





<b>H</b> HH







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