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GENERAL NOTES

. CHECK ALL DIMENSIONS ON SITE.

. ALL DIMENSIONS ARE IN MILLIMETRES UNLESS OTHERWISE STATED.

. ALL VERTICAL MEASUREMENTS ASSUME GROUND TO

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FINISH FLOORING IS INSTALLED ABOVE THE FLOOR LINE. FOR DEPRESSED FLOORS AND CURBS, SEE STRUCTURAL 13. REPETITIVE FEATURES ARE NOT ALWAYS DRAWN IN THEIR ENTIRETY AND SHALL BE COMPLETELY PROVIDED

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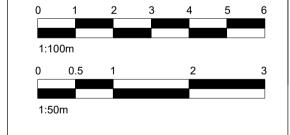
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Bischell - Design & Build -Suite 114 80 Cumberland House, Scrubs Lane Hammersmith & Fulham, NW106RF

27 Welland Gardens Perivale Greenford UB6 8SZ

Date: 28/06/2022

Cover

**BUILDING REGULATIONS DRAWINGS** FOR BUILDING CONTROL APPROVAL ONLY AND ARE NOT TO BE USED AS CONSTRUCTION DRAWINGS

27 WELLAND GARDENS PERIVALE GREENFORD **UB6 8SZ** 

# **GENERAL NOTES**

- 1. THE STRUCTURAL SPECIFICATION WITHIN THIS DOCUMENT IS TO BE READ IN CONJUNCTION WITH ALL RELEVANT ARCHITECTURAL DRAWINGS.
- THE STANDARD NOTES THAT ARE CONTAINED ON THE DRAWINGS AND ANY OTHER RELEVANT PROJECT INFORMATION.
- 2. THE DRAWINGS WITHIN THIS DOCUMENT ARE INDICATIVE ONLY, AND REPRESENT DESIGN INTENT ONLY. NO DIMENSIONS ARE TO BE SCALED FROM DRAWINGS CONTAINED WITHIN THIS DOCUMENT. REFER TO THE ARCHITECTURAL DRAWINGS FOR ALL DIMENSIONS. ALL DIMENSIONS SHOULD BE CHECKED ON SITE BY THE CONTRACTOR BEFORE FABRICATION AND ORDERING OF MATERIALS.
- 3. UNLESS NOTED OTHERWISE, ALL DIMENSIONS ARE IN MILLIMETRES AND ALL LEVELS ARE IN METRES FROM THE SITE DATUM.
- 4. THE INFORMATION WITHIN THIS DOCUMENT CANNOT BE GUARANTEED AS DIMENSIONALLY EXACT. FIGURED DIMENSIONS MUST BE USED FOR SETTING OUT AND DETAILING.
- 5. THE CONTRACTOR IS RESPONSIBLE FOR THE DESIGN OF ALL TEMPORARY WORKS, AND IS ALSO RESPONSIBLE FOR THE SAFE MAINTENANCE AND STABILITY OF THE EXISTING BUILDING/S AT ALL TIMES.
- 6. ALL PARTY WALL AWARDS ARE ENTIRELY THE RESPONSIBILITY OF THE CLIENT
- 7. THE CONTRACTOR (OR CLIENT) MUST REPORT ANY DIFFERENCES BETWEEN THE STRUCTURAL DRAWINGS AND SITE CONDITIONS TO THE
- 8. THE CONTRACTOR (OR CLIENT) MUST NOTIFY THE STRUCTURAL ENGINEER OF ANY DESIGN CHANGES THAT COULD AFFECT THE STRUCTURAL SPECIFICATION BEFORE WORK COMMENCES.
- 9. THE CONTRACTOR SHALL AT THE OUTSET, ESTABLISH WITH THE LOCAL AUTHORITY THEIR REQUIREMENTS FOR INSPECTING THE WORKS, AND
- 10. ALL DIMENSIONS AND LEVELS SHOWN ON THE DRAWINGS ARE BASED ON SURVEY DRAWINGS AND THE CONTRACTOR IS TO SATISFY HIMSELF THAT DIMENSIONS, LEVELS, ETC., ARE SUFFICIENTLY ACCURATE AND COMPLETE FOR FABRICATION WITHIN THE SPECIFIED TOLERANCES OF ALL PREFABRICATED FI FMENTS.
- 11. IF IN DOUBT ABOUT THE INFORMATION SHOWN OT THIS DRAWING OR ANY RELATED DRAWINGS PLEASE ASK.
- 12. THE CONTRACTOR HAS SOLE RESPONSIBILITY FOR THE DESIGN OF ALL TEMPORARY WORKS.
- 13. ALL LINTELS TO HAVE A MINIMUM 150mm END BEARING INTO NEW/EXISTING WALL
- 14. ALL EXISTING LINTELS ARE TO BE INSPECTED AND REPLACED IF THEY SHOW SIGNS OF DETERIORATION, CRACKING OR DISTRESS. THE MATERIAL NATURE OF ANY REPLACEMENT IS TO BE APPROVED BY THE LOCAL AUTHORITY PRIOR TO INSTALLATION.
- 15. ALL EXISTING WALLS TO BE EXAMINED BY THE CONTRACTOR FOR LACK OF BOND/DELAMINATION, ETC. IF SUCH AREAS ARE NOTED, THE CLIENT'S ENGINEER IS TO BE INFORMED IMMEDIATELY. THE CONTRACTOR SHALL ARRANGE FOR THE DESIGN AND INSTALLATION OF A SUITABLE
- 16. SHOULD ANY EXISTING WALL PROVE TO BE INADEQUATELY RESTRAINED, THE CONTRACTOR ALLOW FOR THE DESIGN AND INSTALLATION OF
- SUITABLE REMEDIAL WORKS TO PROVIDE ADEQUATE LATERAL RESTRAINT AND SUBMIT THE DESIGN TO THE LOCAL AUTHORITY FOR APPROVAL.

  17. THE CONTRACTOR IS TO PROVIDE TEMPORARY WORKS TO PROVIDE LATERAL AND VERTICAL RESTRAINT TO EXISTING WALLS PRIOR TO DEMOLITION OF ANY PART OF THE EXISTING BUILDING COMMENCING.
- 18. IN ALL CASES THE EXISTING WALLS WILL REQUIRE THE FOLLOWING REMEDIAL WORKS: i) ALL EXISTING STEELWORK AND TIMBERS REQUIRED TO BE CAREFULLY REMOVED. THE CONTRACTOR SHOULD OBTAIN THE APPROVAL OF THE RELEVANT LOCAL AUTHORITIES PRIOR TO THIS WORK
- ii) ALL MINOR CRACKS TO BE REPAIRED USING 1:1:6 MORTAR.
- iii) ANY MORTAR/BRICKWORK THAT IS JUDGED BY THE CONTRACTOR OR THE CLIENT'S ENGINEER OR THE LOCAL AUTHORITY REPRESENTATIVE TO BE CRUMBLY, SOFT, DETERIORATED, ETC., IS TO BE REMOVED AND REBUILT IN BONDED ENGINEERING BRICK, FACING BRICK OR BLOCK AS
- iv) all existing internal masonry wall openings no longer required are to be in-filled in bonded brick/block as appropriate.
- v) all straight joints are to be tied across by means of proprietary galvanized steel strapping.
- vi) IF CRACKS WITH AN APERTURE GREATER THAN 2mm ARE UNCOVERED, THE CONTRACTOR SHALL PROVIDE STITCHING USING 900mm LONG x 100mm WIDE x 65mm DEEP PRE-CAST CONCRETE LINTELS AT 900mm CENTRES VERTICALLY. THE LINTELS ARE TO BE INSERTED ON A 1:1:6 MORTAR BED AND PACKED WITH A 1:1:6 SEMI-DRY MORTAR WELL RAMMED.
- 19. JOISTS ARE TO BE DOUBLED-UP BELOW ALL STUD PARTITIONS. THE JOISTS TO BE BOLTED TOGETHER AT 600mm CENTRES USING M12 GR. 4.6 BOLTS WITH 50mm SQUARE PLATE WASHERS EACH SIDE AND DOUBLE SIDED TOOTHED PLATE CONNECTORS.

## STEELWORK NOTE

- 1. STRUCTURAL STEELWORK DESIGN TO BS5950-1:2000.
- 2. DESIGN, FABRICATION AND ERECTION OF STRUCTURAL STEELWORK TO COMPLY WITH THE LATEST EDITION OF THE NATIONAL STRUCTURAL
- STEELWORK SPECIFICATION (N.S.S.S.)
- 3. THE ENDS OF ALL BEAMS ARE TO BE PROPERLY SAWN/MACHINED, IN THE FABRICATION WORKSHOP, TO ENSURE A CLOSE BEARING FIT BETWEEN FLANGES AND END PLATES.
- 4. ALL HOT ROLLED STRUCTURAL STEELWORK TO BE MILD STEEL TO GRADE S275JR TO BS EN 10025:1993, AND HOLLOW SECTIONS GRADE S355J2H TO BS EN 10210-1.
- 5. INTERNAL STEELWORK TO BE BLAST CLEANED TO SA21
- EXTERNAL STEELWORK TO BE EITHER BLAST CLEANED TO SA21
- HOT DIPPED GALVANISED (85 MICRONS).
- 6. THE STEELWORK FABRICATOR IS TO CONDUCT AN ACCURATE SITE SURVEY TO DETERMINE FINAL DIMENSIONS FOR ALL NEW STEELWORK PRIOR TO FABRICATION. THE SURVEY SHOULD HIGHLIGHT ANY EXISTING OBSTRUCTIONS, SERVICES, ETC. THAT NEED TO BE
- ALTERED/RELOCATED TO AVOID CLASH.
- 7. ALL BOLTS TO BE BE GRADE 8.8 IN ACCORDANCE WITH EN ISO 1461 UNLESS NOTED OTHERWISE ON THE DRAWINGS.
- 8. WELD TESTS TO BE CARRIED OUT TO COMPLY WITH THE LATEST EDITION OF 'THE NATIONAL STRUCTURAL STEELWORK SPECIFICATION FOR BUILDING CONSTRUCTION'. 'FLUID' IS TO BE PROVIDED WITH COPIES OF ALL WELD TEST RESULTS.
- 9. ALL STEEL BEAMS AND COLUMNS ARE TO BE FIRE PROTECTED IN ACCORDANCE WITH THE SURVEYORS DETAILS AND CURRENT BUILDING REGULATIONS. ALLOW MINIMUM 60 MINUTES, UNLESS NOTED OTHERWISE.

# FOUNDATION AND GROUND FLOOR NOTES:

- 1. THE MAIN CONTRACTOR TO ENSURE THAT THE GROUND BEARING STRATA, MINIMUM BEARING DEPTHS AND GENERAL RECOMMENDATIONS OF THE SOIL INVESTIGATION ARE ADHERED TO.
- 2. THE MAIN CONTRACTOR TO UNDERTAKE EXPLORATORY EXCAVATIONS ADJACENT TO ANY EXISTING BUILDINGS AND SERVICES TO DETERMINE NATURE AND DEPTH OF EXISTING FOOTINGS ETC. CONTRACTOR TO ENSURE THAT ALL FOUNDATIONS TO EXISTING BUILDINGS AND UNDERGROUND SERVICES ARE NOT UNDERMINED OR DISTURBED IN ANY WAY DURING THE CONSTRUCTION WORKS.
- 3. CONTRACTOR TO BE RESPONSIBLE FOR ALL TEMPORARY WORKS DURING CONSTRUCTION OF THE SUPERSTRUCTURE AND FOUNDATIONS TO ENSURE THAT ALL ADJACENT BUILDINGS, ROADS, FOOTPATHS AND SERVICES ETC. REMAIN STABLE AND FREE FROM DAMAGE.
- 4. FOUNDATIONS ARE TO BE TAKEN DOWN TO THE DEPTHS SHOWN ON THIS DRAWING. TO BE CHECKED ON-SITE BY BUILDING CONTROL OFFICER/ENGINEER PRIOR TO CONSTRUCTION.
- 5. UNLESS NOTED OTHERWISE THUS: (600) ALL FOUNDATIONS TO BE A MINIMUM 600MM WIDE. CENTRED ON THE GRID LOCATION OVER.
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  6. ALL FORMATION LEVELS, SHUTTERS AND REINFORCEMENT TO BE CHECKED ON-SITE BY THE BUILDING CONTROL OFFICER PRIOR TO CONSTRUCTION.
- 7. ANY EXCAVATIONS LIABLE TO REMAIN EXPOSED TO THE ELEMENTS IN EXCESS OF 24 HOURS PRIOR TO CONCRETING (OR LESS IN INCLEMENT WEATHER) ARE TO RECEIVE 50MM PROTECTIVE BLINDING CONCRETE.
- 8. IN COHESIVE SOILS THE VERTICAL FACES OF ALL EXCAVATIONS MUST BE SUFFICIENTLY SMOOTH TO ALLOW MOVEMENT OF THE SOIL TO TAKE PLACE WITHOUT DISTURBING THE FOUNDATION.
- 9. FOUNDATIONS MAY BE TRENCH FILLED BUT THE TOP LEVEL OF CONCRETE MUST SUIT BRICK COURSING AND FINAL GROUND LEVELS.
- 10. NO SERVICE MAY BE BUILT THROUGH OR CAST INTO FOUNDATIONS WITHOUT THE ENGINEERS APPROVAL.
- 11. WHERE BLOCKWORK WALLING BELOW GROUND LEVEL IS IN EXCESS OF 900MM HIGH THEN 215MM THICK BLOCK WORK IS TO BE ADOPTED (BLOCKS LAID FLAT AND COURSED TO 225MM VERTICAL CENTERS). BACK FILLING IS TO BE CARRIED OUT EQUALLY EITHER SIDE OF WALLING AND TO BE OF AN APPROVED, WELL GRADED GRANULAR MATERIAL.
- 12. FOR EXISTING MANHOLES/DRAINRUNS/SERVICES REFERENCE IS TO BE MADE TO THE ARCHITECTURAL DRAWINGS. THE DEPTH AND POSITIONS OF ALL EXISTING SERVICES ARE TO BE CHECKED ON SITE BY THE CONTRACTOR PRIOR TO COMMENCING WORK AND ANY VARIATION WITH THE ARCHITECTURAL DRAWINGS IS TO BE REPORTED TO THEM PRIOR TO PROCEEDING. IF ANY DAMAGE IS CAUSED TO THE EXISTING RUNS/SERVICES DURING THESE WORKS BY THE CONTRACTOR ANY MAKING GOOD WILL BE AT THE CONTRACTORS OWN COST

#### MASONRY NOTE

- 1. ALL MASONRY IS DESIGNED, AND SHALL BE CONSTRUCTED IN ACCORDANCE WITH BS 5628-1:2005 PLUS ALL LATEST AMENDMENTS, INCLUDING ADEQUATE RESTRAINT AS DETAILED IN ANNEX 'D'
- 2. BRICK AND BLOCK STRENGTHS SHOWN ARE MINIMUM REQUIRED AND SHOULD BE INCREASED AS NECESSARY TO SUIT COURSING. CUT BRICKS/BLOCKS BELOW PADSTONE'S WILL NOT BE ACCEPTED.
- 3. TEST CERTIFICATES CONFIRMING BRICK AND BLOCK CRUSHING STRENGTHS WILL BE REQUIRED FOR ENGINEERS APPROVAL
- 4. WALLS BELOW GROUND LEVEL ARE TO BE BUILT UP IN DENSE CONCRETE BLOCKWORK (MINIMUM 7.0KN/MM²) INNER AND OUTER LEAVES IN 1:14:3 MORTAR, WITH LEAN MIX CONCRETE CAVITY FILL UP TO 150MM BELOW GROUND LEVEL.
- 5. WALLS ABOVE GROUND LEVEL TO BE BUILT UP IN 1:1:6 MORTAR (CEMENT:LIME:SAND) OR EQUIVALENT UNLESS SHOWN OTHERWISE.
- 6. WHERE BLOCKWORK WALLING BELOW GROUND IS IN EXCESS OF 900MM HIGH, THEN 215MM THICK BLOCKWORK IS TO BE ADOPTED, USING BLOCK LAID FLAT AND COURSED AT 225MM VERTICAL CENTERS. BACKFILLING IS TO BE CARRIED OUT EQUALLY EITHER SIDE OF THE WALLING AND IS TO BE OF AN APPROVED, WELL GRADED, GRANULAR MATERIAL.
- 7. MINIMUM BLOCKWORK STRENGTH TO BE 7.0N/MM<sup>2</sup>. UNLESS STATED OTHERWISE.
- 8. CONTRACTOR TO OBTAIN CONFIRMATION FROM MANUFACTURERS CONCERNING SUITABILITY OF BLOCKS AND BRICKS FOR USE BELOW DPC.
  9. WALL TIES TO BE STAINLESS STEEL STAFIX RT2 AT 450CRS VERTICALLY AND 900CRS HORIZONTALLY (STAGGERED). TIES TO BE POSITIONED AT 225CRS VERTICALLY AROUND ALL OPENINGS.

#### TIMBER NOT

- 1. GALVANISED STEEL STRAPS TO BE PROVIDED AT NOT GREATER THAN 1000MM CENTERS BETWEEN TIMBER AND WALLS AND OR STEELWORK COMPLETE WITH SOLID BLOCKING
- 2. ALL TIMBER TO BE MINIMUM STRENGTH CLASS C16 UNLESS NOTED OTHERWISE
- 3. ALL TIMBERS PROJECTING INTO CAVITY OF CAVITY WALL CONSTRUCTION TO HAVE ENDS LIBERALLY COATED IN 'WOLMANOL' OR SIMILAR APPROVED GRAIN PRESERVATIVE.
- 4. ALL TIMBER TO BE REGULARISED AND SUPPLIED AT A MOISTURE CONTENT AVERAGE NOT EXCEEDING 18%.
- 5. ALL CONNECTORS, BOLTS AND WASHERS TO BE GALVANISED
- 6. ALL DIMENSIONS AND BEARING POINTS OF THE TRUSSES ARE TO BE CHECKED PRIOR TO FABRICATION.
- 7. ALL ROOF BRACING IS TO THE DESIGN OF THE SPECIALIST SUPPLIER. HOWEVER, ALL ROOF BRACING MEMBERS ARE TO BE AT LEAST 97X22, GRADE C16 AND ARE TO BE NAILED TO EVERY TRUSSED RAFTER THEY CROSS WITH 2NO. 3.35MM Ø X 65MM LONG GALVANISED ROUND WIRE NAILS. WHERE BRACING MEMBERS ARE PROVIDED IN TWO PIECES THE ARE TO BE LAP JOINTED OVER AT LEAST TWO TRUSSED RAFTERS AND NAILED AS ABOVE.

## **TIMBER LINTEL SCHEDULE:**

OPENINGS UP TO 1100mm - 150x100mm C16 LINTEL OPENINGS UP TO 1900mm - 200x100mm C16 LINTEL CONSULT WITH STRUCTURAL ENGINEER IF LARGER OPENINGS REQUIRED IN STUD WALL.

### **CONSTRUCTION (DESIGN AND MANAGEMENT REGULATIONS NOTES**

ALL WORKS AND SITE PROCEDURES MUST BE IN KEEPING WITH THE LATEST VERSION OF THE 'CDM REGULATIONS 2015' AND A PRINCIPAL DESIGNER IS TO BE APPOINTED BY THE CLIENT TO MANAGE AND COORDINATE HEALTH AND SAFETY MATTERS ACCORDINGLY

## TEMPORARY WORKS - AS APPLICABLE

THE CONTRACTOR IS ENTIRELY RESPONSIBLE FOR MAINTAINING THE STABILITY OF ALL EXISTING BUILDINGS AND STRUCTURES WITHIN, AND ADJACENT TO, THE WORKS, FROM THE DATE OF POSSESSION OF THE SITE UNTIL PRACTICAL COMPLETION OF THE WORKS. THE DESIGN, INSTALLATION (INCLUDING SEQUENCE), MAINTENANCE AND REMOVAL (INCLUDING SEQUENCE) OF THE TEMPORARY WORKS IS ENTIRELY THE RESPONSIBILITY OF THE CONTRACTOR. IN ADDITION TO THE SUPPORT OF THE VERTICAL LOADS, DUE REGARD SHALL BE GIVEN TO THE OVERALL LATERAL STABILITY OF THE STRUCTURES, AND THE LATERAL STABILITY OF WALLS COLUMNS AND PIERS, ESPECIALLY WHERE ADJACENT EXISTING FLOORS AND ROOFS ARE TO BE DEMOLISHED. THE TEMPORARY SUPPORT SYSTEMS ARE TO BE ERECTED OFF A FOUNDATION/SPREADER SYSTEM ADEQUATE FOR THE VERTICAL AND HORIZONTAL LOADS REQUIRED TO BE SUPPORTED. THE DESIGN OF THE TEMPORARY WORKS IS TO BE UNDERTAKEN BY A COMPETENT PERSON.

THE CONTRACTOR IS TO ENSURE THAT ALL EXISTING CONSTRUCTION IS ADEQUATELY SUPPORTED PRIOR TO COMMENCING DEMOLITION WORKS. IF IN DOUBT ENGINEER TO BE CONSULTED PRIOR TO COMMENCING DEMOLITION.

BEFORE COMMENCING REMOVAL OF TEMPORARY SUPPORTS THE CONTRACTOR IS TO COMPLETE ERECTION AND CONNECTION OF THE NEW PERMANENT SUPPORTING STRUCTURE. THE CONTRACTOR IS TO ENSURE THAT THE TEMPORARILY PROPPED STRUCTURE IS ADEQUATELY SUPPORTED ON THE NEW PERMANENT WORKS PRIOR TO REMOVAL OF ANY TEMPORARY SUPPORTS. THE CONTRACTOR IS TO ENSURE THAT ALL

PARTS OF THE NEW SUPPORTING STRUCTURE HAVE GAINED ADEQUATE STRENGTH PRIOR TO REMOVING TEMPORARY SUPPORTS.

THE LOADINGS FOR THE TEMPORARY WORKS DESIGN ARE GIVEN BELOW, AND ON THE DRAWINGS AS APPROPRIATE. NOTE: ALL LOADS ARE UNFACTORED. THE TEMPORARY WORKS DESIGNER MUST MULTIPLY THESE LOADS BY THE APPROPRIATE ULTIMATE LOAD FACTORS AS GIVEN IN THE RELEVANT DESIGN STANDARD.

STEEL BEAMS DEAD LOAD = 40 kN/m STEEL BEAMS IMPOSED LOAD = 15 kN/m

## **DEMOLITIO**

THE DEMOLITION WORKS ARE TO BE CARRIED OUT WITH GREAT CARE. IF AT ANY TIME THE CONTRACTOR IS UNSURE IF UNPROPPED STRUCTURAL MEMBERS ARE TAKING SUPPORT OFF CONSTRUCTION PROPOSED TO BE DEMOLISHED, DEMOLITION WORK MUST CEASE IMMEDIATELY AND THE CONTRACTOR IS TO OBTAIN FURTHER ADVICE FROM ENGINEER PRIOR TO CONTINUING.

DEMOLITION WORK OTHER THAN THAT INDICATED ON ENGINEERING/THE ARCHITECTS' DRAWINGS IS NOT PERMITTED. IF THE CONTRACTOR BELIEVES THAT ADDITIONAL DEMOLITION TO THAT SHOWN ON ENGINEERING/THE ARCHITECTS' DRAWINGS IS NECESSARY, THEN FURTHER INSTRUCTIONS ARE TO BE SOUGHT FROM ENGINEER AND THE ARCHITECT PRIOR TO COMMENCING THIS ADDITIONAL

## <u>DEMOLITION WORK.</u>

THE CONTRACTOR IS TO PRODUCE A METHOD STATEMENT FOR DEMOLITION WORKS AND THIS METHOD STATEMENT IS TO BE SUBMITTED TO THE PRINCIPAL DESIGNER FOR COMMENT NOT LESS THAN 2 WEEKS PRIOR TO COMMENCING THE DEMOLITION WORKS.

## EXISTING SERVICES

FOR THE INDICATIVE POSITIONS OF EXISTING BURIED SERVICES REFERENCE IS TO BE MADE TO THE ARCHITECTS DRAWINGS. THE ACCURACY OF THIS INFORMATION CANNOT BE GUARANTEED, AND THEREFORE IT IS THE CONTRACTOR'S RESPONSIBILITY TO ESTABLISH THE POSITIONS AND DEPTHS OF ALL UNDERGROUND SERVICES (INCLUDING THOSE NOT SHOWN ON ENGINEERING DRAWINGS) PRIOR TO THE WORKS COMMENCING. THE CONTRACTOR IS TO ALSO NOTE ANY OVERHEAD CABLES ETC. THAT MAY PRESENT A HAZARD DURING THE WORKS.

## SOIL CONDITION

EXCAVATION IS TO PROCEED WITH GREAT CARE. AS EXCAVATION PROCEEDS THE CONTRACTOR IS TO MAINTAIN VIGILANCE FOR GROUND CONDITIONS WHICH MAY AFFECT THE STABILITY OF THE EXCAVATIONS, AND THE SAFETY OF OPERATIVES. (E.G WEAK/SOFT SOILS, WATER TABLE, TOXIC SUBSTANCES/GASES BURIED SERVICES ETC.) ADEQUATE SUPPORT TO BE PROVIDED TO SIDES OF EXCAVATIONS AS NECESSARY.

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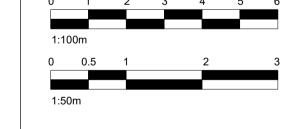
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No.: Revision: Date:



Bischell - Design & Build Suite 114
80 Cumberland House, Scrubs Lane
Hammersmith & Fulham, NW106RF
Client:

27 Welland Gardens Perivale Greenford UB6 8SZ


General Notes

Status: --

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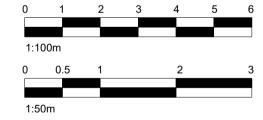
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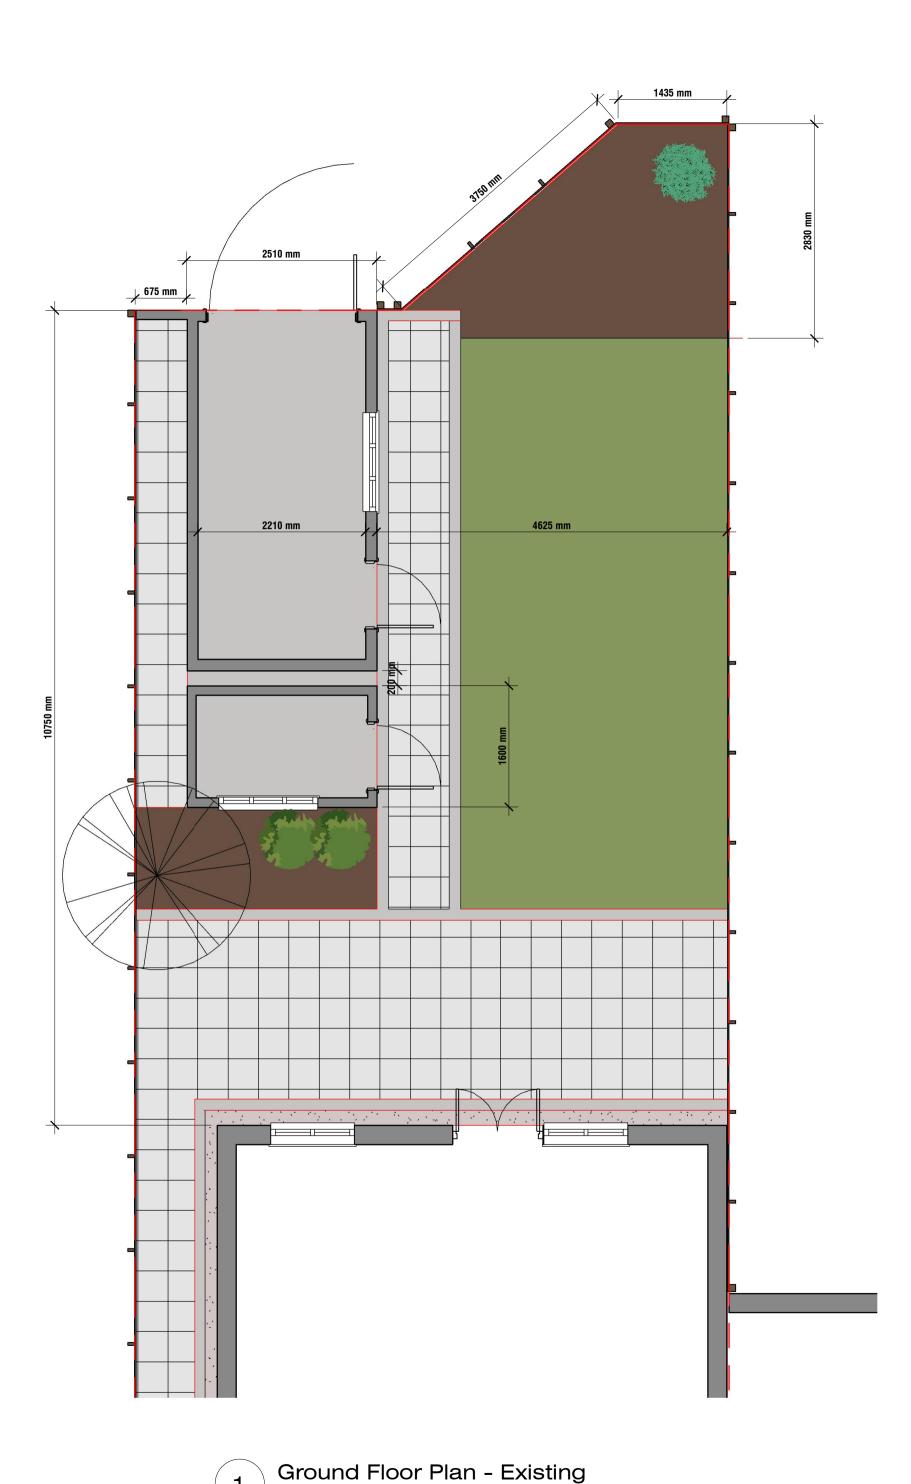
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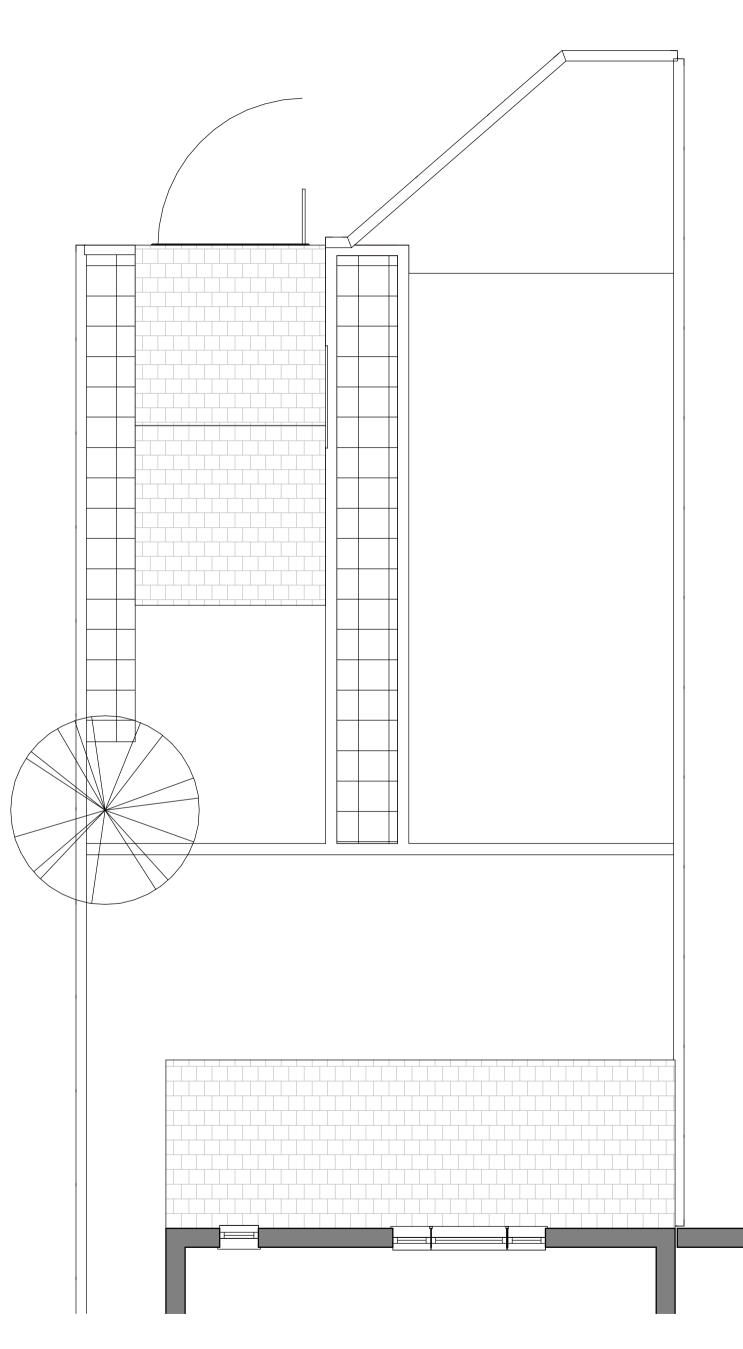
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Block and Location Plan

Scale: As indicated @A2 Date: 28/06/2022

Drawing No.: PN-001

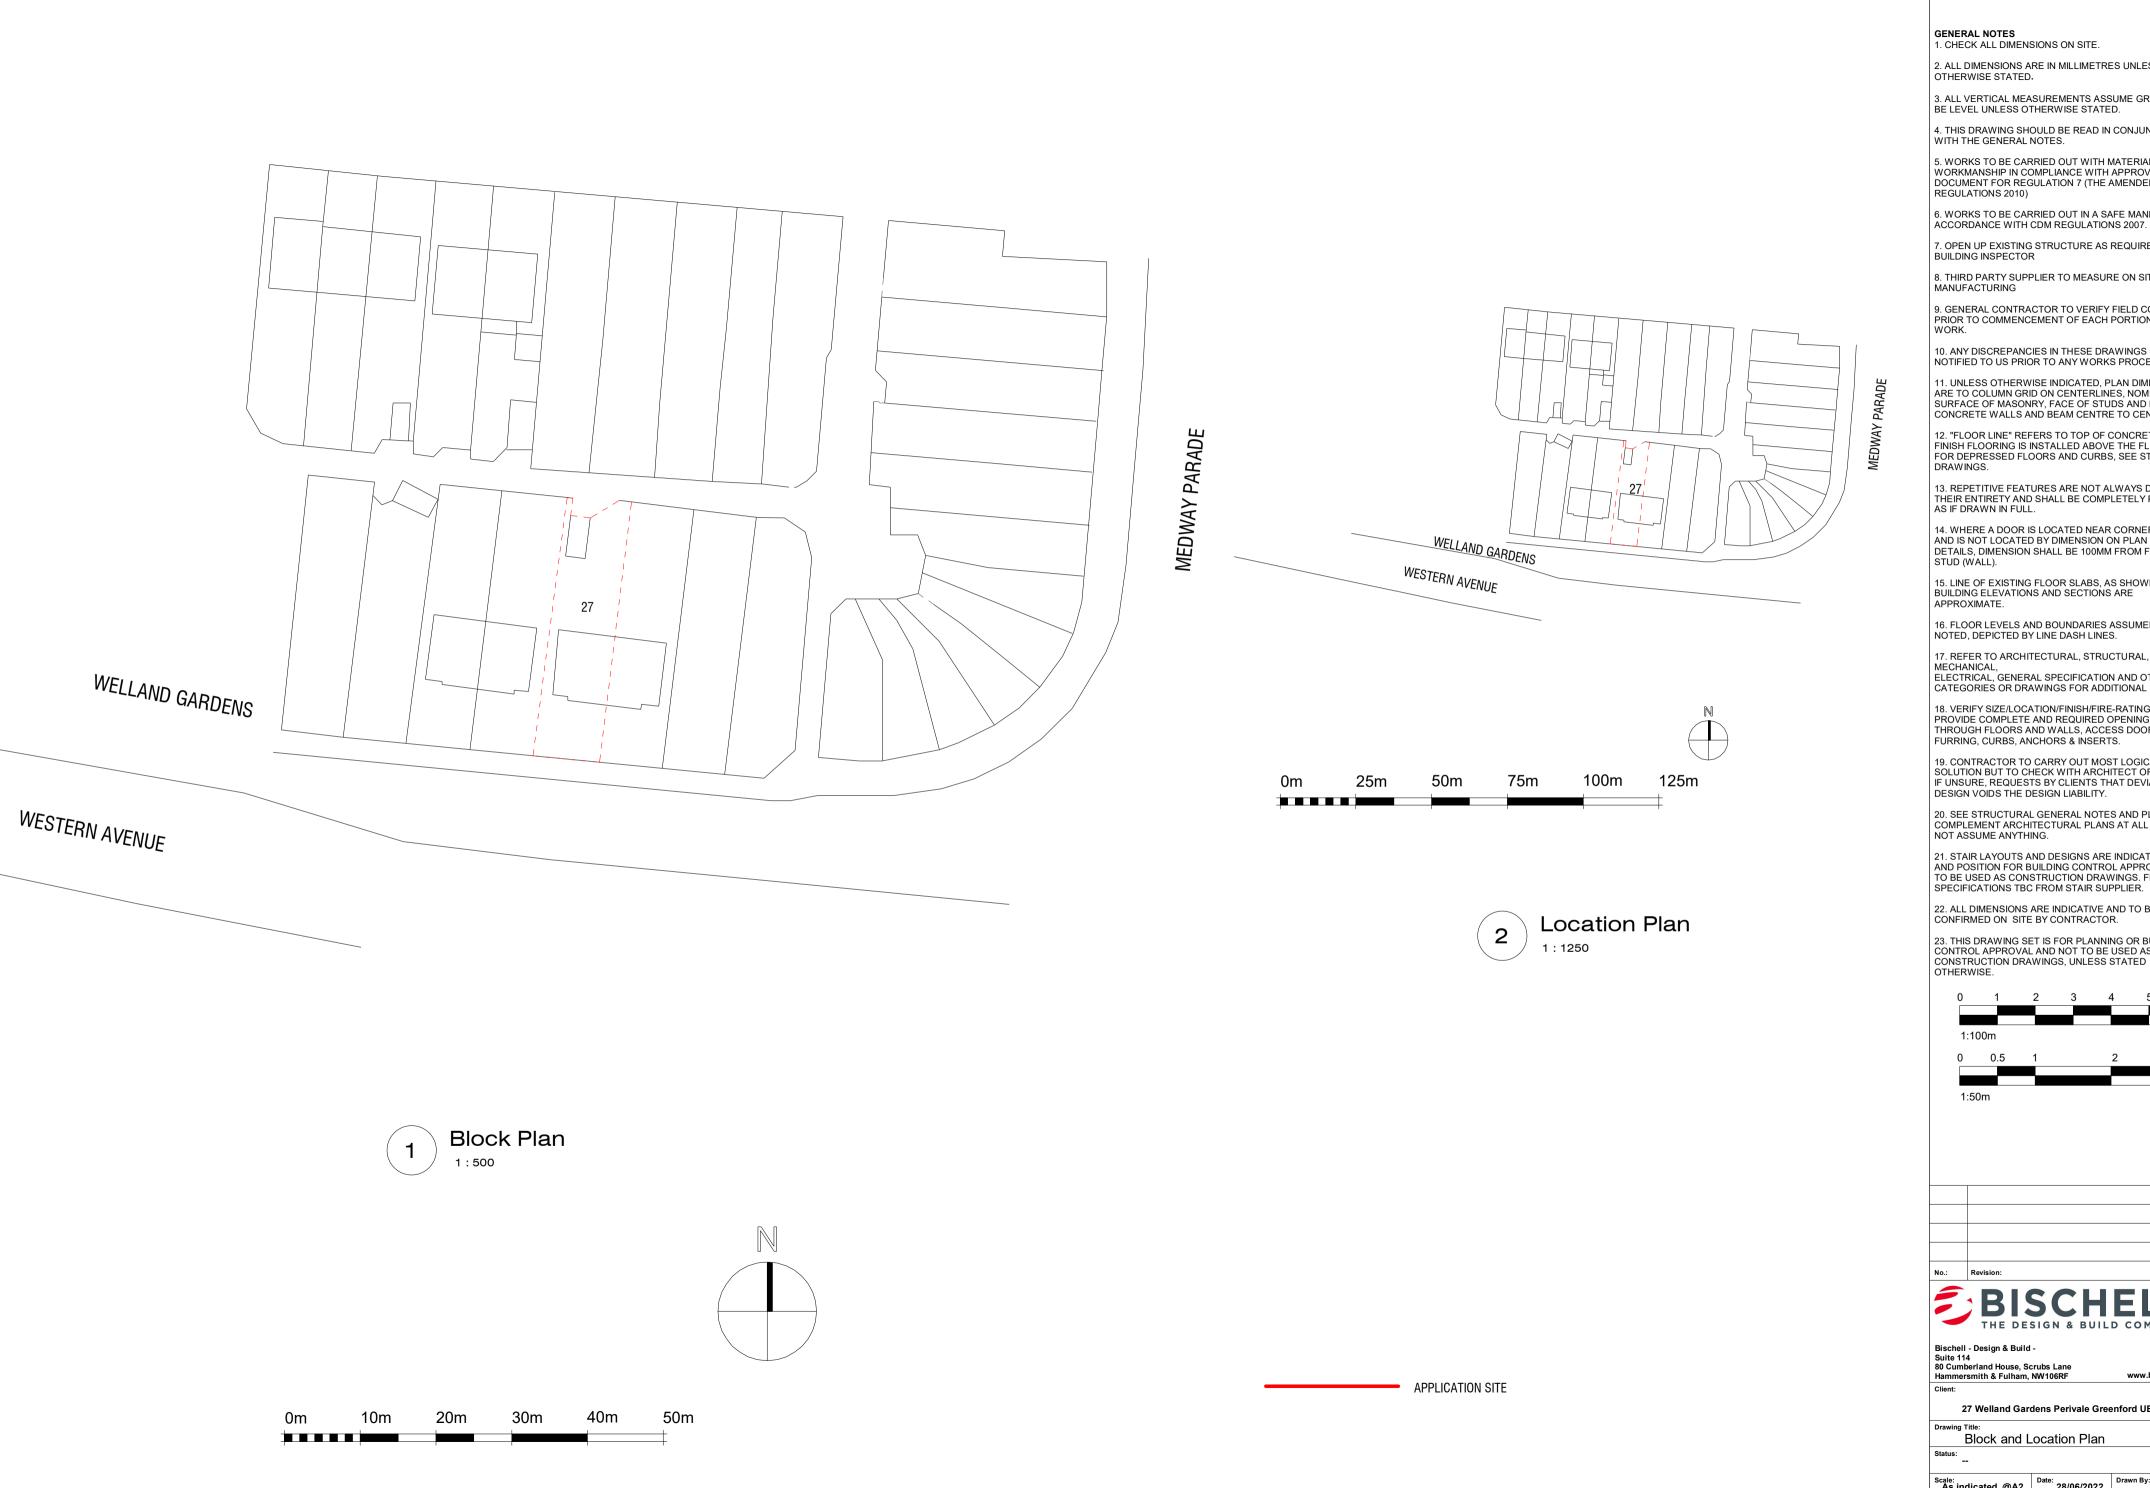



First Floor Plan - Existing

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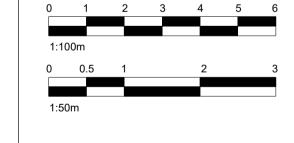
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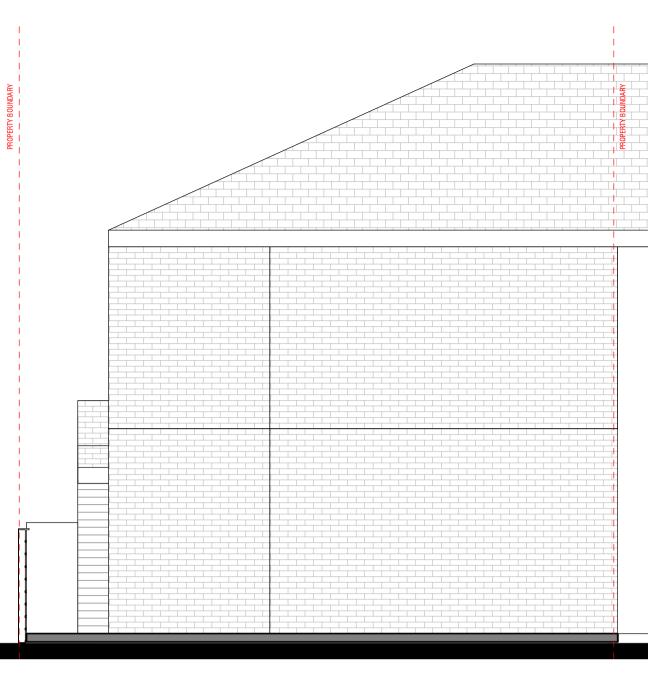


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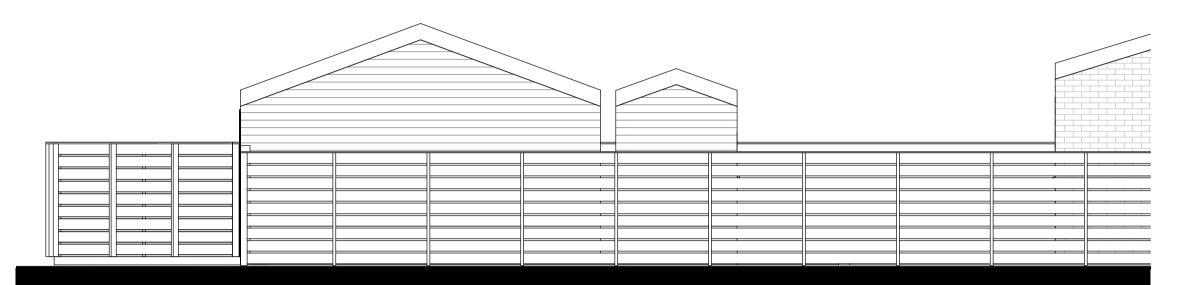
1:50 @A2 Date: 28/06/2022 Drawing No.: PN-004



**Existing Front Elevation** 



**Existing Rear Elevation** 



Existing Left Side Elevation



Existing Right Side Elevation

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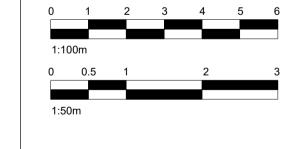
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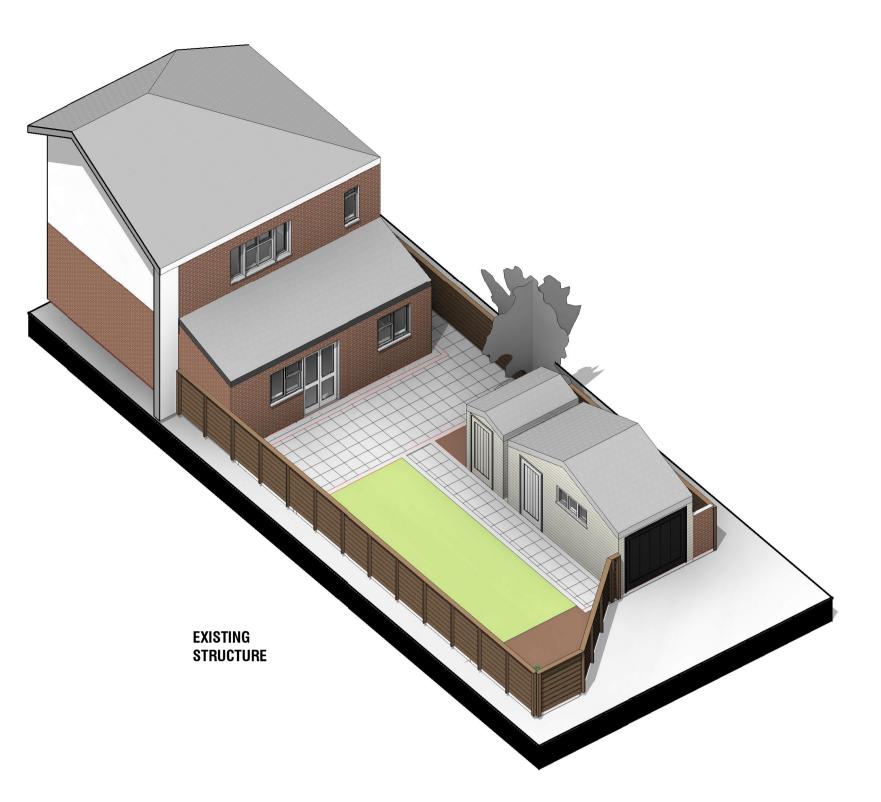
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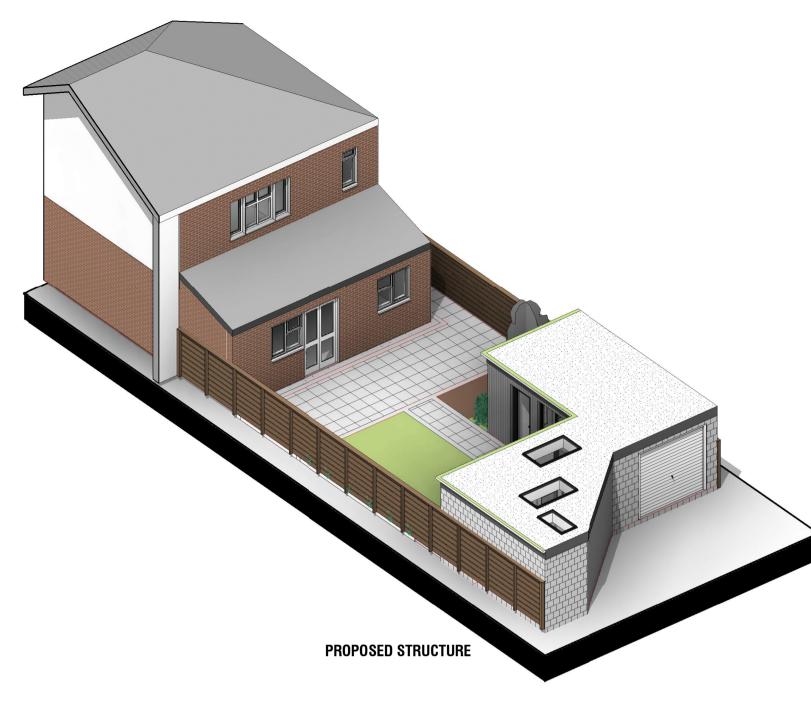
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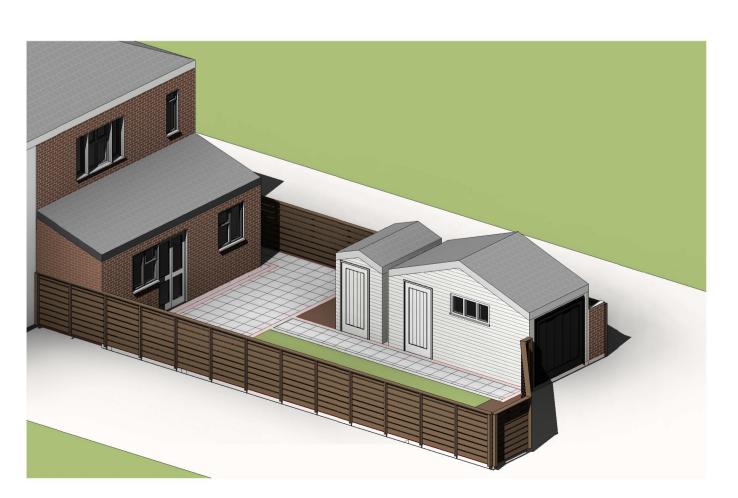
Existing Elevations

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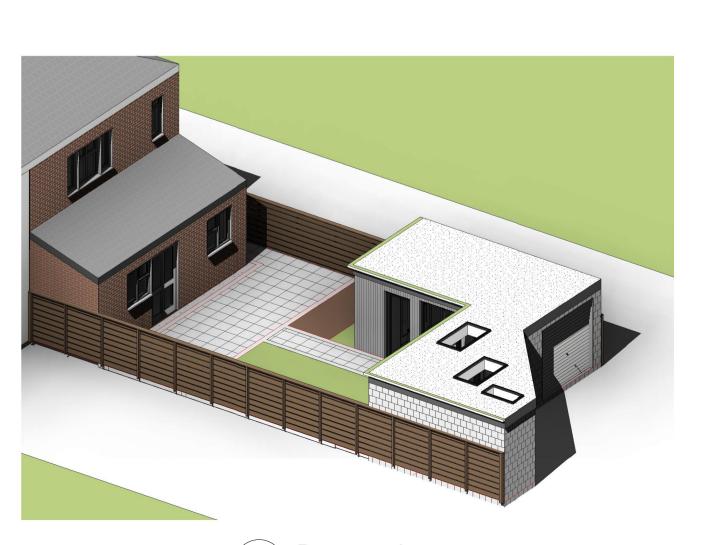
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Existing



Proposed

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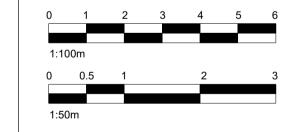
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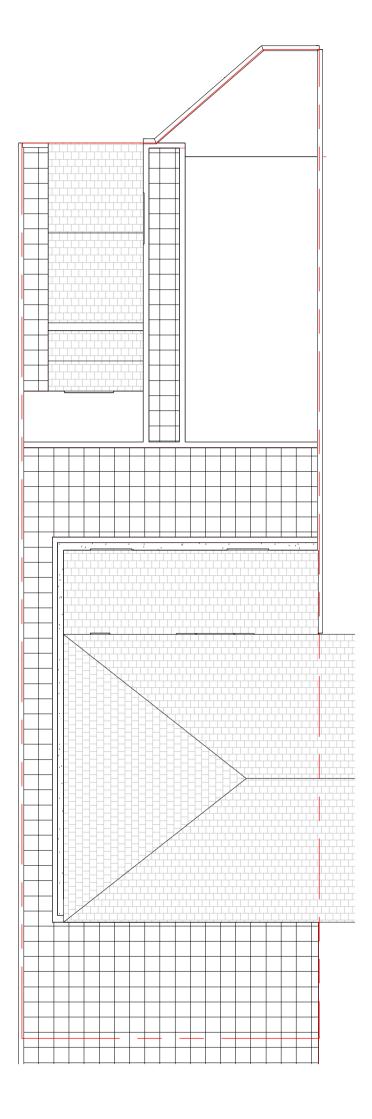
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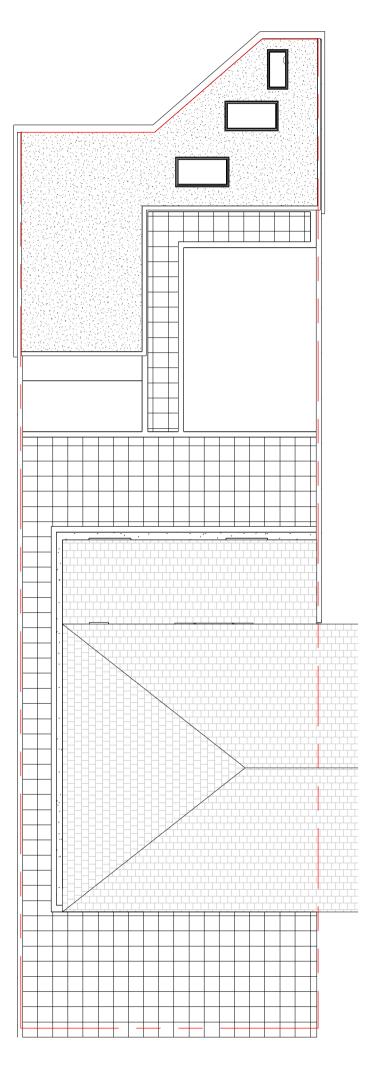
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3D - Exist. & Proposed

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Site Plan - Existing



Site Plan - Proposed

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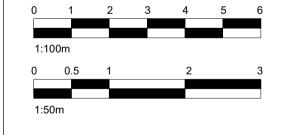
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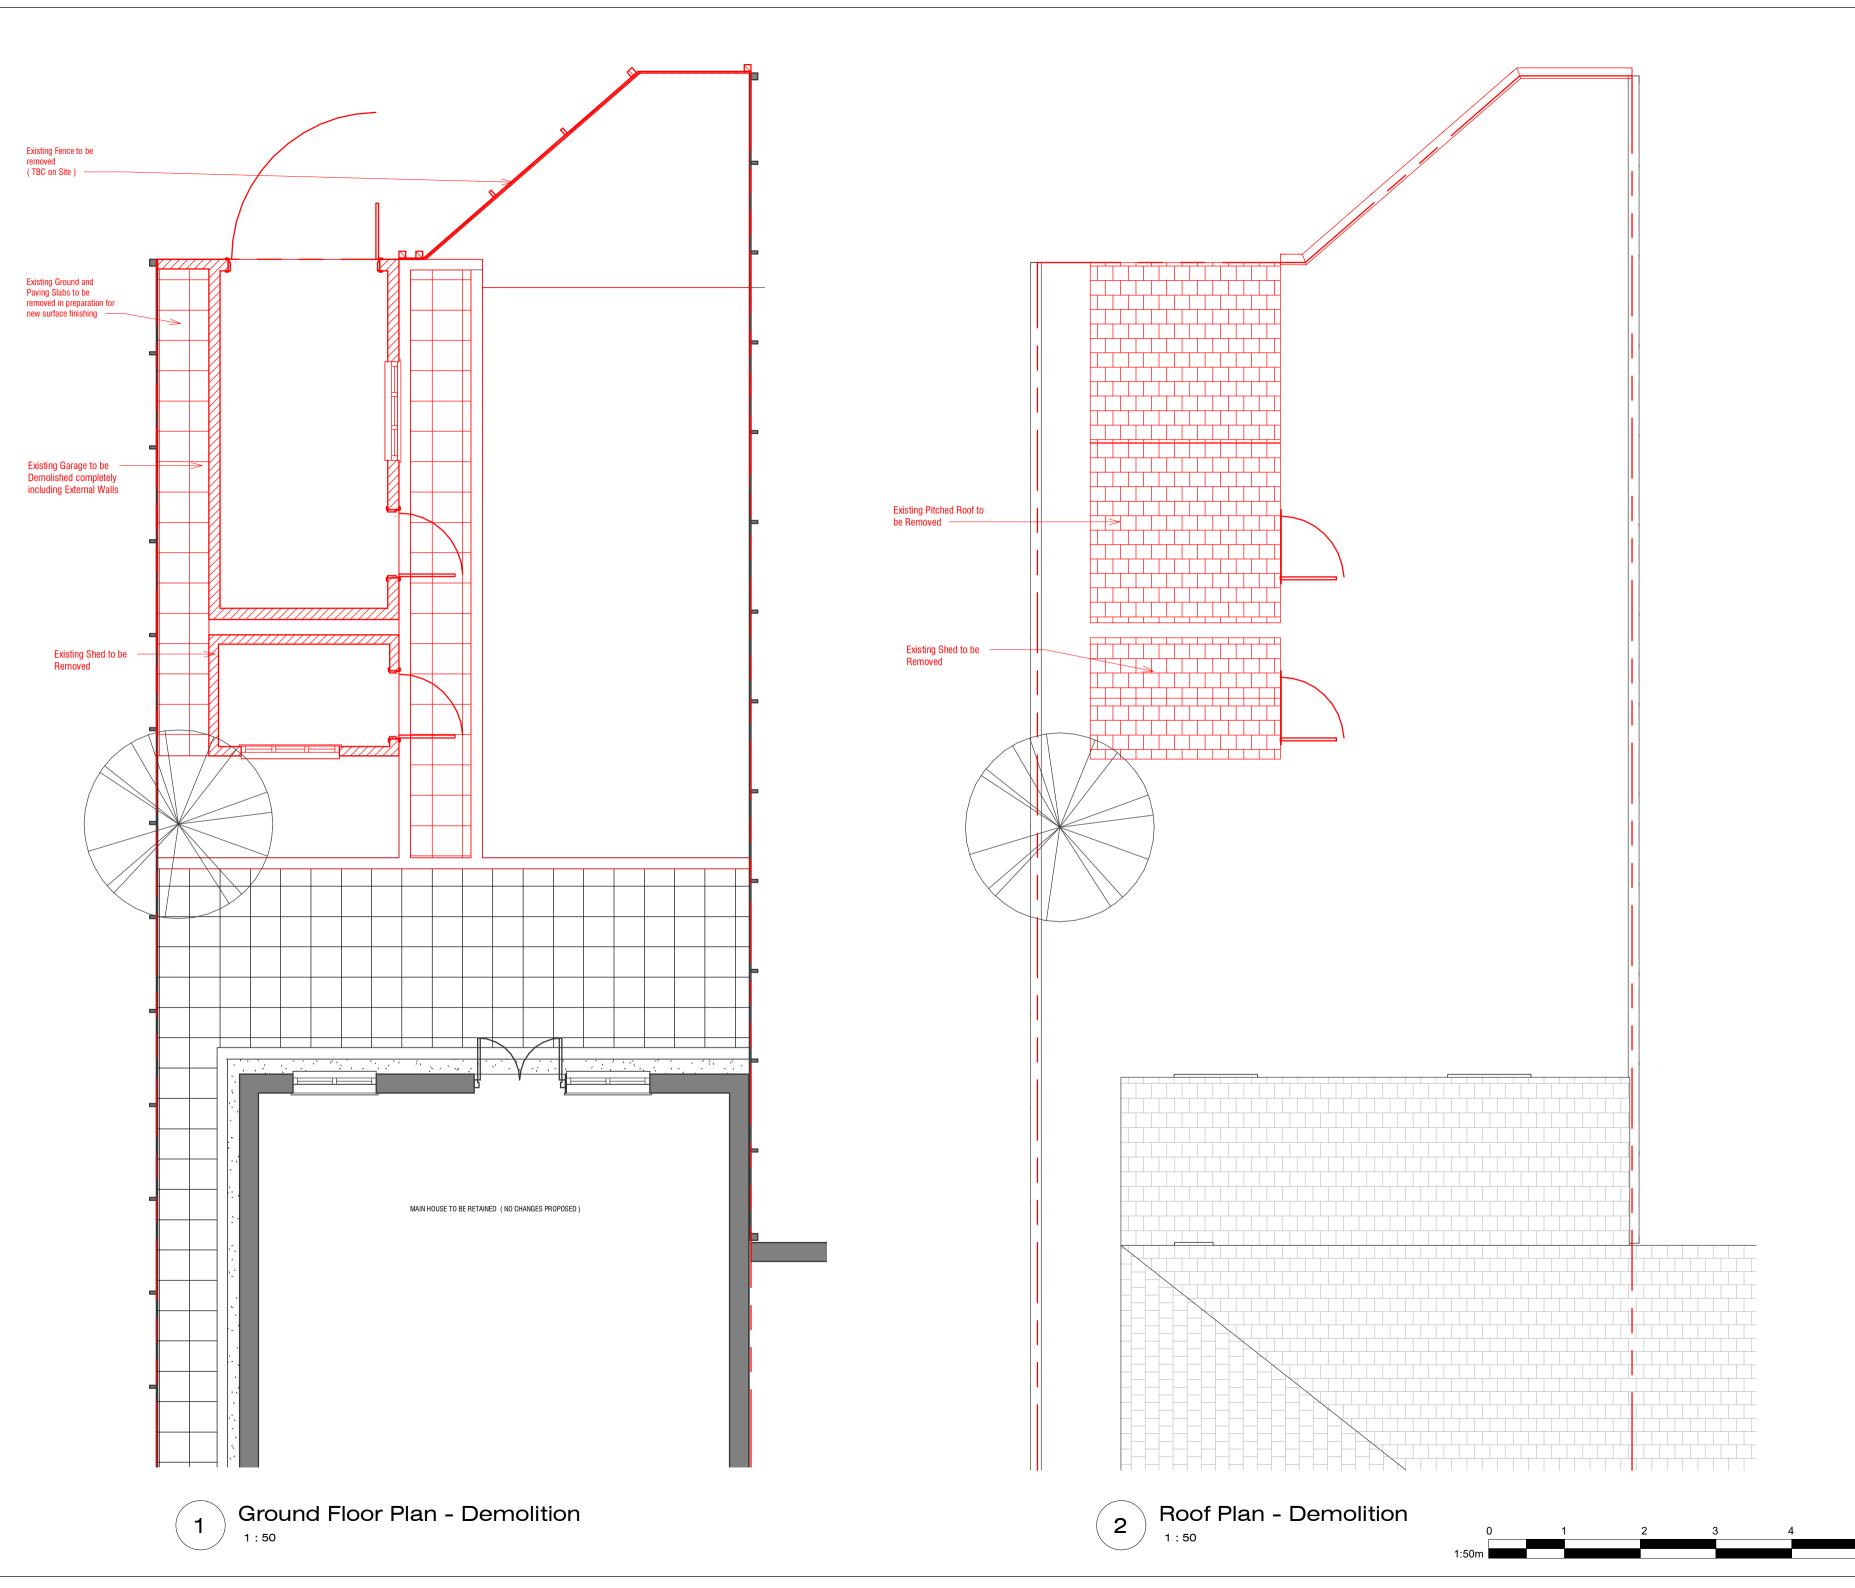
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Drawing Title: Site Plan

Scale: 1:100 @A2 Date: 28/06/2022



### DEMOLITION - GENERAL NOTES

BEFORE STARTING ANY DEMOLITION WORKS, EXAMINE ALL AVAILABLE INFORMATION, CARRY OUT A SURVEY OF THE STRUCTURES, SITE AND SURROUNDING AREA, INSURING SITE SAFTEY AT ALL TIMES.

SUBMIT REPORT AND METHOD STATEMENTS DESCRIBING:

- FORM, CONDITION AND DETAILS OF THE STRUCTURES, SITE AND SURROUNDING AREA.

- FORM, LOCATION AND REMOVAL METHODS OF FLAMMABLE, TOXIC OR HAZARDOUS MATERIALS.

- FORM, LOCATION AND REMOVAL METHODS OF MATERIALS FOR REUSE OR RECYCLING.

- TYPE AND LOCATION OF ADJOINING OR SURROUNDING PREMISES WHICH MAY BE ADVERSELY AFFECTED BY NOISE, VIBRATION, DUST OR REMOVAL OF STRUCTURE.

- IDENTIFICATION AND LOCATION OF SERVICES ABOVE AND BELOW GROUND, INCLUDING THOSE REQUIRED FOR THE CONTRACTOR'S OWN USE. ARRANGEMENTS FOR

DISCONNECTION AND REMOVAL OF SERVICES.

- SEQUENCE AND METHOD OF DEMOLITION INCLUDING DETAILS OF SPECIFIC PRE-WEAKENING.

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ARRANGEMENTS FOR PROTECTION OF PERSONNEL AND THE
PUBLIC INCLUDING EXCLUSION OF UNAUTHORIZED PERSONS.

- PROPOSED PROGRAMME OF WORK

ALLOW FOR ALL TEMPORARY NEEDLING AND PROPPING OF WALLS & FLOORS ABOVE CONSTRUCTION AREA TO PROVIDE TEMPORARY STRUCTURAL STABILITY TO THE EXISTING BUILDING IF REQUIRED.

CREATE 2 TRIAL HOLES AT EACH BOUNDARY TO INSPECT GROUND CONDITIONS.

ENSURE DEMOLITION DOES NOT START UNTIL ALL SERVICES ARE DISCONNECTED. LOCATE, DISCONNECT AND SEAL DISUSED DRAIN CONNECTIONS.
PROTECT DRAINS, MANHOLES, INSPECTION CHAMBERS, GULLIES, VENT PIPES AND FITTINGS STILL IN USE AND ENSURE THAT THEY ARE KEPT FREE OF DEBRIS.
MAKE GOOD ANY DAMAGE ARISING FROM DEMOLITION WORK, LEAVE CLEAN AND IN WORKING ORDER AT COMPLETION.

PROVIDE BYPASS CONNECTIONS AS NECESSARY TO

MAINTAIN CONTINUITY OF SERVICES TO OCCUPIED AREAS OF THE SAME AND ADJOINING PROPERTIES. MINIMUM 72 HOURS NOTICE TO OCCUPIERS IF SHUTDOWN IS NECESSARY DURING CHANGEOVER.

GIVE NOTICE AND NOTIFY SERVICE AUTHORITY OR OWNER

OF DAMAGE ARISING FROM THE EXECUTION OF THE WORKS TO REMAINING SERVICES. COMPLETE REPAIRS AS DIRECTED AND TO THE SATISFACTION OF THE SERVICES AUTHORITY OR OWNER.

ENSURE THAT THE PUBLIC IS PROTECTED FROM RISKS

ENSURE THAT THE PUBLIC IS PROTECTED FROM RISKS ASSOCIATED WITH THE DEMOLITION WORK. SECURELY FENCE OFF THE SITE TO RESTRICT ACCESS AND PROVIDE APPROPRIATE WARNING SIGNAGE.


BUILDINGS OR STRUCTURES ADJACENT TO PUBLIC SPACES TO HAVE A FULL HEIGHT HEAVY DUTY PERIMETER SCAFFOLD TO CONTAIN DEBRIS. SCAFFOLD FACADE TO BE SHEETED IN CHAIN MESH OR SHADE CLOTH, DO NOT USE HESSIAN. WHERE DEMOLITION WORK IS BEING CARRIED OUT FROM THE SCAFFOLD, FIX PLY SHEETS FROM THE WORKING PLATFORM TO THE GUARDRAIL.

DEMOLISH STRUCTURES IN ACCORDANCE WITH BS 6187 BY

OPERATIVES APPROPRIATELY SKILLED AND EXPERIENCED FOR THE TYPE OF WORK, HOLDING OR IN TRAINING TO OBTAIN RELEVANT CITB CERTIFICATES OF COMPLIANCE. SITE STAFF RESPONSIBLE FOR SUPERVISION AND CONTROL OF WORK SHOULD BE EXPERIENCED IN THE ASSESSMENT OF RISKS INVOLVED AND METHODS OF DEMOLITION USED. WHERE POSSIBLE REDUCE AIRBORNE DUST BY PERIODICALLY SPRAYING DEMOLITION WORKS WITH AN

APPROPRIATE WETTING AGENT SUBMIT METHOD STATEMENT FOR CONTROL, CONTAINMENT AND CLEAN UP OF LEAD DUST.

ON COMPLETION CLEAR AWAY AND LEAVE THE SITE IN A TIDY CONDITION.

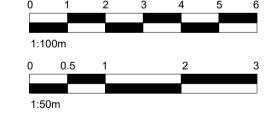

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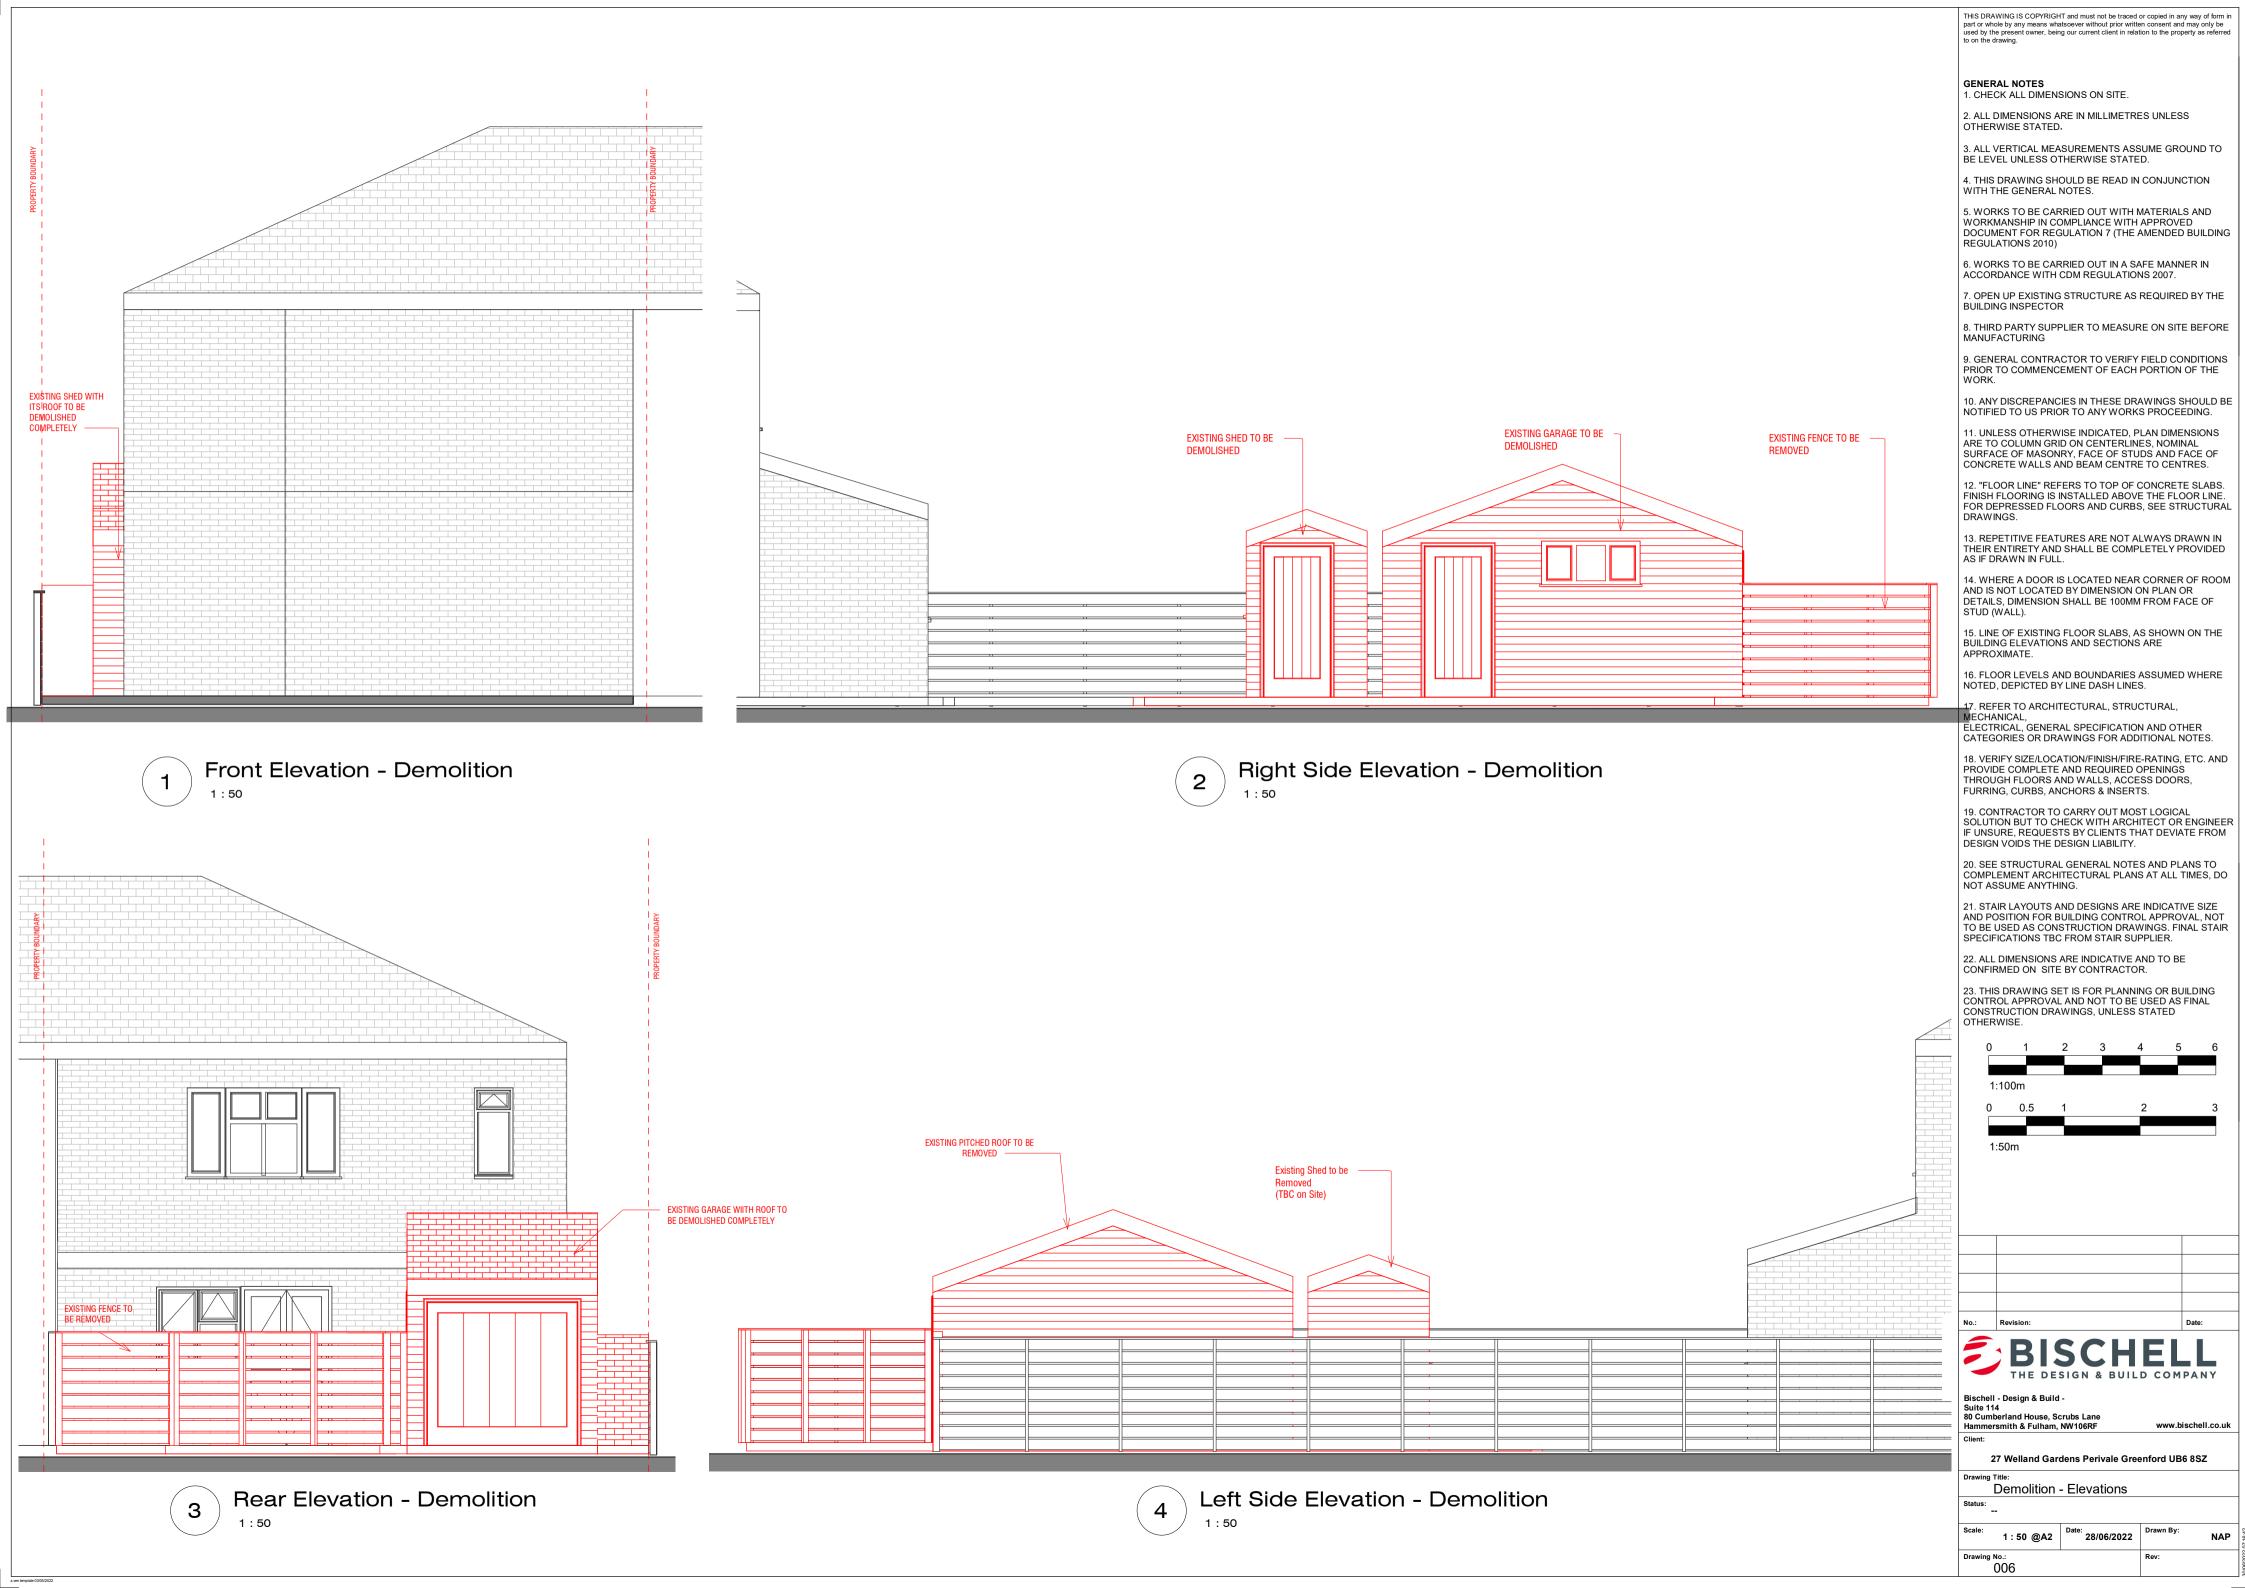
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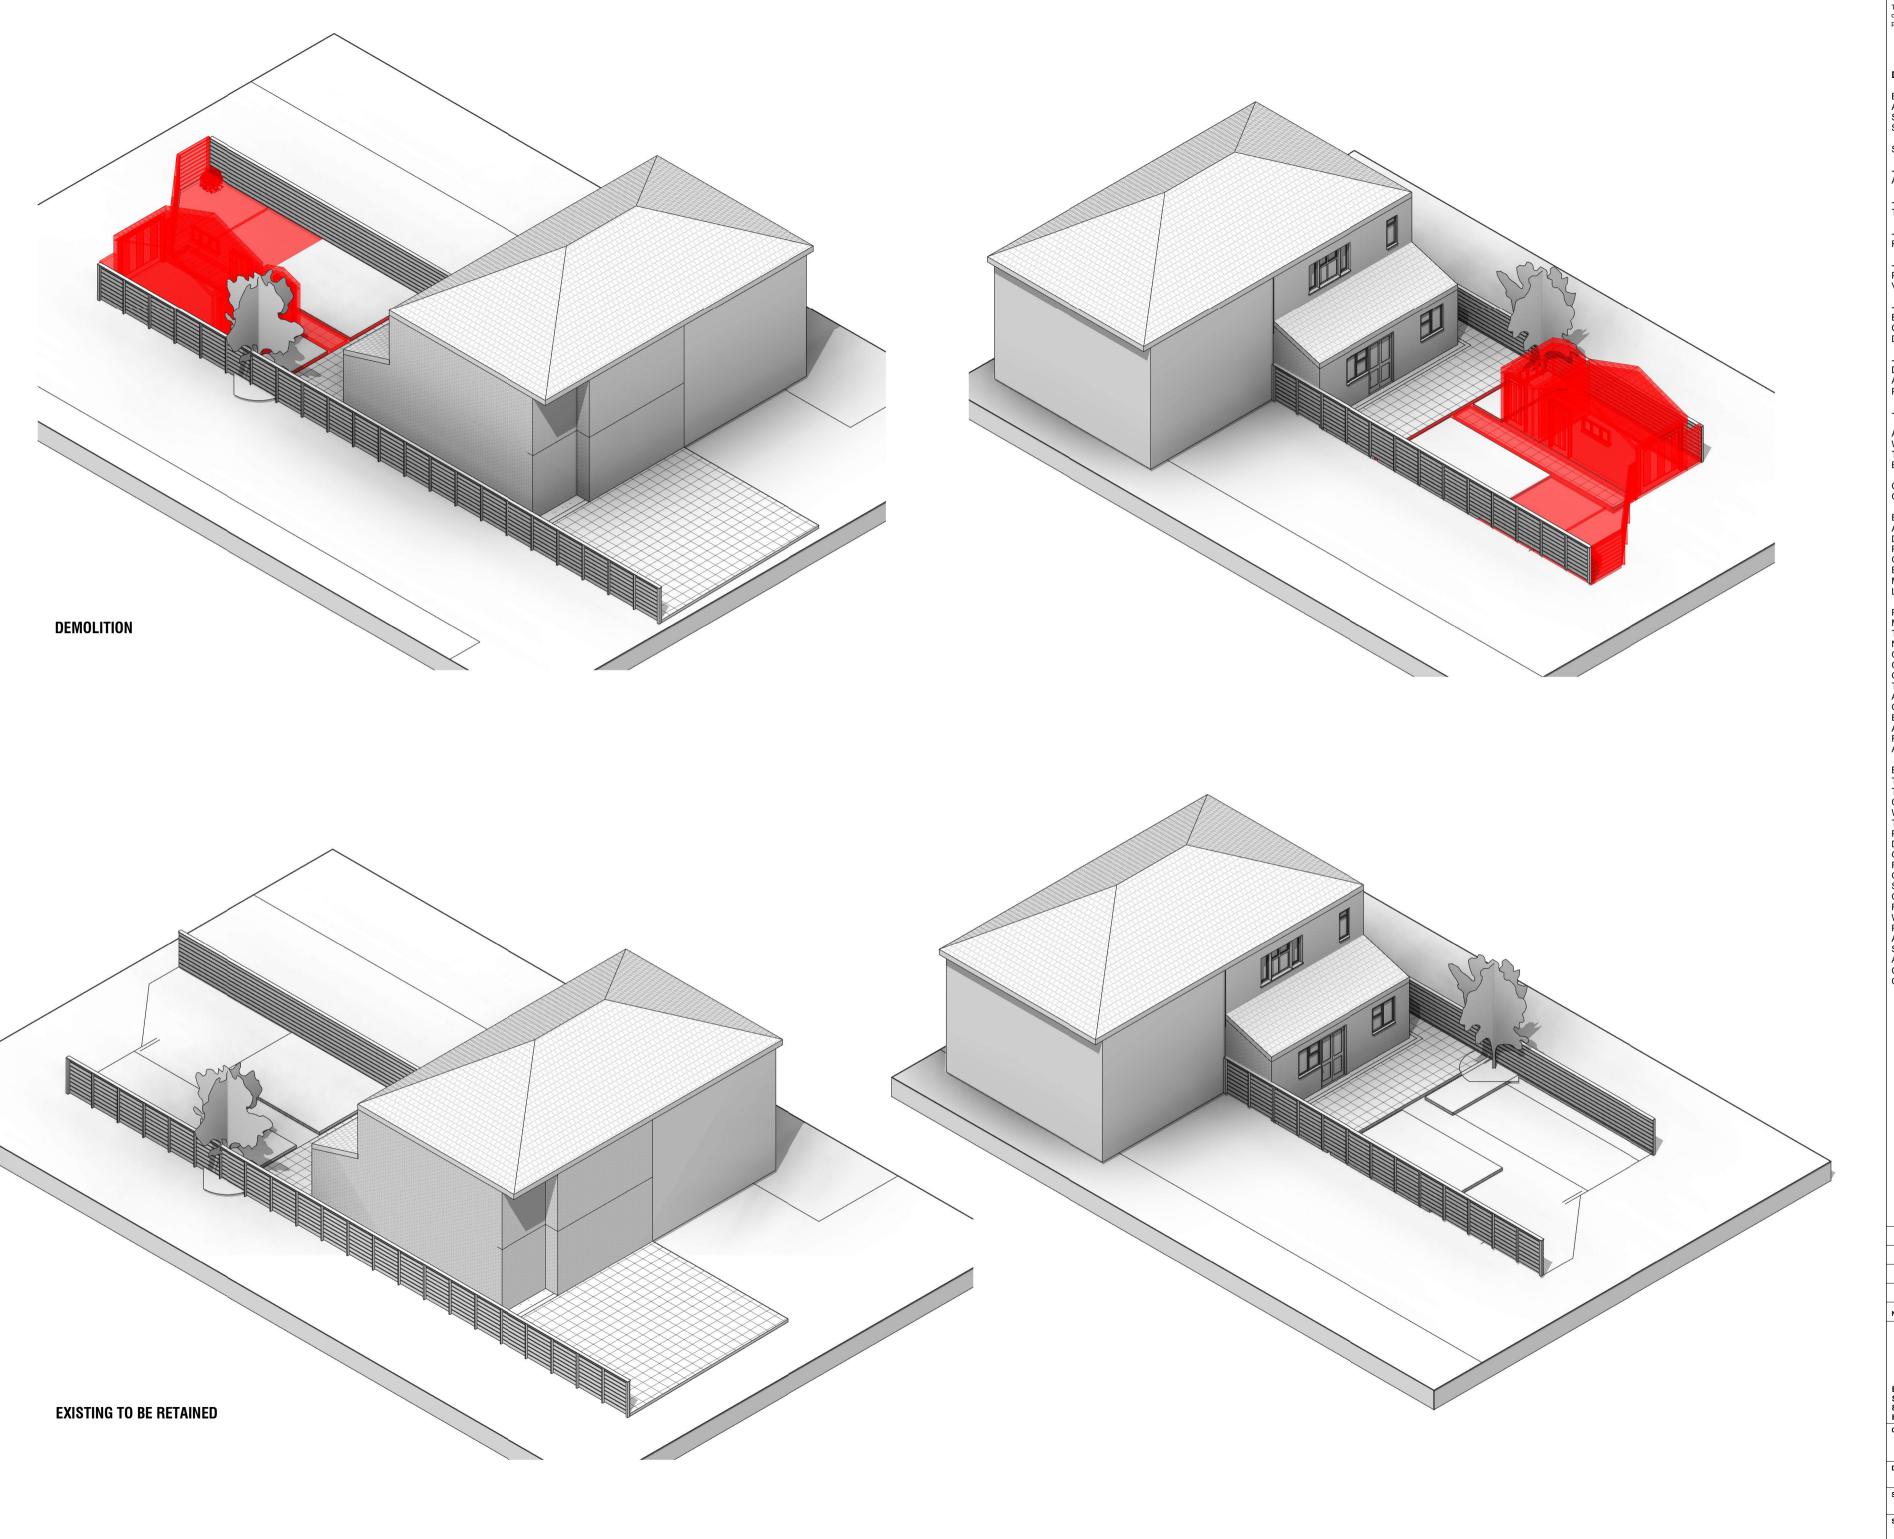
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Drawing Title: Demolition Plans
Status:

e: 1:50 @A2 Date: 28/06/2022 Drawn By: N





### **DEMOLITION - GENERAL NOTES**

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CREATE 2 TRIAL HOLES AT EACH BOUNDARY TO INSPECT GROUND CONDITIONS.

ENSURE DEMOLITION DOES NOT START UNTIL ALL SERVICES ARE DISCONNECTED. LOCATE, DISCONNECT AND SEAL DISUSED DRAIN CONNECTIONS.
PROTECT DRAINS, MANHOLES, INSPECTION CHAMBERS, GULLIES, VENT PIPES AND FITTINGS STILL IN USE AND ENSURE THAT THEY ARE KEPT FREE OF DEBRIS.
MAKE GOOD ANY DAMAGE ARISING FROM DEMOLITION WORK, LEAVE CLEAN AND IN WORKING ORDER AT COMPLETION.

PROVIDE BYPASS CONNECTIONS AS NECESSARY TO MAINTAIN CONTINUITY OF SERVICES TO OCCUPIED AREAS OF THE SAME AND ADJOINING PROPERTIES. MINIMUM 72 HOURS NOTICE TO OCCUPIERS IF SHUTDOWN IS NECESSARY DURING

GIVE NOTICE AND NOTIFY SERVICE AUTHORITY OR OWNER OF DAMAGE ARISING FROM THE EXECUTION OF THE WORKS TO REMAINING SERVICES. COMPLETE REPAIRS AS DIRECTED AND TO THE SATISFACTION OF THE SERVICES AUTHORITY OR


ENSURE THAT THE PUBLIC IS PROTECTED FROM RISKS ASSOCIATED WITH THE DEMOLITION WORK. SECURELY FENCE OFF THE SITE TO RESTRICT ACCESS AND PROVIDE APPROPRIATE WARNING SIGNAGE

BUILDINGS OR STRUCTURES ADJACENT TO PUBLIC SPACES TO HAVE A FULL HEIGHT HEAVY DUTY PERIMETER SCAFFOLD TO CONTAIN DEBRIS. SCAFFOLD FACADE TO BE SHEETED IN CHAIN MESH OR SHADE CLOTH, DO NOT USE HESSIAN. WHERE DEMOLITION WORK IS BEING CARRIED OUT FROM THE SCAFFOLD, FIX PLY SHEETS FROM THE WORKING PLATFORM TO THE GUARDRAIL.

DEMOLISH STRUCTURES IN ACCORDANCE WITH BS 6187 BY
OPERATIVES APPROPRIATELY SKILLED AND EXPERIENCED
FOR THE TYPE OF WORK, HOLDING OR IN TRAINING TO

OBTAIN RELEVANT CITB CERTIFICATES OF COMPLIANCE. SITE STAFF RESPONSIBLE FOR SUPERVISION AND CONTROL OF WORK SHOULD BE EXPERIENCED IN THE ASSESSMENT OF RISKS INVOLVED AND METHODS OF DEMOLITION USED. WHERE POSSIBLE REDUCE AIRBORNE DUST BY PERIODICALLY SPRAYING DEMOLITION WORKS WITH AN

APPROPRIATE WETTING AGENT SUBMIT METHOD STATEMENT FOR CONTROL, CONTAINMENT AND CLEAN UP OF LEAD DUST. ON COMPLETION CLEAR AWAY AND LEAVE THE SITE IN A TIDY

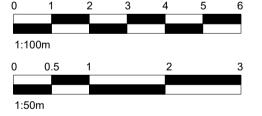

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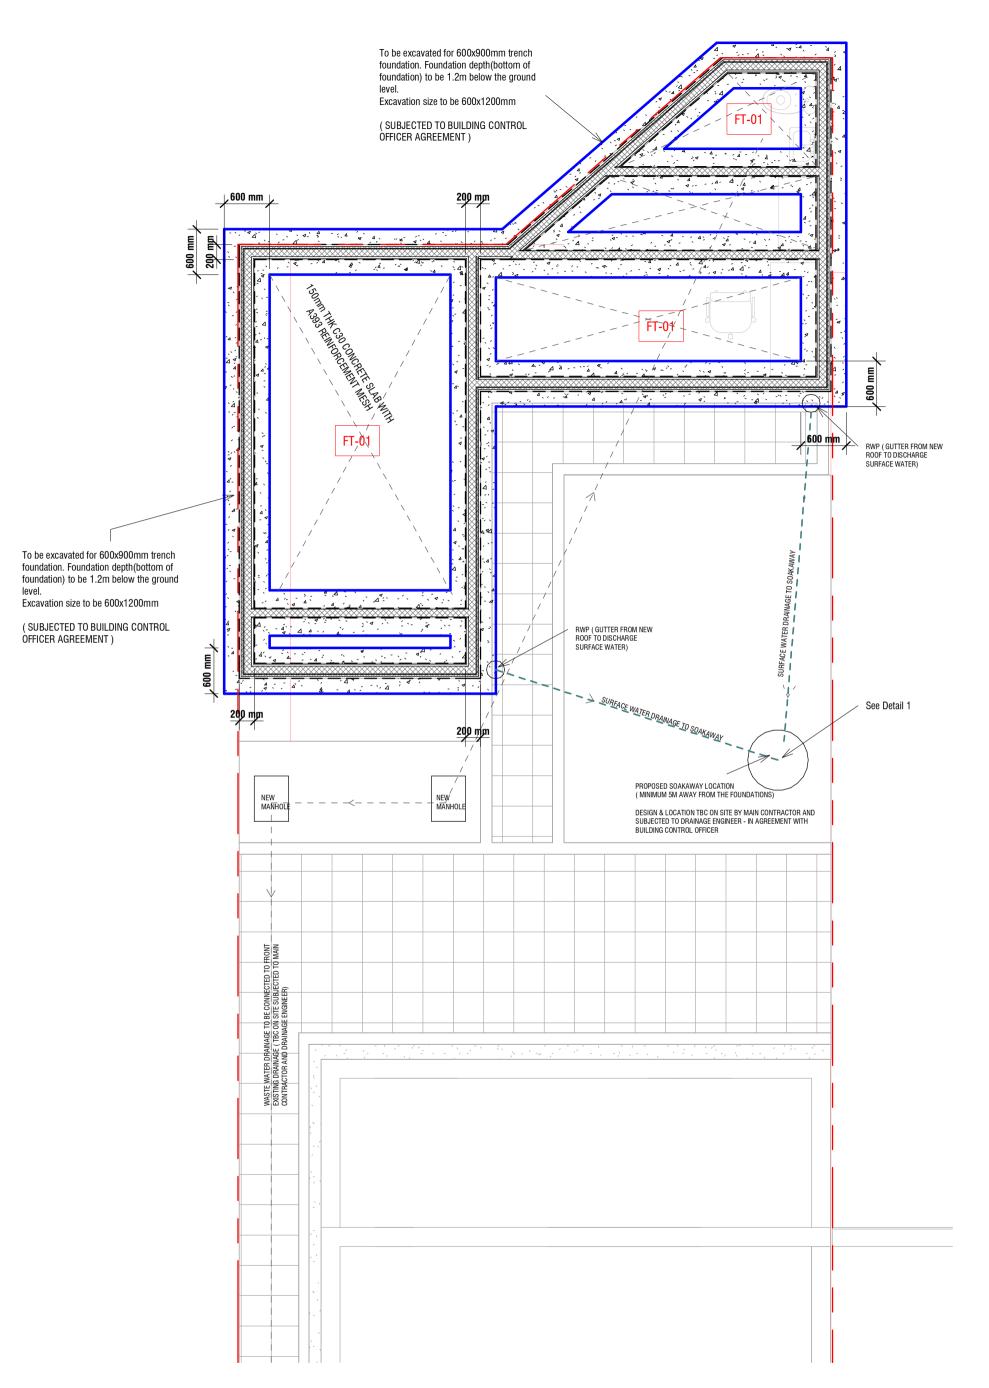



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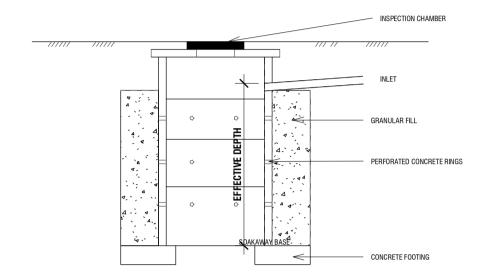
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Demolition Isometric

28/06/2022





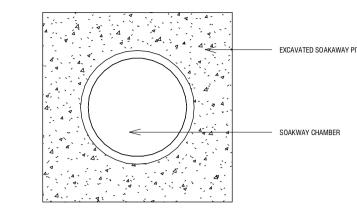

TYPICAL SOAKAWAY DETAIL

**Drainage layout assumed TBC** according to CCTV survey report prior to commencement to build.

Services from Buiding to run into new drainage run at relevant manholes -**Manhole Depth 400mm PVC - TBC** 

**Drainage layout is indicative only. Check CCTV survey report and drainage** plan prior to commencement to build.

All drainage to be in conjuction with drainage engineer Existing recommendations and TBC on Site by **Contractor** 

Proposed Foundation Plan

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#### FOUNDATION PLANS - GENERAL NOTES:

ALL DEPTHS OF FOUNDATIONS TO BE AGREED WITH BUILDING

ALL REINFORCED CONCRETE TO BE MIN. C35.
MASS CONCRETE FOOTING TO BE MIN. C15.
FOUNDATION CONCRETE TO BE 35N/MM2 AT 28 DAYS, FOUNDATIONS TO BE LOCATED ON FIRM BEARING TO THE SATISFACTION OF BUILDING INSPECTOR.
MINIMUM COVER TO REINFORCEMENT TO BE 40MM.
CONCRETE MUD MAT OF MINIMUM DEPTH 50MM TO BE PLACED

UNDER ALL REINFORCED FOUNDATIONS.
FOUNDATIONS TO BE MINIMUM 600 X 1000 MM STRIPS, THE
DEPTH TO BE APPROVED BY BUILDING INSPECTOR BEFORE THE

BEGINNING OF WORKS PROVIDE CROSS VENTILATION UNDER FLOOR TO OUTSIDE AIR BY VENTILATORS IN AT LEAST 2 OPPOSITE EXTERNAL WALLS OF THE BUILDING. VENTILATION OPENINGS HAVING AN OPENING AREA OF 1500MM2/M RUN OF PERIMETER WALL OR 500MM2/M OF

### DRAINAGE PLANS - GENERAL NOTES:

THIS INFORMATION IS FOR GUIDANCE ONLY; THE RELEVANT AUTHORITIES NEED TO BE CONTACTED WHERE PUBLIC SEWERS ARE AFFECTED.

FLOOR AREA WHICHEVER GIVES THE GREATER OPENING AREA

WHERE A DRAIN OR SEWER RUNS UNDER A BUILDING AT LEAST 100MM OF GRANULAR MATERIAL SHOULD BE PROVIDED AROUND PIPE, NO FINE CONCRETE OR OTHER UNSUITABLE FLEXIBLE FILLING SHOULD BE USED AROUND THE PIPE. 300MM WIDE (SPANNING OVER PIPE) OR 2X 100MM WIDE PRECAST CONCRETE LINTELS TO BE USED. FOR SEWERS OVER 160MM IN DIAMETER A PRE-CONSTRUCTION SURVEY MUST BE CARRIED OUT TO IDENTIFY THE CONDITION OF

THE SEWERS.

IF BUILDING WITHIN 1.5 METRES OF THE SEWER, A CROSS SECTION DRAWING SHOWING FOUNDATION DESIGN IN RELATION

ENGINEER SHOULD BE CONTACTED IF ANY THING CHANGES ON THE SITE. ALL WORKS SHALL COMPLY WITH THE REQUIREMENTS OF 'SEWERS FOR ADOPTION', 7TH EDITION IN CONJUNCTION WITH

'PROTOCOL ON DESIGN AND CONSTRUCTION OF ADOPTION OF SEWERS IN ENGLAND AND WALES', UNLESS OTHERWISE

NO ADDITIONAL LOADS ARE TO BE TRANSMITTED TO THE SEWER BY THE PROPOSED WORKS.
THIS CONSENT IS SUBJECT TO ANY CONDITIONS THAT MAY BE IMPOSED THROUGH THE BUILDING REGULATION PROCESS. IT IS YOUR RESPONSIBILITY TO CHECK AND VERIFY THE INVERT

LEVELS AND POSITION OF THE PUBLIC SEWER PRIOR TO WORKS ANY SEWERS THAT ARE EQUAL OR SHALLOWER THAN 1.1

METRES TO INVERT FROM FINISHED GROUND LEVEL CAN HAVE NEW FOUNDATIONS MINIMUM OF 100MM FROM THE SIDE OF THE PUBLIC SEWER.
PUBLIC SEWERS THAT ARE DEEPER THAN 1.1 METRES BUT NO DEEPER THAN 2.0 METRES SHALL HAVE NEW FOUNDATIONS NO CLOSER THAN 600MM, FOR PUBLIC SEWERS DEEPER THAN 2.0 METRES, NEW FOUNDATIONS SHALL BE NO CLOSER THAN 1.0

METRE.
WHEN USING PILED FOUNDATIONS, THE PROPOSED
FOUNDATIONS ARE TO BE A MINUMUM OF 1.5 METRES FROM THE
PUBLIC SEWER. ONLY CONTINUOUS FLIGHT AUGERED PILES ARE
ACCEPTABLE. THE USE OF DRIVEN PILES WILL NOT BE
PERMITTED WITHIN 15 METRES.
PROPOSED FOUNDATIONS TO BE CONSTRUCTED WITHIN 1.5
METRES OF THE PUBLIC SEWER SHALL BE TAKEN TO A DEPTH FOLIAL OR GREATER THAN THE SEWER INVERT

MANHOLES ON THE PUBLIC SEWER SHALL NOT BE BUILT OVER OR LOCATED INSIDE PROPOSED STRUCTURES EVEN WITH NEW DOUBLE SEALED BOLT DOWN COVERS. WHERE PUBLIC SEWER IS LESS THAN OR EQUAL TO 1.1M DEEP.

WHERE PUBLIC SEWER IS LESS I HAN OR EQUAL TO 1.1M DEEP, NO STRUCTURE SHALL BE BUILT IN CONTACT WITH THE PUBLIC SEWER MANHOLE, AND MUST BE A MINIMUM OF 100MM FROM THE OUTSIDE OF THE CHAMBER WALL.
WHERE THE DEPTH OF THE PUBLIC SEWER IS GREATER THAN 1.1 METRES, NO STRUCTURE SHALL BE BUILT WITHIN 600MM OF THE PUBLIC MANHOLE STRUCTURE.
ALL CONNECTIONS TO THE PUBLIC SEWER TO BE AT A MANHOLE

ALL CONNECTIONS TO THE PUBLIC SEWER TO BE AT A MANHOLE OR VIA A PRE-FORMED JUNCTION.
SADDLE CONNECTIONS ARE NOT PERMITTED ON TO SEWERS
LESS THAN 375MM IN DIAMETER.
CONNECTIONS INTO MANHOLES MUST BE MADE WITH SOFFITS

LEVEL AND MUST ENTER 'WITH THE FLOW'.
MORE THAN FOUR BUILDING OVER AGREEMENTS IN A ROW WILL
NOT BE PERMITTED ON A LENGTH OF PUBLIC SEWER WITHOUT

AN EXTERNAL MANHOLE BEING AVAILABLE FOR SUITABLE OPERATION ACCESS.
NEW MANHOLES TO BE IN ACCORDANCE WITH SEWERS FOR ADOPTION 6TH EDITION, IN CERTAIN CIRCUMSTANCES

INSPECTION CHAMBERS CAN BE BUILT IN ACCORDANCE WITH SEWERS FOR ADOPTION 7 WITH STRICT APPROVAL IF THE HOUSEHOLDER OR BUILDING CONTROL REQUESTS THAT A SURVEY BE CARRIED OUT, ALL SUCH SURVEYS SHALL BE CARRIED OUT AT THE HOUSEHOLDER'S EXPENSE. PLASTIC PIPES AND FITTINGS ARE GENERALLY NOT ACCEPTED

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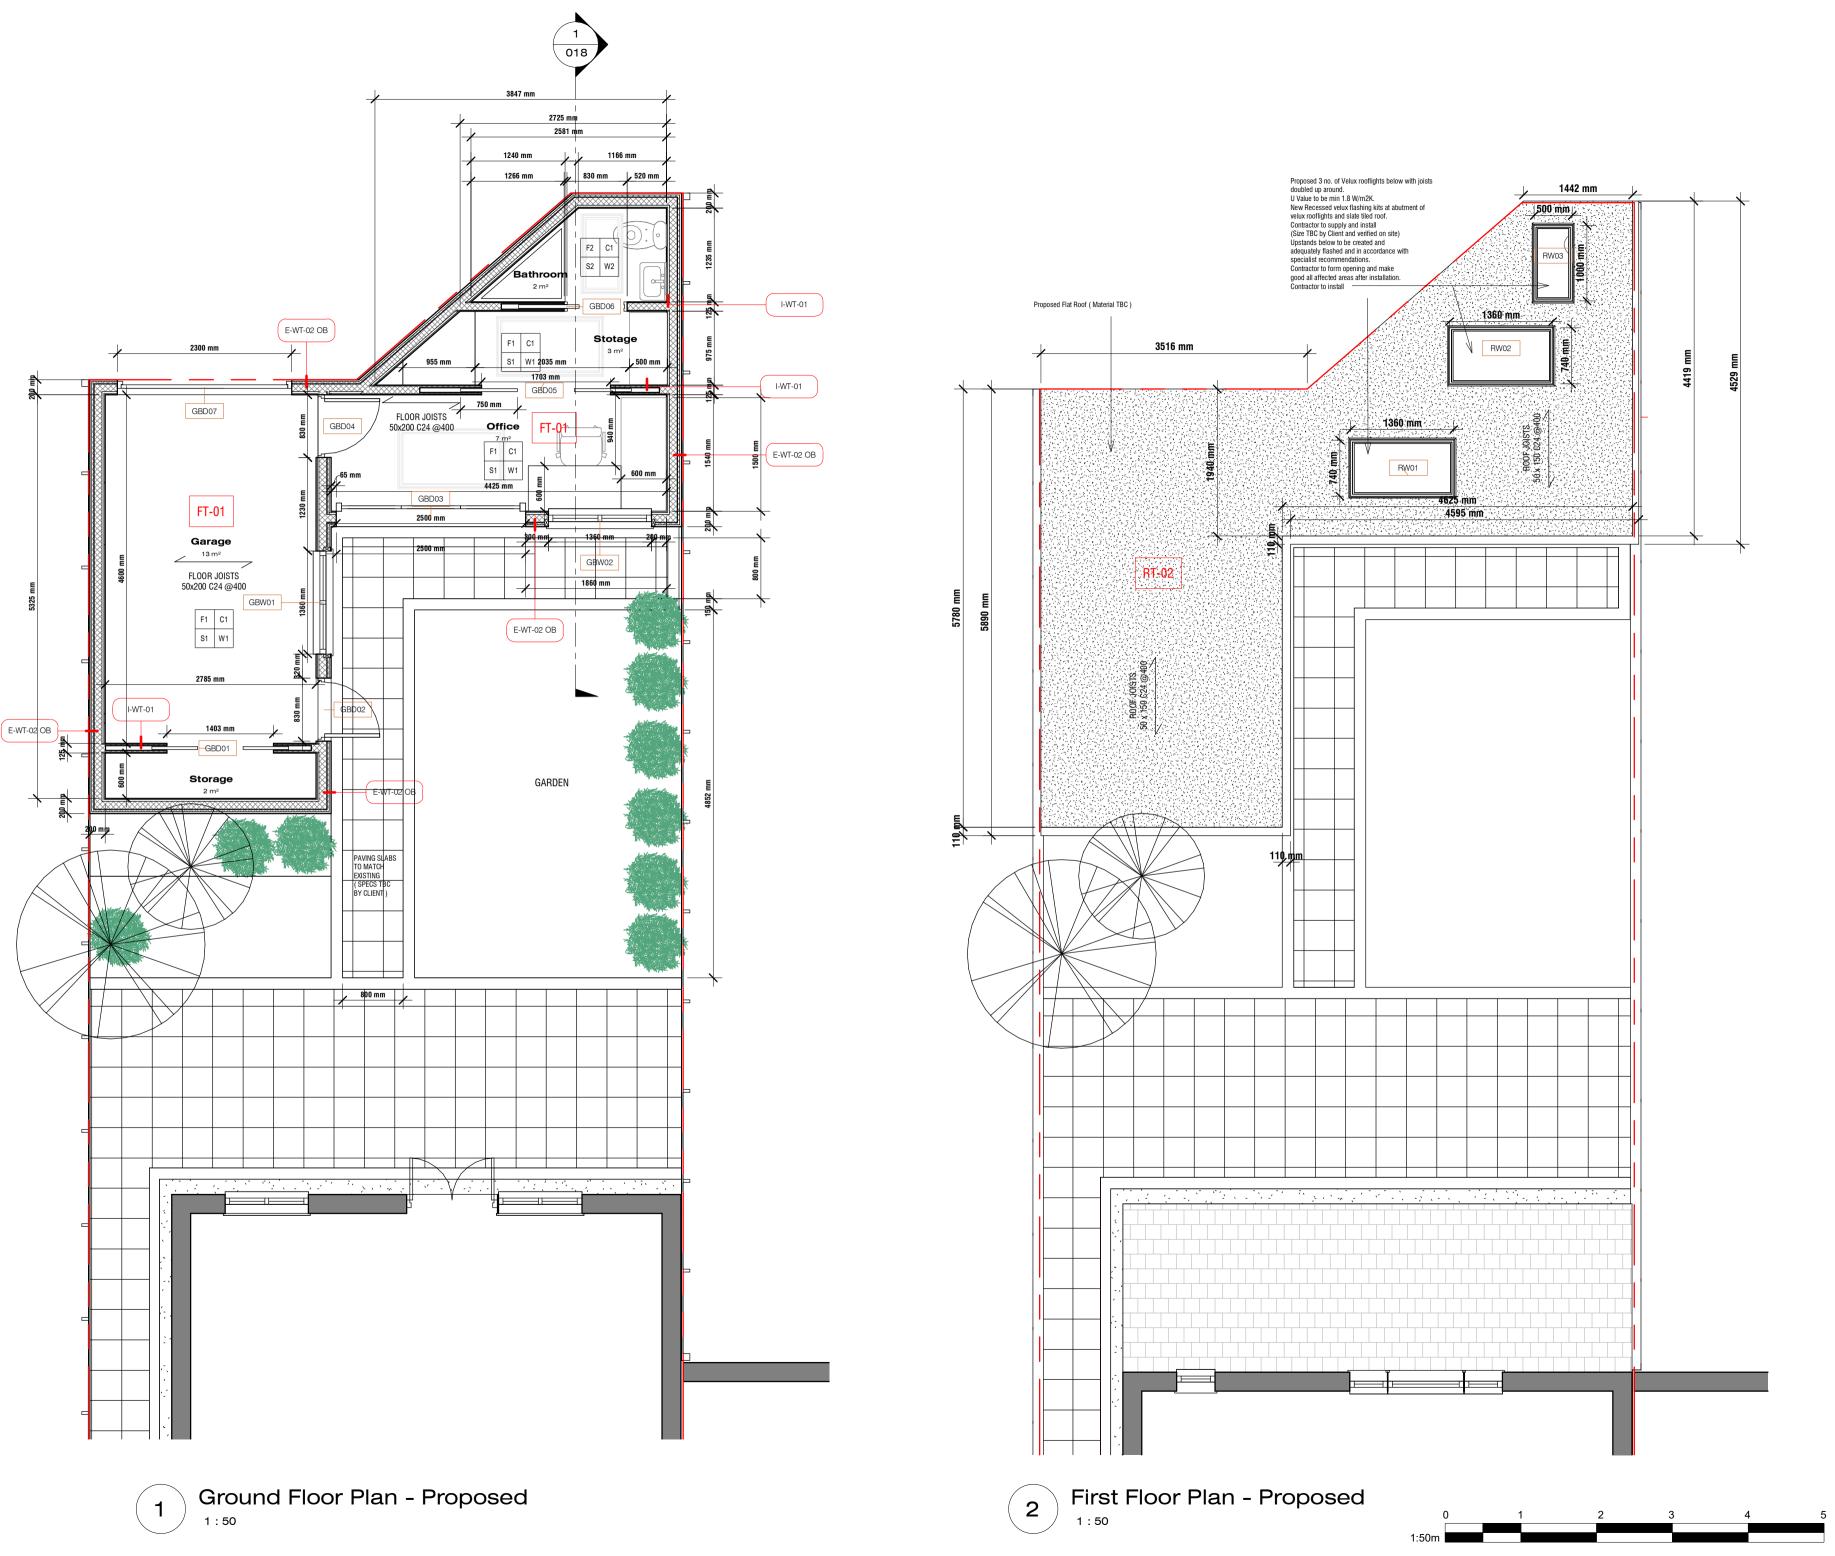
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Prawing Title: Foundation Plan - Proposed

Scale: As indicated @A2

28/06/2022



GENERAL NOTES

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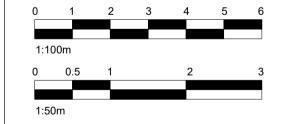
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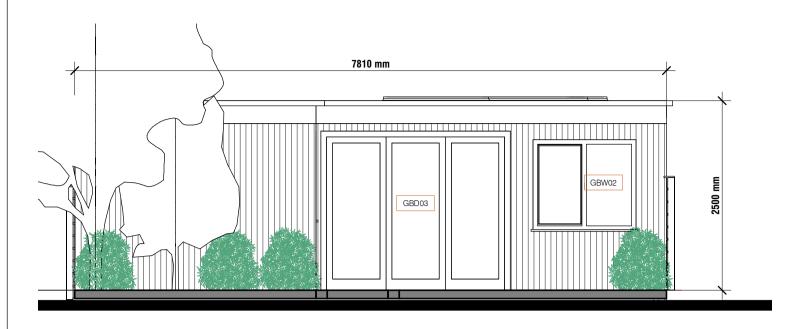


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Ground&First Plan - Proposed

1 : 50 @A2 Date: 28/06/2022




Elevation 1 - a

Proposed Right Side Elevation

WALL TYPE TBC 

**Proposed Rear Elevation** 

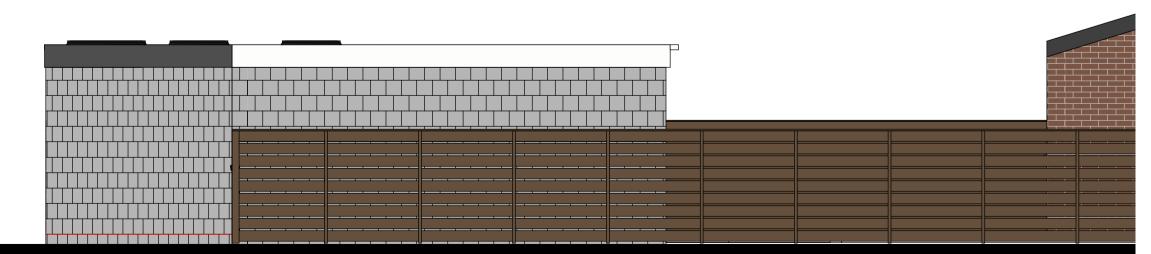

Proposed Left Side Elevation

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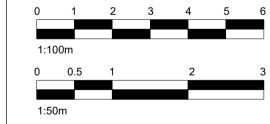
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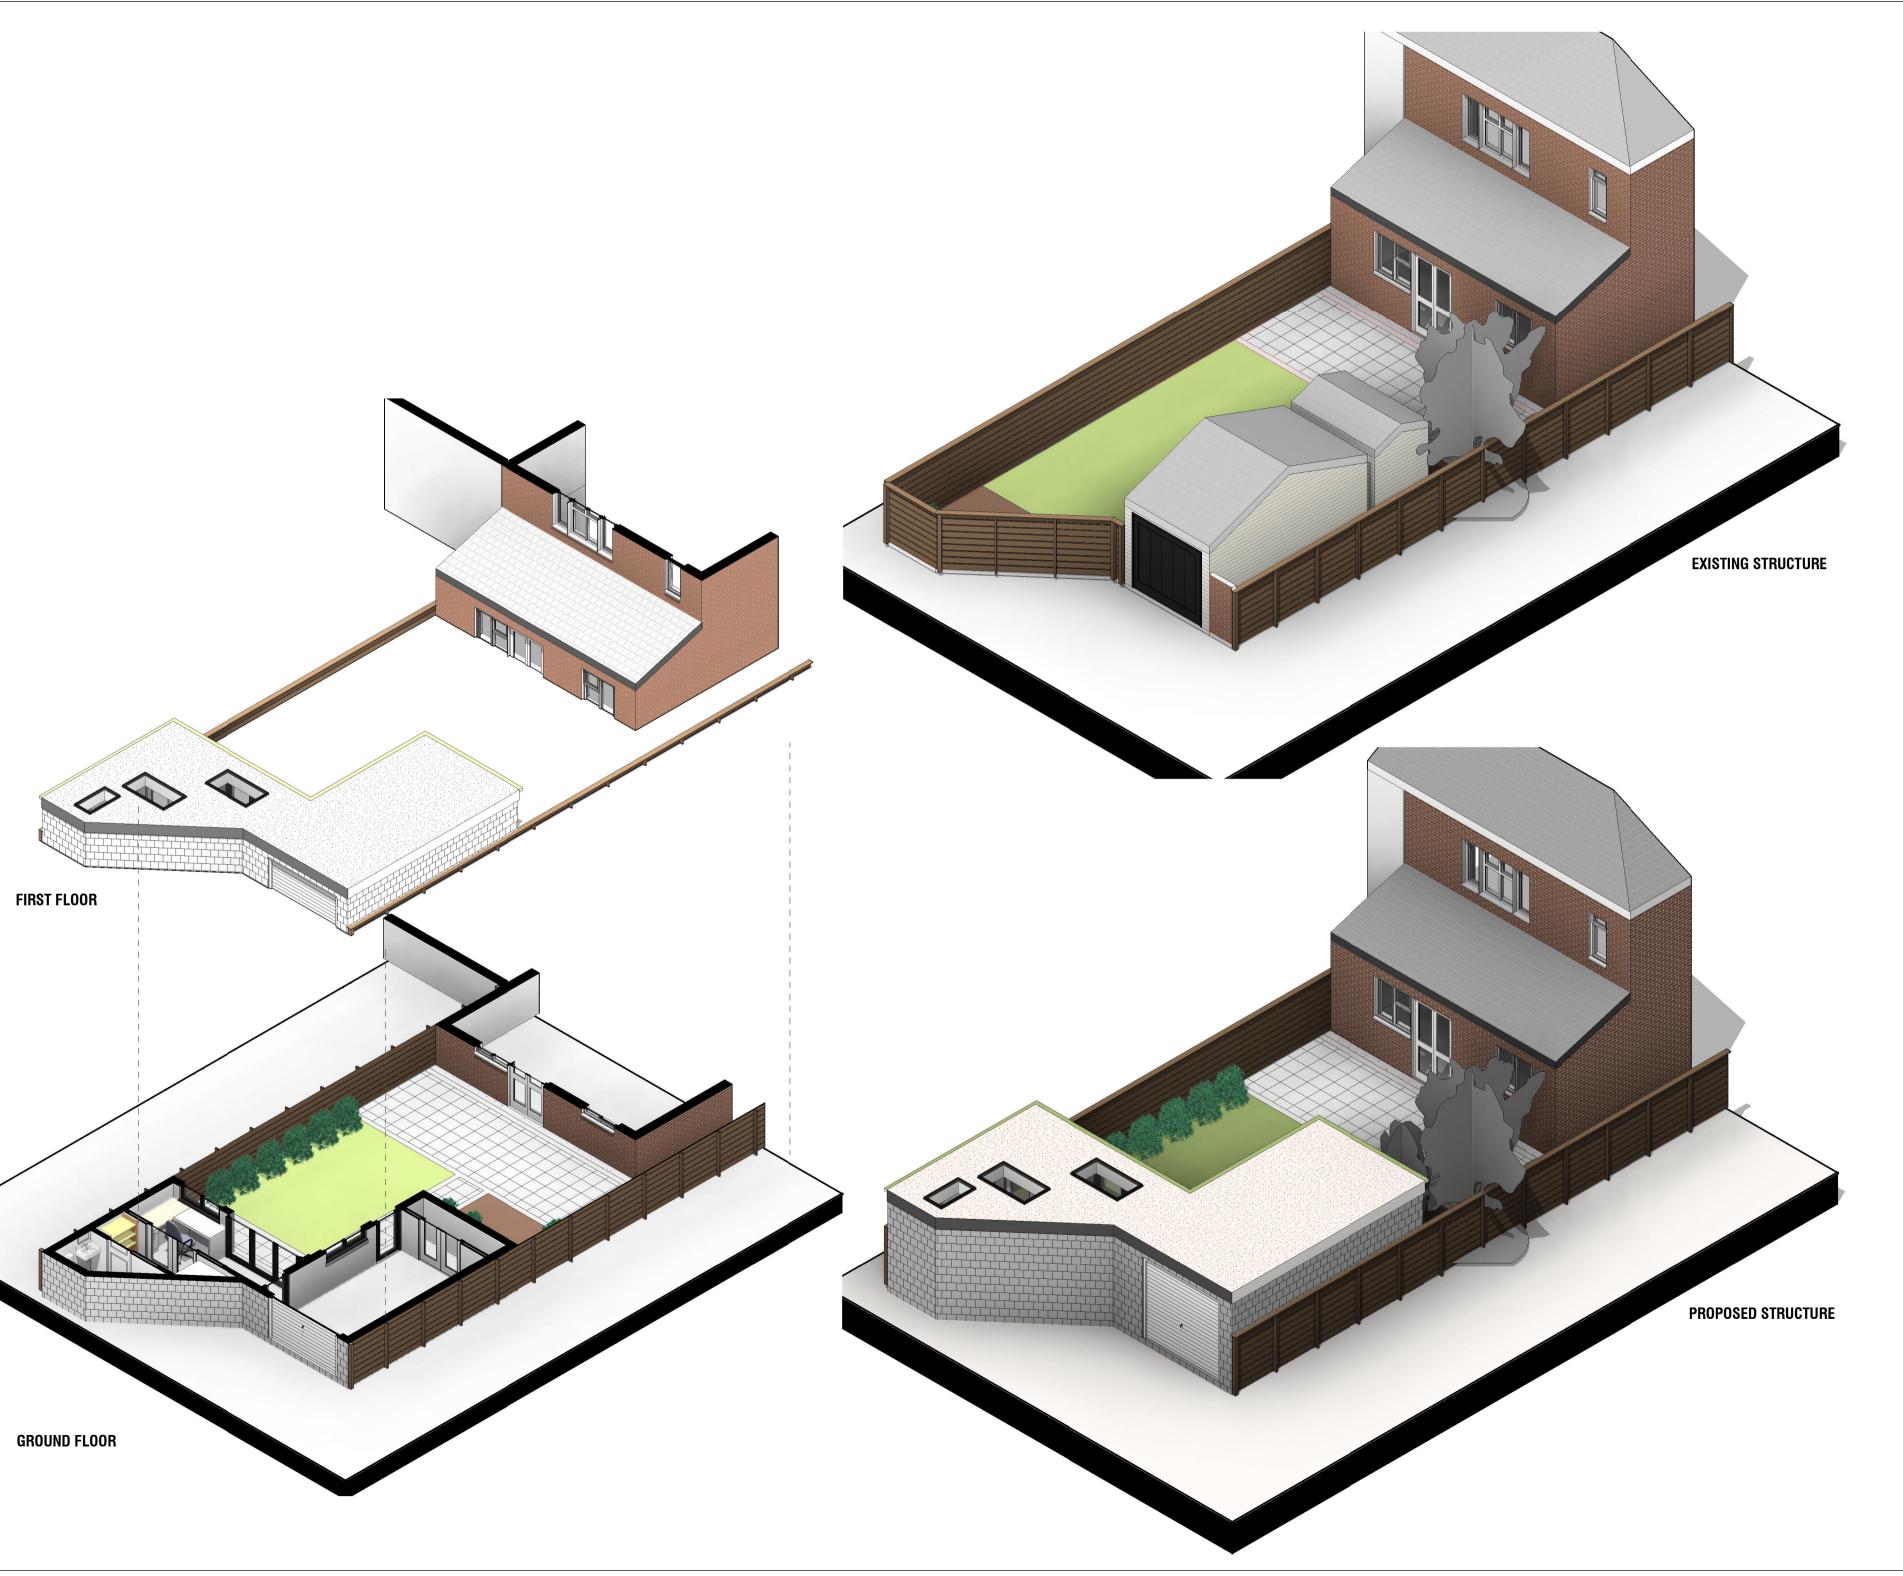
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Proposed Elevations

1 : 50 @A2 Date: 28/06/2022



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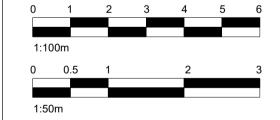
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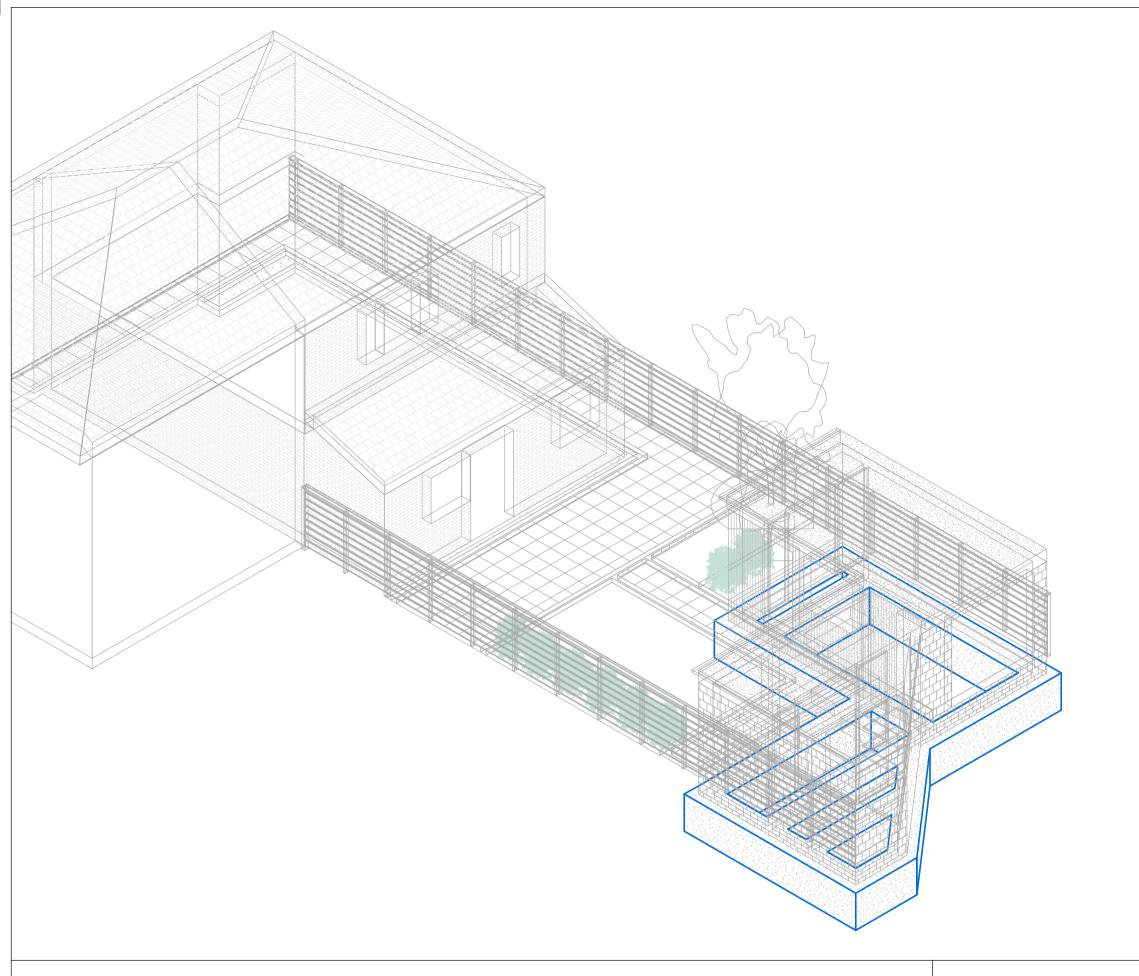
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Drawing Title: Isometric Plans

> Date: 28/06/2022 @A2



#### DOOR AND FRAME SCHEDULE (TBC) DOOR STR. STR. LEAF LEAF LEAF FIRE NO. | HEIGHT | WIDTH | HEIGHT | WIDTH | THK | RATING | LOCATION NOTES GBD01 2040 | 1200 | 2051 38 GBD02 2040 | 830 | 2040 | 830 | 44 GBD03 | 2100 | 2500 0 GBD04 | 2040 | 830 | 2040 | 830 | 44 GBD05 | 2040 | 1500 | 2051 38 GBD06 | 2040 | 830 | 35 44 GBD07 | 2100 | 2300 | 2100 | 2300 | 44

\* All entrance doors to be fitted with simple type fastening from the inside for means of escape such as thumb turns (Euro cylinder lock and thumb turn)

Door stops to be inserted to comply with current Building Regulations

\*All doors to be supplied and installed by specialist/contractor

\*All Doors to be Standard Sizes


Provide 100mm cavity closer 'Cavi 120 Type V' or equivalent for window and door opening All windows to be supplied and installed by specialist/contractor

\*All windows from the first floor up to have window restrictors fitted \*Glazing below 800 and 1500 mm in doors and side panels from floor level to be in safety glass to BS 6206Sizes to be crosschecked on site prior ordering

WINDOW SCHEDULE					
WINDOW NO.	WIDTH	HEIGHT	SILL HT.	LOCATION	SPECIFICATIONS
GBW01	1360	1210	900		
GBW02	1360	1210	777		
RW01	740	1360			
RW02	740	1360			
RW03	500	1000			

# **WALL TYPE SCHEDULE - EXTERNAL WALLS**


E-WT-02 OB TIMBER WALL

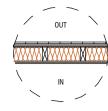

WALL CONSTRUCTION (OUT TO IN):
- FIRE RETARDANT TIMBER CLADDING ON BATTENS
- BREATHABLE MEMBRANE
- 9mm SUPALLX PROMAT FIRE PROTECTION BOARD
- 9mm EXTERIOR STRUCTURAL 0SB3 BOARD
- TIMBER FRAME STUDG USING ISOMM Y SOMM HEAD & SOLE PLATES AND VERTICAL STUDS
(WITH NOGGINS) AT 400MM CTRS (AS PER STRUCTURAL ENGINEER DESIGN AND
SPECIFICATIONS) - IMMER HRAME STUDS USING 150MM X50MM HEAD & SOLE PLAIE (WITH NOEGINS) AT 400MM CTRS (AS PER STRUCTURAL ENDINEER ( SPECIFICATION) - 125mm KINGSPAN KOOLTHERM K7 OR SIMILAR BETWEEM STUDS - POLYTHENE VAPOUR CONTROL LAYER - 12.5MM PLASTERBOARD WITH 3MM SKIM U-VALUE - 0.16W/m²K

## **WALL TYPE SCHEDULE - INTERNAL WALLS**

I-WT-01 INTERNAL TIMBER WALL

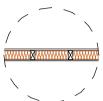


TREATED TIMBER FRAME FRAME STUDS CONSTRUCTED USING 100MM X 50MM HEAD AND SOLE PLATES AND VERTICAL STUDS (WITH NOGGINS) AT 400 MM CTR OR TO S/ENGINEER'S

- FULLY FILLED WITH ACOUSTIC MINERAL WOOL WITH 60kg per M3 DENSITY -12.5MM PLASTERBOARD TO BOTH SIDES OF THE STUDWORK WITH 3MM SKIM

## FLOOR TYPE SCHEDULE

FT-01 CONCRETE FL00R

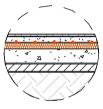

FLOOR CONSTRUCTION (TOP TO BOTTOM):
-10mm 900:900 TILE FLOOR FINISH TBC
-SELF LEVELING COMPOUND
-75mm SAND AND CEMENT SCREED WITH A142 MESH
-Underfloor Heating System as per Manufacturer's Specification
-VAPOUR CONTROL LATER OF MEMORY STATEMENT OF THE STATEMENT Stomm CONCRETE SLAB (AS PER STRUCTURAL ENGINEER DESIGN AND SPECIFICATION)
 Stomm CONCRETE SLAB (AS PER STRUCTURAL ENGINEER DESIGN AND SPECIFICATION)
 1200 CAUGE POL'THERE SHEET (DAMP PROOF MEMBRANE/ RADON BARRIER)
 MIN SOmm SAND BINDING
 MIN SOmm HARD CORE BED LAYER
 U-VALUE - 0.28/m/2K

## **ROOF TYPE SCHEDULE**

RT-02 FLAT ROOF (WARM DECK)



- POLYTHENE VAPOUR CONTROL LAYER
- 18mm PLYWOOD DECKING
- COUNTER FIRRINGS TO GIVE 1:40 FALL
- TIMBER JOISTS AS PER STRUCTURAL EN U-VALUE - 0.18 W/m2K

All Windows Powder Coated White Aluminium double glazing minimum and to achieve U-value of 1.2W/m2k. Provide 100mm cavity closer 'Cavi 120 Type V' or equivalent for window and door opening. All glazing to be supplied and

installed by specialist/contractor \*All windows to be fitted with trickle vents \*All windows from the first floor up to have window restrictors fitted \*All windows with Splash and Cill (on Exterior) \*All windows with "Fly Mesh"

\*All windows with Splash and Cill (on Exterior) \*Ground Floor Windows Triple Glazed \*

Double up rafters to new rooflights. All glazing to be supplied and installed by specialist/contractor. All Rooflights to be Self Cleaning and Motorised/Remote Operated

## **INTERIOR FINISHES SCHEDULE**

FL00R F1 900 x 900mm Porcelain Tiles F2 600 x 600mm Bathroom Porcelain Tiles F3 | Wood Floor/Laminate

C1 | 3mm skim to plaster board with Delux Silk matt emulsion/water-proof paint finish (TBC)

W1 3mm skim to plaster board with Delux Silk matt emulsion finish (TBC)

W2 600 x 600 Polished Wall Tiles TBC

S2 | Tile upstand (same finish as floor)

S1 Classic Ogee MDF 125mm (TBC)

GENERAL NOTES:
1. DO NOT SCALE FROM THESE DRAWINGS. 2. THIS DRAWING TO BE READ IN CONJUNCTION WITH ALL RELEVANT

ARCHITECT'S AND ENGINEER'S DRAWINGS, DETAILS AND SPECIFICATIONS.

3. THESE NOTES TO BE READ WHEN REFERRING TO ALL DRAWINGS.

4. THE WORKS DESCRIBED AND SPECIFIED ON THIS DRAWING AND ASSOCIATED DRAWINGS SHALL BE UNDERTAKEN IN ACCORDANCE WITH ALL CURRENT HEALTH AND SAFETY LEGISLATION.

5. THE CONTRACTOR SHALL AT THE OUTSET, ESTABLISH WITH THE LOCAL AUTHORITY THEIR REQUIREMENTS FOR INSPECTING THE WORKS, AND ADHERE TO THESE. 6. ALL DIMENSIONS AND LEVELS SHOWN ON THE DRAWINGS ARE BASED ON

SURVEY DRAWINGS AND THE CONTRACTOR IS TO SATISFY HIMSELF THAT DIMENSIONS, LEVELS, ETC., ARE SUFFICIENTLY ACCURATE AND COMPLETE FOR

7. THE STEELWORK CONTRACTOR/FABRICATOR IS TO CONDUCT AN ACCURATE SITE SURVEY TO DETERMINE FINAL DIMENSIONS FOR ALL NEW STEELWORK PRIOR TO FABRICATION. THE SURVEY SHOULD HIGHLIGHT ANY EXISTING OBSTRUCTIONS, SERVICES, ETC. THAT NEED TO BE ALTERED/RELOCATED TO AVOID A CLASH.

HE SPECIFIED TOLERANCES OF ALL PREFABRICATED ELEMENTS.

8. STEELWORK IS TO BE HIGH YIELD (5355) UNLESS NOTED

(MAX SPACING) VERTICALLY

9. ALL STEEL TO HAVE 1/2 HOUR FIRE RESISTANCE CAPABILITY MIN. (E.G. 12.5 MM FIRELINE PLASTERBOARD WITH 3MM SKIM.)

10. ALL STEELWORK BUILT INTO PERIMETER WALLS OR POTENTIALLY DAMP LOCATIONS SHALL BE COATED ADDITIONALLY WITH 2 COATS
OF BITUMINOUS PAINT

11. ALL STEELWORK TO BE SHOT BLASTED AND PRIMED WITH 75 MICRONS OF ZINC PHOSPHATE BEFORE DELIVERY TO SITE.

12. ALL BOLTS TO BE GRADE 8.8 IN ACCORDANCE WITH BS 3692 AND HOT DIP SPUN GALVANIZED TO COMPLY WITH EN ISO 1461 UNLESS NOTED OTHERWISE ON THE DRAWINGS.

13. ALL STEELWORK CONNECTIONS TO BE DESIGNED BY FABRICATOR SHOWN IN ENGINEERS CALCULATIONS TO PROVIDE FULL MOMENT/CONTINUITY WHERE INDICATED. UNLESS NOTED OTHERWISE, CONNECTIONS TO BE DESIGNED FOR A MINIMUM SHEAR OF Vult = 50KN. APPEARANCE OF ALL CONNECTIONS WILL NEED TO BE AGREED TO SUIT ARCHITECTS AESTHETIC

14. THE STEELWORK CONTRACTOR/FABRICATOR IS TO SUBMIT DUPLICATE COPIES OF ALL SHOP/SITE DETAILS TO 'FLUID' FOR COMMENT AT LEAST ONE WEEK PRIOR TO FABRICATION.

15. WELD TESTS TO BE CARRIED OUT TO COMPLY WITH THE LATEST EDITION OF THE NATIONAL STRUCTURAL STEELWORK SPECIFICATION FOR BUILDING CONSTRUCTION'. 'FLUID' IS TO BE PROVIDED WITH COPIES OF ALL WELD TEST RESULTS

16. WELDING IS TO COMPLY WITH BS EN 288.

17. IF IN DOUBT ABOUT THE INFORMATION SHOWN ON THIS DRAWING OR ANY RELATED DRAWING-PLEASE ASK.

18. THE CONTRACTOR HAS SOLE RESPONSIBILITY FOR THE DESIGN OF ALL TEMPORARY WORKS. 19. WHERE NEW BRICK/BLOCK MEETS EXISTING MASONRY IT SHOULD BE BONDED IN OR CONNECTED WITH A FURFIX WALL EXTENSION PROFILE SYSTEM. TIES ARE TO BE PROVIDED AT 225rnm CENTRES

20. ALL STRUCTURAL BEAMS AND COLUMNS ARE TO BE FIRE PROTECTED IN ACCORDANCE WITH THE SURVEYORS DETAILS AND CURRENT BUILDING REGULATION REQUIREMENTS. ALLOW MINIMUM 60 MINUTES UNLESS NOTED OTHERWISE.

21. CONCRETE PADSTONES ARE TO BE LOCATED UNDER ALL NEW STEEL BEAMS TO ACT AS LOAD SPREADERS ONTO NEW OR EXISTING MASONRY. ALL PADSTONES ARE TO BE GRADE C35110 CONCRETE IN ACCORDANCE WITH BS 5328.

22. ALL LINTELS TO HAVE A MINIMUM 150mm END BEARING INTO NEW BRICKWORK/BLOCKWORK AND 225mm END BEARING IN EXISTING BRICKWORK UNLESS NOTED OTHERWISE.

23. ALL BLOCKWORK TO HAVE A MINIMUM COMPRESSIVE STRENGTH OF n2, MAXIMUM DENSITY 1500kg/rn3.

24. ALL TIMBER TO BE GRADE C24 PRESSURE IMPREGNATED WITH PRESERVATIVE TO BS 5268.

25. ALL EXISTING LINTELS ARE TO BE INSPECTED AND REPLACED IF THEY SHOW SIGNS OF DETERIORATION, CRACKING. OR DISTRESS. THE MATERIAL NATURE OF ANY REPLACEMENT IS TO BE APPROVED BY THE LOCAL AUTHORITY PRIOR TO INSTALLATION.

FOR LACK OF BOND/ DELAMINATION, ETC. IF SUCH AREAS ARE NOTED, THE CLIENT'S ENGINEER IS TO BE INFORMED IMMEDIATELY. THE CONTRACTOR SHALL ARRANGE FOR THE DESIGN AND INSTALLATION OF A SUITABLE REMEDIAL TIE SYSTEM.

27. SHOULD ANY EXISTING WALL PROVE TO BE INADEQUATELY INSTALLATION OF SUITABLE REMEDIAL WORKS TO PROVIDE ADEQUATE LATERAL RESTRAINT AND SUBMIT THE DESIGN TO THE

28. THE CONTRACTOR IS TO PROVIDE TEMPORARY WORKS TO PROVIDE LATERAL AND VERTICAL RESTRAINT TO EXISTING WALLS PRIOR TO DEMOLITION OF ANY PART OF THE EXISTING BUILDING

29. THE CONTRACTOR SHALL ALLOW FOR THE FOLLOWING ROOF

29. THE CONT NACTOR SHALL ALLOW FOR THE POLLOWING ROOF CONSTRUCTION AS WELL AS THAT SHOWN ON THE DRAWINGS ALL HOLDING DOWN STRAPS, LATERAL RESTRAINT STRAPS, FIXINGS AND CONNECTION PLATES. TIES AND ANY ROOF BRACING REQUIRED. IN ADDITION THE CONTRACTOR SHALL ALLOW FOR ALL CEILING JOISTS AND BATTENS THAT MAY BE REQUIRED. 30. FLOOR JOISTS STRAPPED TO MAIN BRICK WALLS IN ACCORDANCE

A3 DISPROPORTIONATE COLLAPSE GUIDELINES.

31. IN ALL CASES THE EXISTING WALLS WILL REQUIRE THE FOLLOWING REMEDIAL WORKS :a. ALL EXISTING STEELWORK AND TIMBERS NOT REQUIRED TO BE

CAREFULLY REMOVED.
THE CONTRACTOR SHOULD OBTAIN THE APPROVAL OF THE RELEVANT LOCAL AUTHORITIES PRIOR TO THIS WORK BEING

b. ALL MINOR CRACKS ARE TO BE REPAIRED USING 1:1:6 MORTAR. III) ANY MORTAR/BRICKWORK THAT IS JUDGED BY THE CONTRACTOR ANY MORT AR/BRICKWORK THAT IS JUDGED BY THE CONTRACTOR OR THE CLIENT'S ENGINEER OR THE LOCAL AUTHORITY REPRESENTATIVE TO BE CRUMBLY, SOFT, DETERIORATED. ETC., IS TO BE REMOYED AND REBUILT IN BONDED ENGINEERING BRICK, FACING BRICK OR BLOCK AS APPROPRIATE. ALL EARSTING INTERNAL MASONRY WALL OPENINGS NO LONG. REQUIRED ARE TO BE IN-FILLED IN BONDED BRICK/BLOCK AS APPROPRIATE.

c. ALL STRAIGHT JOINTS UNCOVERED ARE TO BE TIED ACROSS BY MEANS OF PROPRIETARY GALVANIZED STEEL STRAPPING.

d. IF CRACKS WITH AN APERTURE GREATER THAN 2mm ARE d. IF CHACKS WITH AN APERTURE GREATER THAN 2mm ARE UNCOVERED, THE CONTRACTOR SHALL PROVIDE STITCHING USING 900mm LONG X 100mm WIDE X 65mm DEEP PRE-CAST CONCRETE LINTELS AT 900mm CENTRE'S VERTICALLY. THE LINTELS ARE TO BE INSERTED ON A 1:1:6 MORTAR BED AND PACKED WITH A 1:1:6 SEMI-DRY MORTAR WELL RAMMED.




Bischell - Design & Build -

Suite 114
80 Cumberland House, Scrubs Lane
Hammersmith & Fulham, NW106RF

27 Welland Gardens Perivale Greenford UB6 8SZ Drawing Title: Structural/ Architectural Schedules

Drawn By: Scale: As indicated @A2 28/06/2022

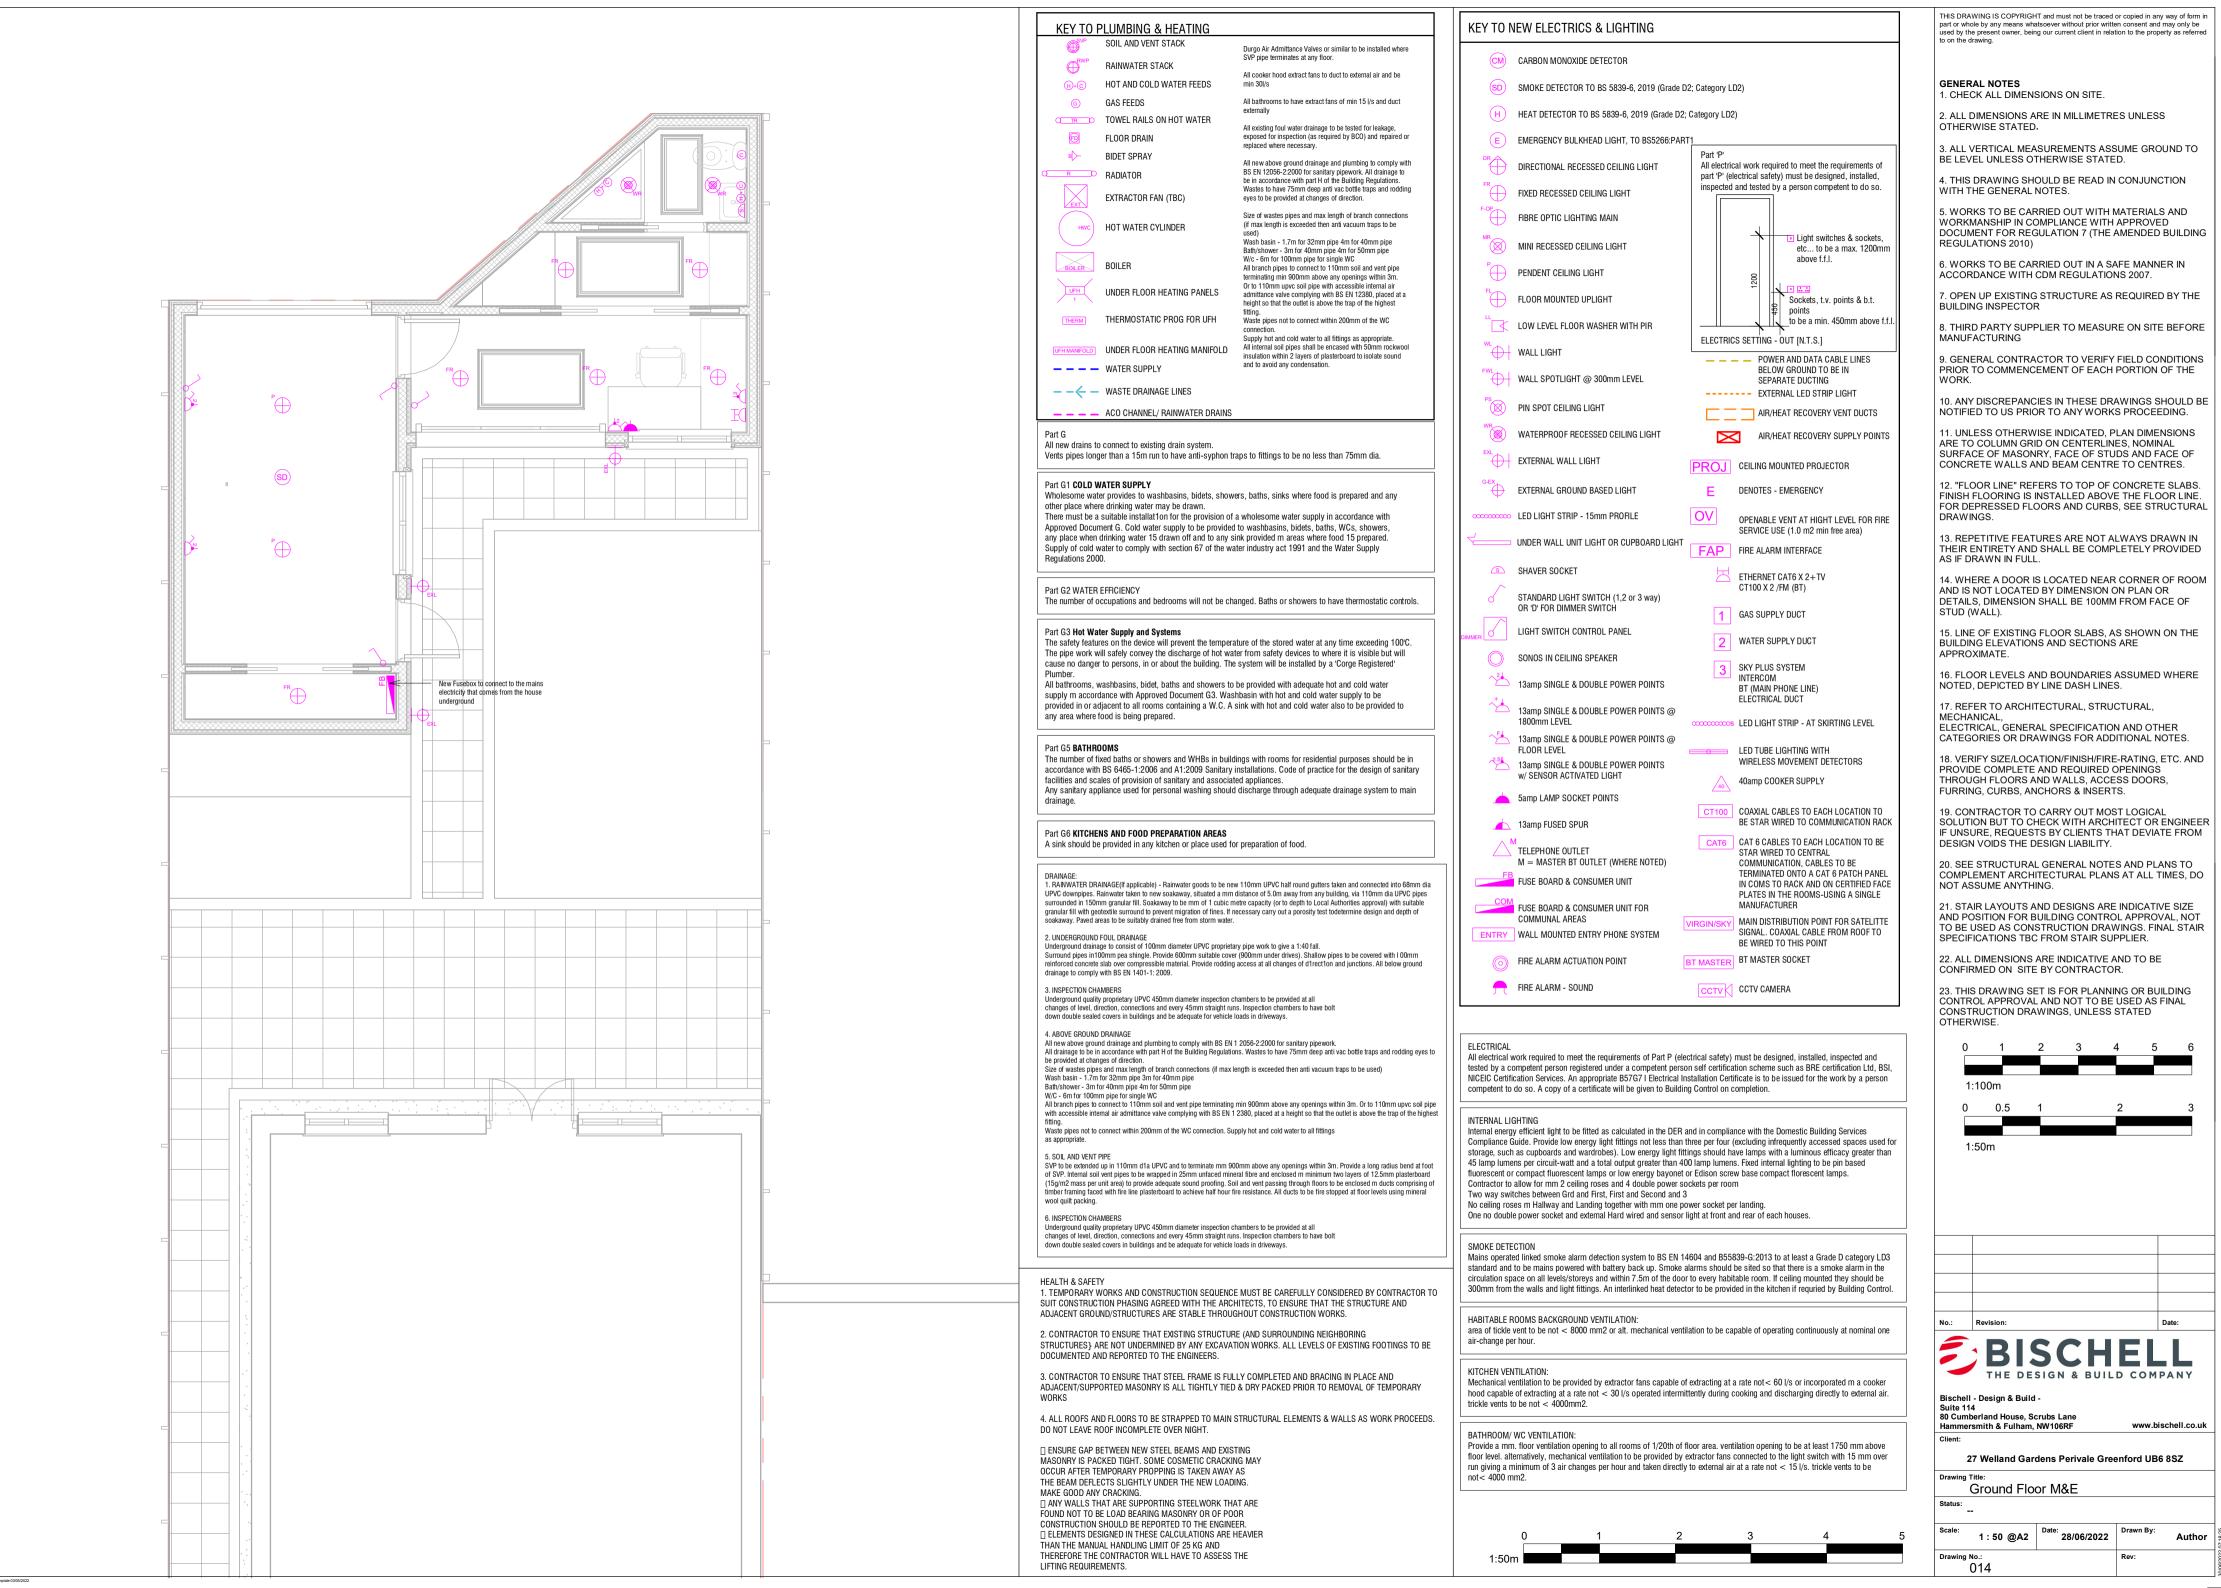





3D View C



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GENERAL NOTES

1. CHECK ALL DIMENSIONS ON SITE.

2. ALL DIMENSIONS ARE IN MILLIMETRES UNLESS OTHERWISE STATED.

3. ALL VERTICAL MEASUREMENTS ASSUME GROUND TO

BE LEVEL UNLESS OTHERWISE STATED. 4. THIS DRAWING SHOULD BE READ IN CONJUNCTION WITH THE GENERAL NOTES.

5. WORKS TO BE CARRIED OUT WITH MATERIALS AND WORKMANSHIP IN COMPLIANCE WITH APPROVED DOCUMENT FOR REGULATION 7 (THE AMENDED BUILDING

6. WORKS TO BE CARRIED OUT IN A SAFE MANNER IN ACCORDANCE WITH CDM REGULATIONS 2007.

7. OPEN UP EXISTING STRUCTURE AS REQUIRED BY THE

8. THIRD PARTY SUPPLIER TO MEASURE ON SITE BEFORE MANUFACTURING

9. GENERAL CONTRACTOR TO VERIFY FIELD CONDITIONS PRIOR TO COMMENCEMENT OF EACH PORTION OF THE WORK.

10. ANY DISCREPANCIES IN THESE DRAWINGS SHOULD BE

NOTIFIED TO US PRIOR TO ANY WORKS PROCEEDING. 11. UNLESS OTHERWISE INDICATED, PLAN DIMENSIONS ARE TO COLUMN GRID ON CENTERLINES, NOMINAL SURFACE OF MASONRY, FACE OF STUDS AND FACE OF

CONCRETE WALLS AND BEAM CENTRE TO CENTRES. 12. "FLOOR LINE" REFERS TO TOP OF CONCRETE SLABS. FINISH FLOORING IS INSTALLED ABOVE THE FLOOR LINE. FOR DEPRESSED FLOORS AND CURBS, SEE STRUCTURAL

13. REPETITIVE FEATURES ARE NOT ALWAYS DRAWN IN THEIR ENTIRETY AND SHALL BE COMPLETELY PROVIDED AS IF DRAWN IN FULL.

14. WHERE A DOOR IS LOCATED NEAR CORNER OF ROOM AND IS NOT LOCATED BY DIMENSION ON PLAN OR DETAILS, DIMENSION SHALL BE 100MM FROM FACE OF STUD (WALL).

15. LINE OF EXISTING FLOOR SLABS, AS SHOWN ON THE BUILDING ELEVATIONS AND SECTIONS ARE APPROXIMATE.

16. FLOOR LEVELS AND BOUNDARIES ASSUMED WHERE NOTED, DEPICTED BY LINE DASH LINES.

17. REFER TO ARCHITECTURAL, STRUCTURAL, MECHANICAL, ELECTRICAL, GENERAL SPECIFICATION AND OTHER CATEGORIES OR DRAWINGS FOR ADDITIONAL NOTES.

18. VERIFY SIZE/LOCATION/FINISH/FIRE-RATING, ETC. AND PROVIDE COMPLETE AND REQUIRED OPENINGS THROUGH FLOORS AND WALLS, ACCESS DOORS, FURRING, CURBS, ANCHORS & INSERTS.


19. CONTRACTOR TO CARRY OUT MOST LOGICAL SOLUTION BUT TO CHECK WITH ARCHITECT OR ENGINEER IF UNSURE, REQUESTS BY CLIENTS THAT DEVIATE FROM DESIGN VOIDS THE DESIGN LIABILITY.

20. SEE STRUCTURAL GENERAL NOTES AND PLANS TO COMPLEMENT ARCHITECTURAL PLANS AT ALL TIMES, DO NOT ASSUME ANYTHING.

21. STAIR LAYOUTS AND DESIGNS ARE INDICATIVE SIZE AND POSITION FOR BUILDING CONTROL APPROVAL, NOT TO BE USED AS CONSTRUCTION DRAWINGS. FINAL STAIR SPECIFICATIONS TBC FROM STAIR SUPPLIER.

22. ALL DIMENSIONS ARE INDICATIVE AND TO BE CONFIRMED ON SITE BY CONTRACTOR.

23. THIS DRAWING SET IS FOR PLANNING OR BUILDING CONTROL APPROVAL AND NOT TO BE USED AS FINAL CONSTRUCTION DRAWINGS, UNLESS STATED

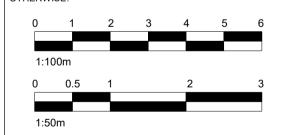

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Bischell - Design & Build -Suite 114 80 Cumberland House, Scrubs Lane Hammersmith & Fulham, NW106RF

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Perspectives

Date: 28/06/2022 Drawing No.: 013

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