



4 PROPOSED SOUTH WEST ELEVATION  
Scale: 1:50

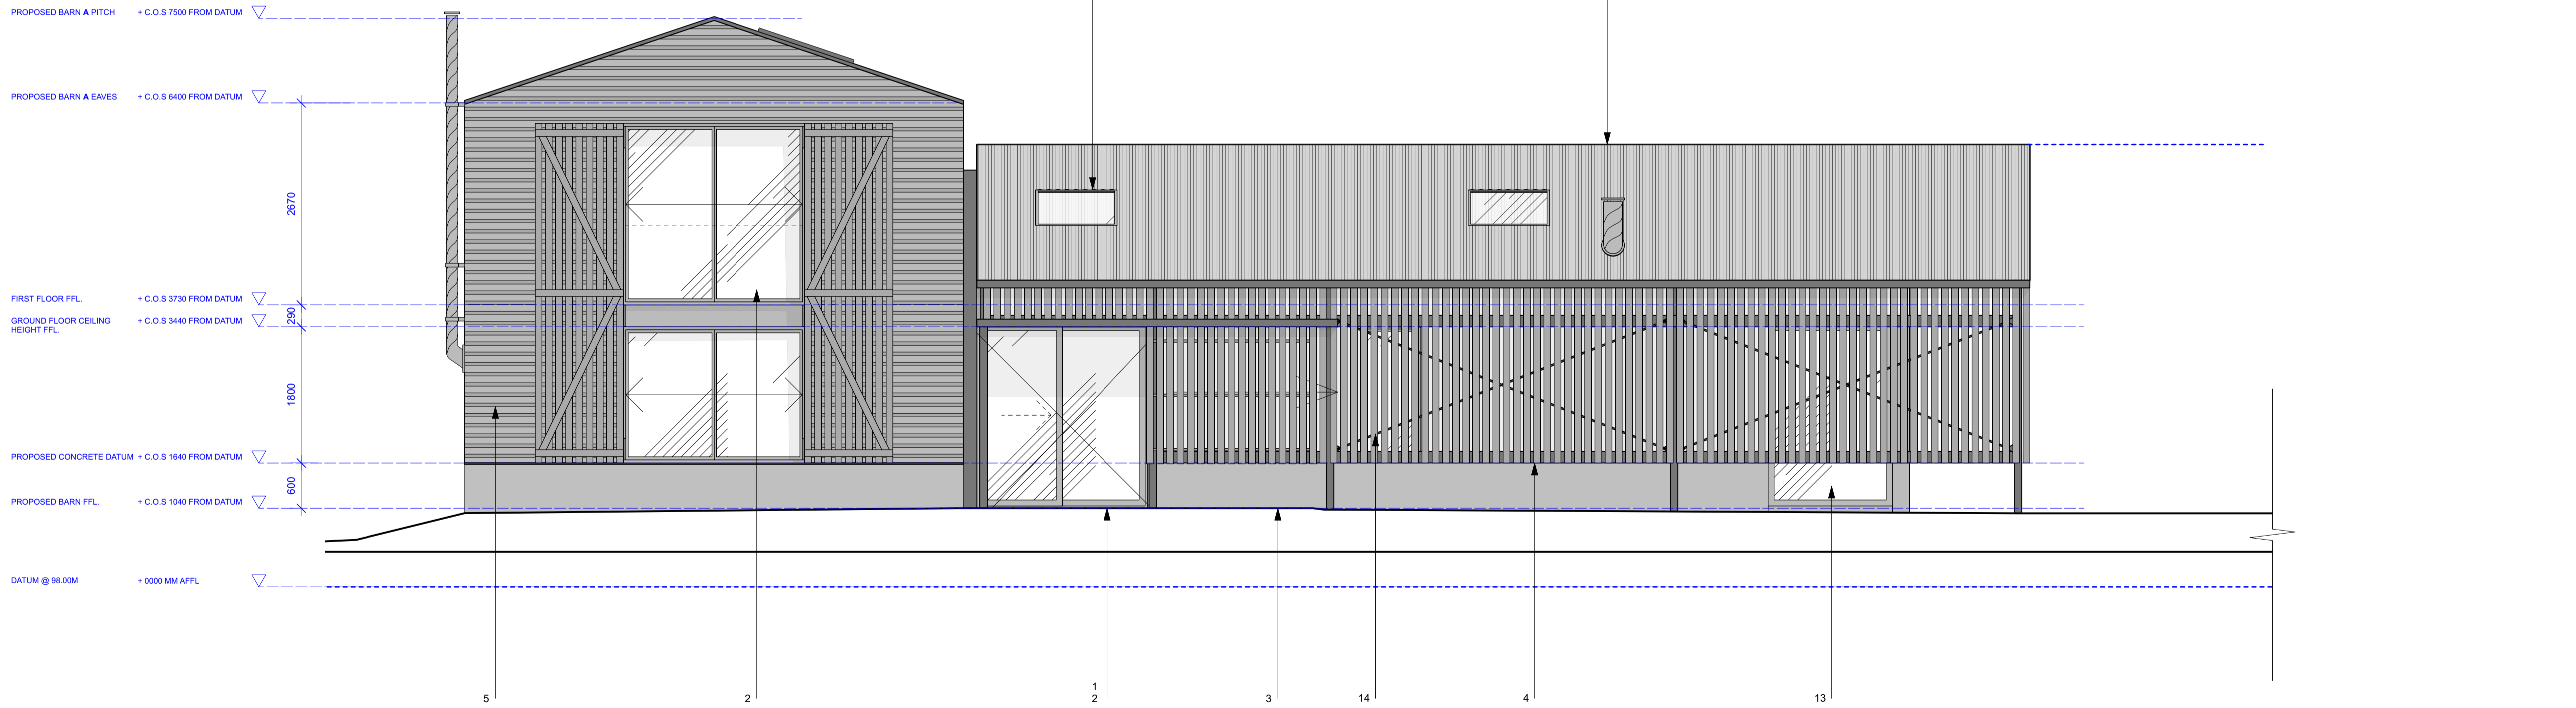

3 PROPOSED NORTH WEST ELEVATION  
Scale: 1:50

NOTES:

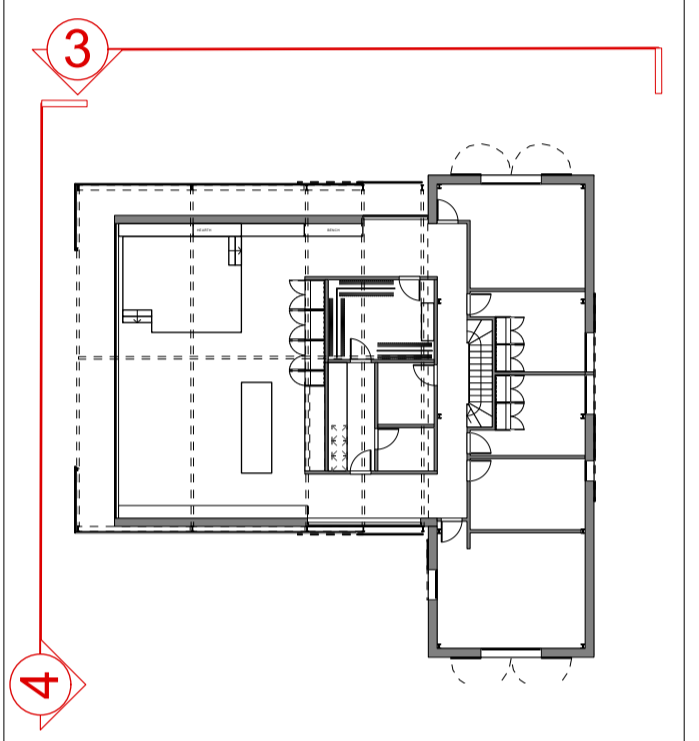

STATUS:  
A

REVISION:

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CLIENT	R & D Lehtonen - Riley		
JOB	TGF Barn		
TITLE	Proposed Elevations		
JOB NO.	3979	DWG. NO.	4001
DRAWN BY	WW	CHECKED BY	SC
SCALE	1:50 @ A1		
DATE	08/22	REV	
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**Notes**

- 600MM CONCRETE UPSTAND.
- INTERNAL BALUSTRADE TO SLIDING DOORS.
- STACK BOND CONCRETE BLOCK WALL.
- HIT AND MISS TIMBER CLADDING.
- HORIZONTAL HIT AND MISS BATTEN CLADDING.
- HORIZONTAL HIT AND MISS BATTENS TO FORM WINDOW SHUTTERS.
- REMOTE OPENABLE ROOFLIGHT TO ALLOW DAYLIGHT INTO STAIRCASE.
- HORIZONTAL HIT AND MISS BATTENS TO FORM CLADDING TO LONG BARN.
- OPENABLE ROOF LIGHT TO BE FLUSH WITH NEW CORRUGATED CEMENT ROOF. NEW ROOF LIGHTS TO REFLECT EXISTING ROOFLIGHT LOCATIONS.
- NEW CORRUGATED CEMENT ROOF TO MATCH EXISTING.
- VERTICAL HIT AND MISS TIMBER CLADDING TO BIG BARN.
- GLAZED SLIDING DOORS TO FORM NEW FRONT DOOR.
- FIXED GLAZED PANEL.
- OPENABLE WINDOW TO BLOCKWORK WALL BEHIND HIT AND MISS CLADDING.