

SCALE 1:20


All works to be carried out in accordance with the following:-

1. UK water industry research Ltd. 'Civil Engineering Specification for the water Industry, 5th Edition.
2. Building Regulations Section 'H'
3. BE EN 752 Drain and Sewers Systems outside buildings.

- Foul Water: Falls in runs - 1:10 max - 1:60 min.
- All new drainage branches to be swept in direction of flow.
- All new drainage branches to be fitted with a RE.

SUDS

- Existing parking area is constructed with a porous build up on free draining stone.
- 1no. unit to have a 250mm wide by a min 200mm deep gravel border to both draining sides.

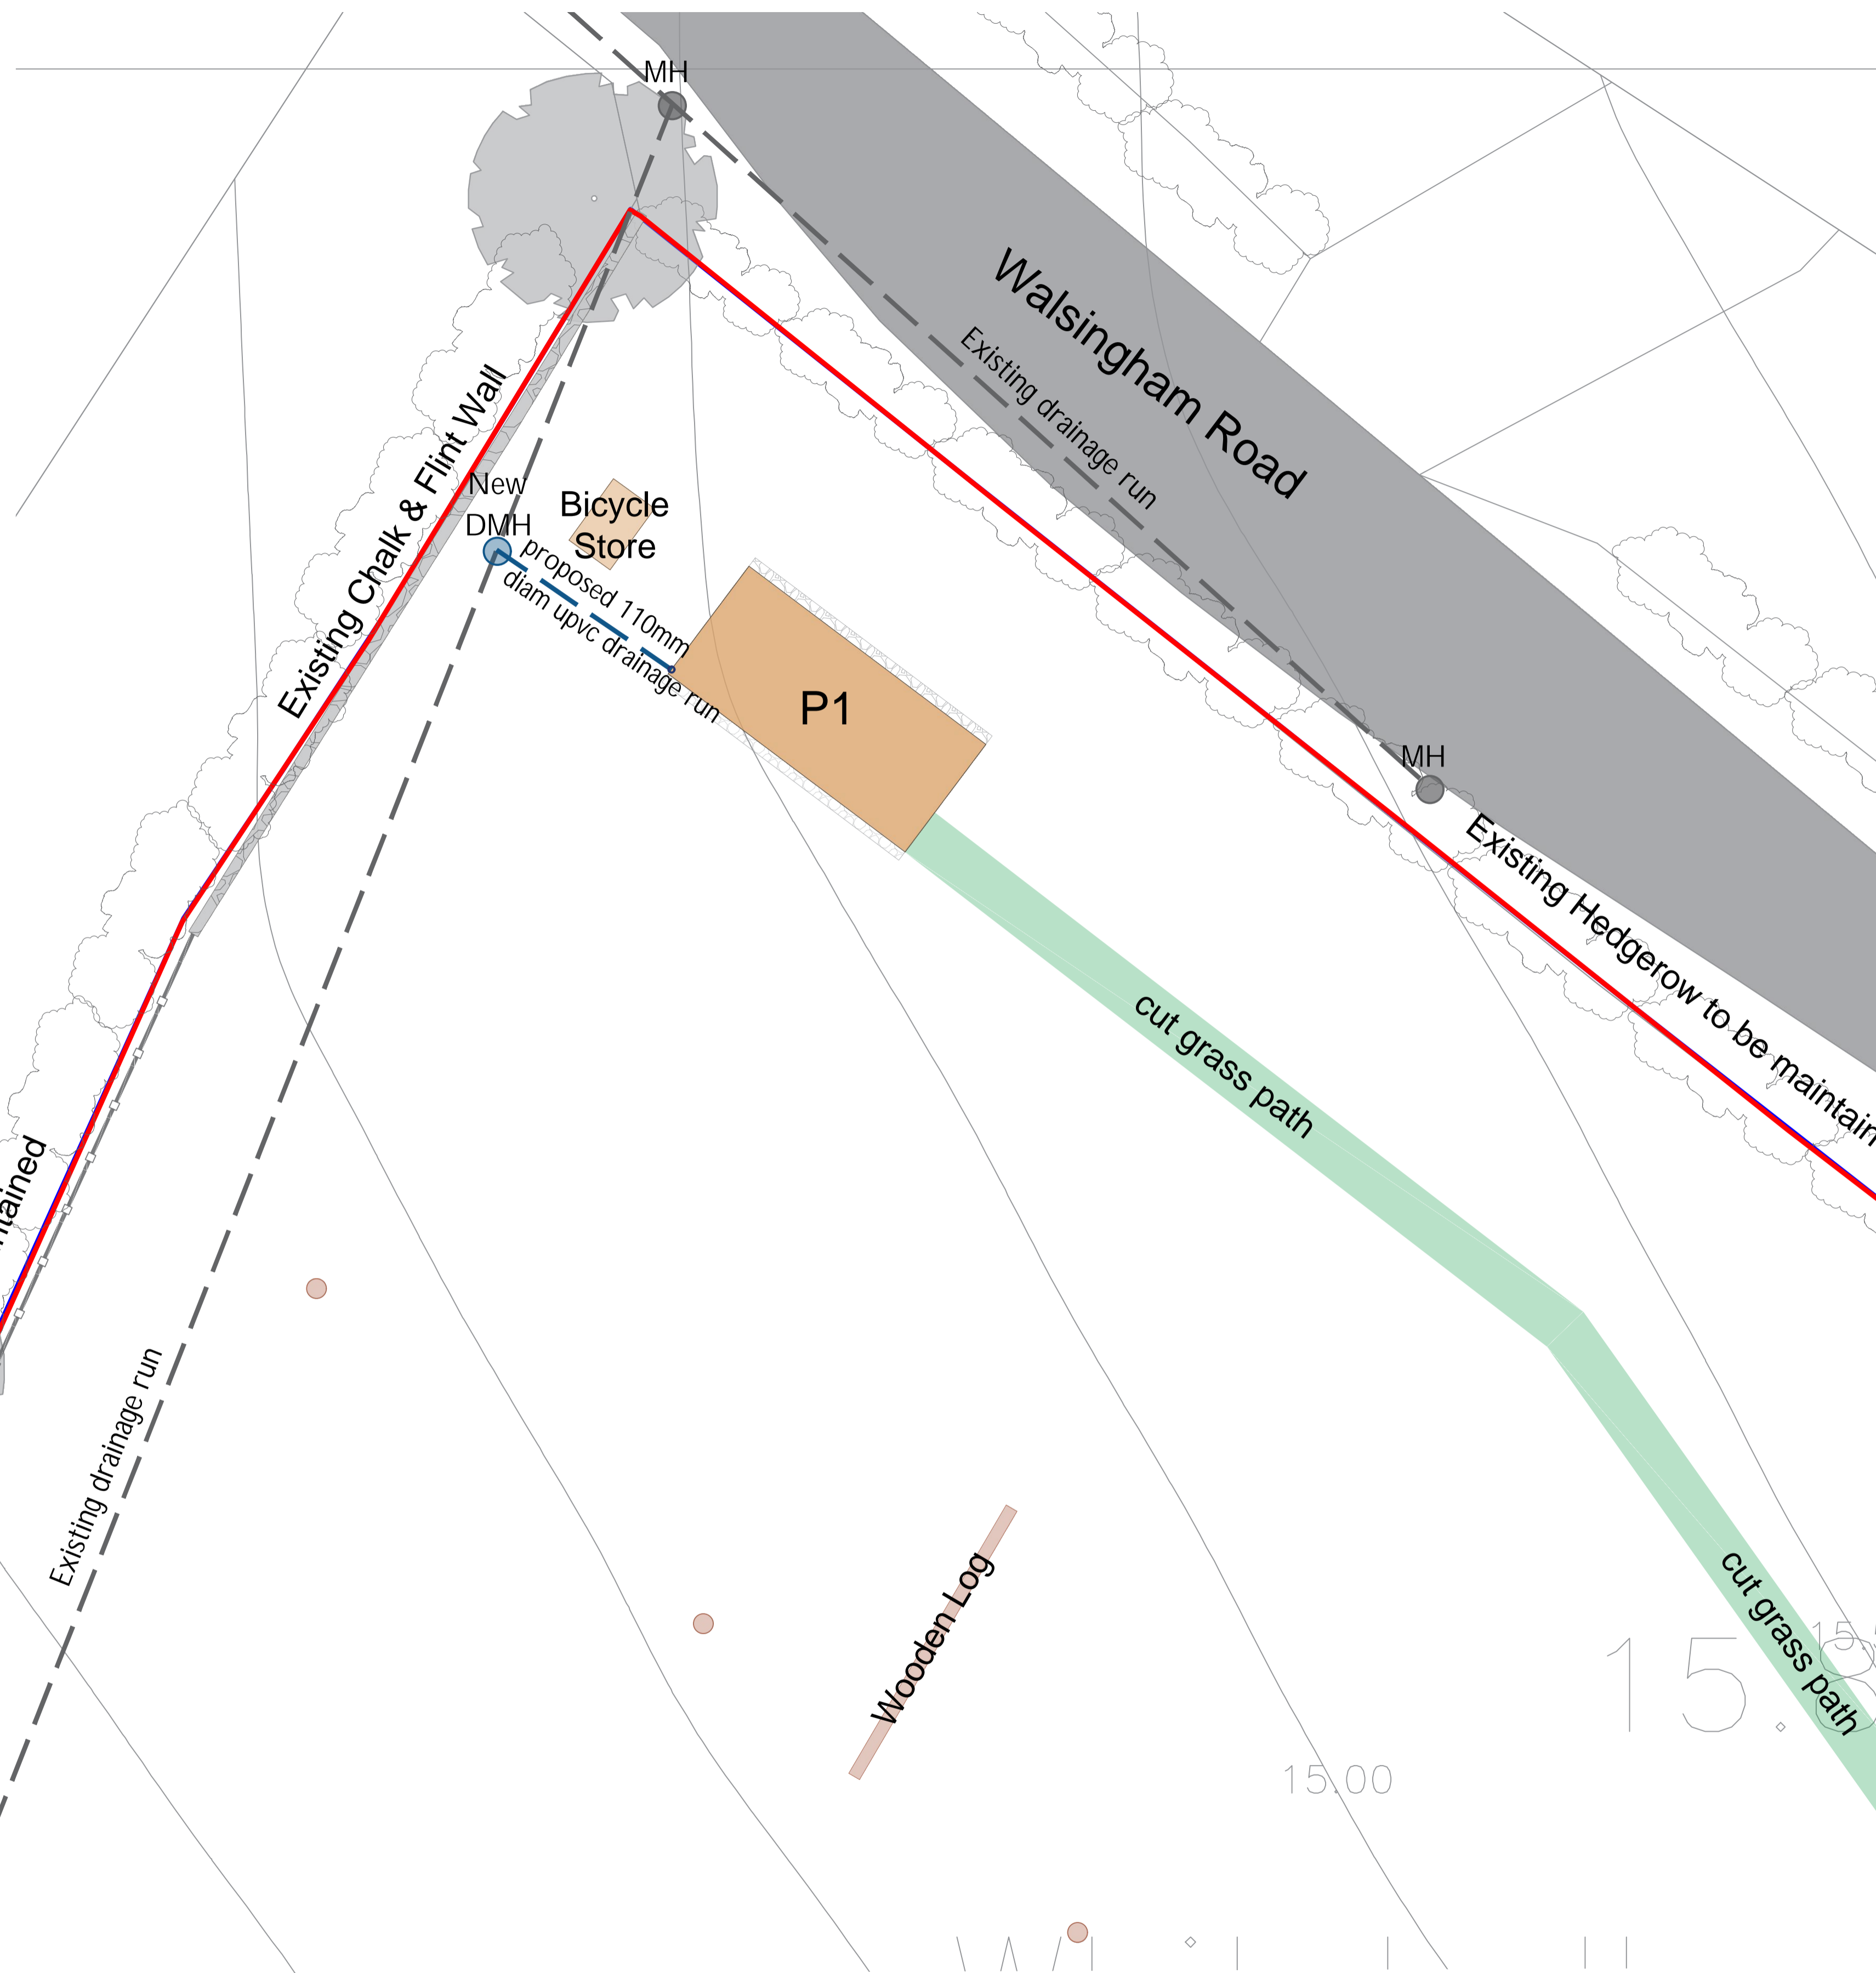


KEY TO SYMBOLS

- PROPOSED DISCONNECTING MANHOLE
- PROPOSED DRAINAGE RUN
- EXISTING FOUL WATER MANHOLE
- EXISTING FOUL WATER DRAINAGE RUN

Date	Description	Rev	By

Revision Description

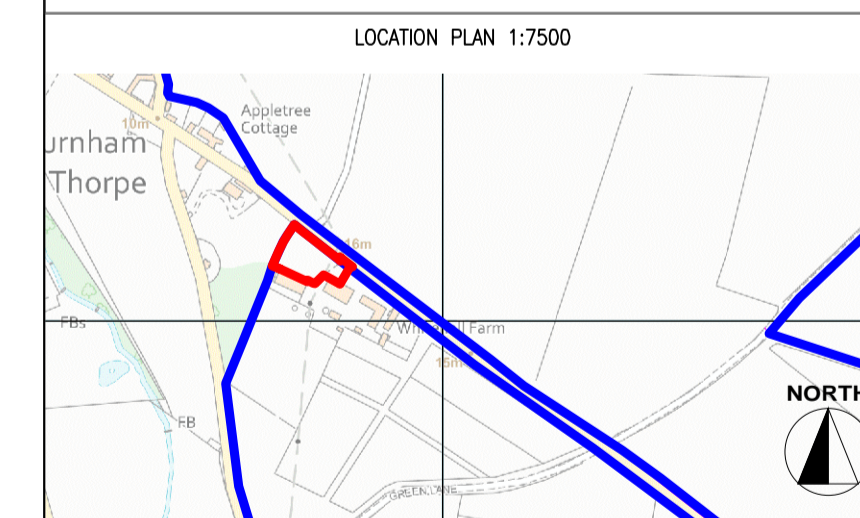

Project:
Proposed Glamping Site - For Valerie Southerland
 Whitehall Farm, Burnham Thorpe, Kings Lynn, Norfolk
 PE31 8HN

Drawing Title:
PROPOSED DRAINAGE PLAN

Drawing Number:
220427-01-04

Revision:
 Date: 08/09/22
 Scale: 1:100 @ A1
 Drawn By: EC
 CAD Dwg File: -
 Checked By: PT

Issue Status:
Full Planning Application

— OWNERSHIP BOUNDARY
 AREA = 1,995,883 m2

— SITE BOUNDARY
 SITE AREA = 2,388 m2

