




SIDE ELEVATION (GRID LINE B)

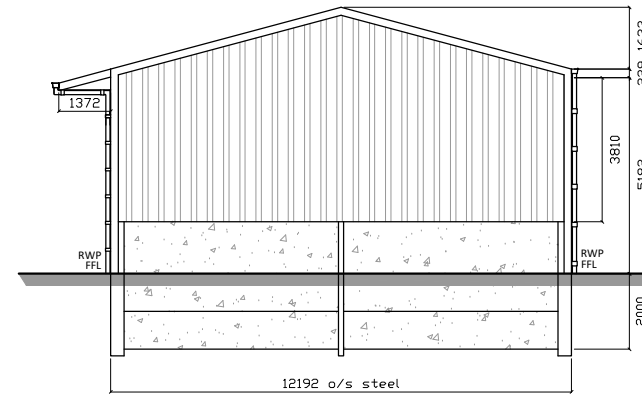


GABLE END (GRID LINE 6)

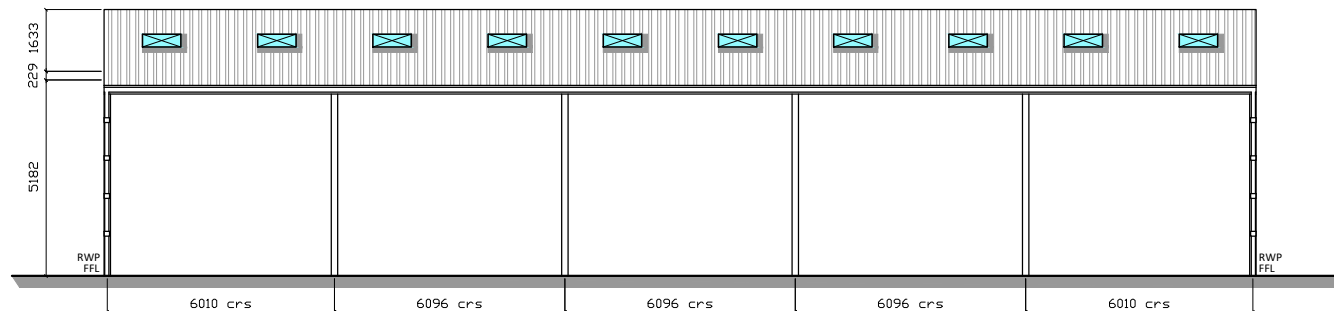

SIDE ELEVATION (GRID LINE A)

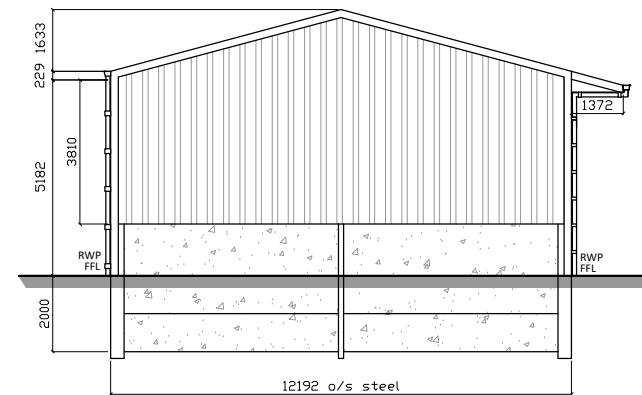

GABLE END (GRID LINE 1)

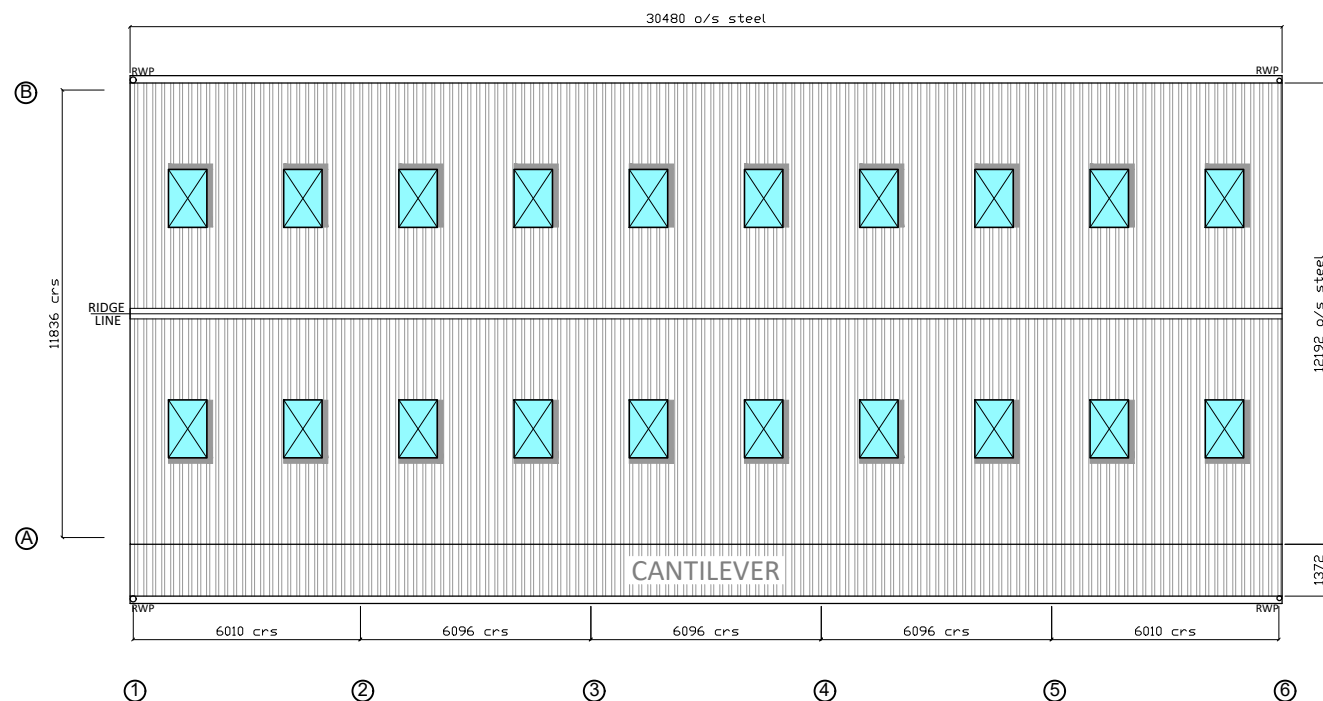

ROOF PLAN

SPECIFICATION:
SIZE:
 30.480m (100') LONG x 12.192m (40') WIDE x 5.182m (17') HIGH TO EAVES WITH A 15° ROOF PITCH WITH A 1.372m (4'6") CANTILEVER TO ONE SIDE.
 ALLOWANCE HAS BEEN MADE FOR ONE SIDE AND BOTH GABLE ENDS TO HAVE 2.000M EXTRA STEEL STRUCTURE:
STANCHIONS: 356mm x 171mm x 45kg UB STANCHIONS
SUB STANCHIONS: 203mm x 133mm x 25kg UB INTERMEDIATE SUB STANCHIONS
RAFTERS: 305mm x 165mm x 40kg UB RAFTERS WITH RAFTER STAYS INCLUDING CHS RAFTER AND SIDE BRACING TO BOTH END BAYS COMPLETE WITH CHS EAVES TIES.
STEELWORK:
 ALL FABRICATED STRUCTURAL STEELWORK DELIVERED TO SITE SHALL INCORPORATE APPROPRIATE "CE" MARKING IN ORDER TO CONFORM TO THE REQUIREMENTS OF BS EN 1090-1.
 ALL STEELWORK TO BE SHOT BLASTED AND PAINTED WITH A RED SEMI OXIDE FINISH.
PURLINS:
 TO SUPPLY 225 X 75 C16 GRADED TANALISED TIMBER PURLINS TO FRAME AT 1.375M CENTRES. EAVES BEAM TO BE 225 X 75 C16 GRADED TANALISED TIMBER.
ROOF CLADDING:
 TO SUPPLY PROFILE 6 REINFORCED CORRUGATED NATURAL GREY FIBRE CEMENT SHEETS. RIDGE TO BE CLOSED. VERGES TO BE FINISHED WITH FIBRE CEMENT BARGE BOARDS.
ROOF LIGHTS:
 INCORPORATE 20 NO. 1.525M CORRUGATED 2.40KG/M² GRP PROFILE 6 ROOF LIGHTS IN ROOF CLADDING POSITIONED TO SUIT CUSTOMER'S REQUIREMENTS.
RAINWATER GOODS:
 EAVES TO HAVE ROBINSONS STANDARD GALVANISED STEEL BOX GUTTER FIXED EXTERNALLY TO BRACKETS WELDED ONTO STANCHIONS, COMPLETE WITH 2 NO. 110MM Ø PVC DOWNPIPES TO EACH SIDE, INCLUDING MASTIC SEALED JOINTS.
END CLADDING:
 BOTH GABLE ENDS TO BE CLAD DOWN TO 3.810M (12'6") BELOW EAVES LEVEL WITH 0.7MM THICK POLYESTER COATED BOX PROFILE STEEL SHEETS ON 150 X 75 C16 GRADED TANALISED TIMBER SHEETING RAILS.
SIDE CLADDING:
 ONE SIDE TO BE CLAD DOWN TO 3.810M (12'6") BELOW EAVES LEVEL WITH 0.7MM THICK POLYESTER COATED BOX PROFILE STEEL SHEETS ON 150 X 75 C16 GRADED TANALISED TIMBER SHEETING RAILS.
DOORS:
 NOT REQUIRED.
CONCRETE PANELS:
 140mm THICK x 3.500m HIGH CONCRETE PANELS TO BOTH ENDS AND ONE SIDE. 1.500M ABOVE FLOOR LEVEL WITH 2.000M BELOW FLOOR LEVEL.

SITE ADDRESS:
 SILVERDALE
 SNITTER
 MORPETH
 NE65 7EL

PLEASE NOTE NO ASSUMPTION SHOULD BE MADE IN RESPECT TO ANY CONSTRUCTIONAL DETAILS FROM THIS DRAWING. ALL DIMENSIONS ON THIS DRAWING MUST BE CONSIDERED APPROXIMATE. VARIATIONS MAY OCCUR DURING DETAILING. DRAWING PRODUCED FOR PLANNING PURPOSES ONLY. DO NOT SCALE. IF IN DOUBT ASK

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DRWN BY: A GOWAN	DATE: 23-09-22
CHK'D BY: A ROBB	DATE: 23-09-22
A3 SCALE: 1:200	
REVISIONS:	
REV.	DATE: DESCRIPTION
DRG. No. RS22-2687A-6775-02	

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