






KEY TO SYMBOLS

-  EXISTING DRAINAGE RUN (INDICATIVE LOCATION)
-  DRAINAGE RUN
-  IC INSPECTION CHAMBER
-  RE RODDING EYE



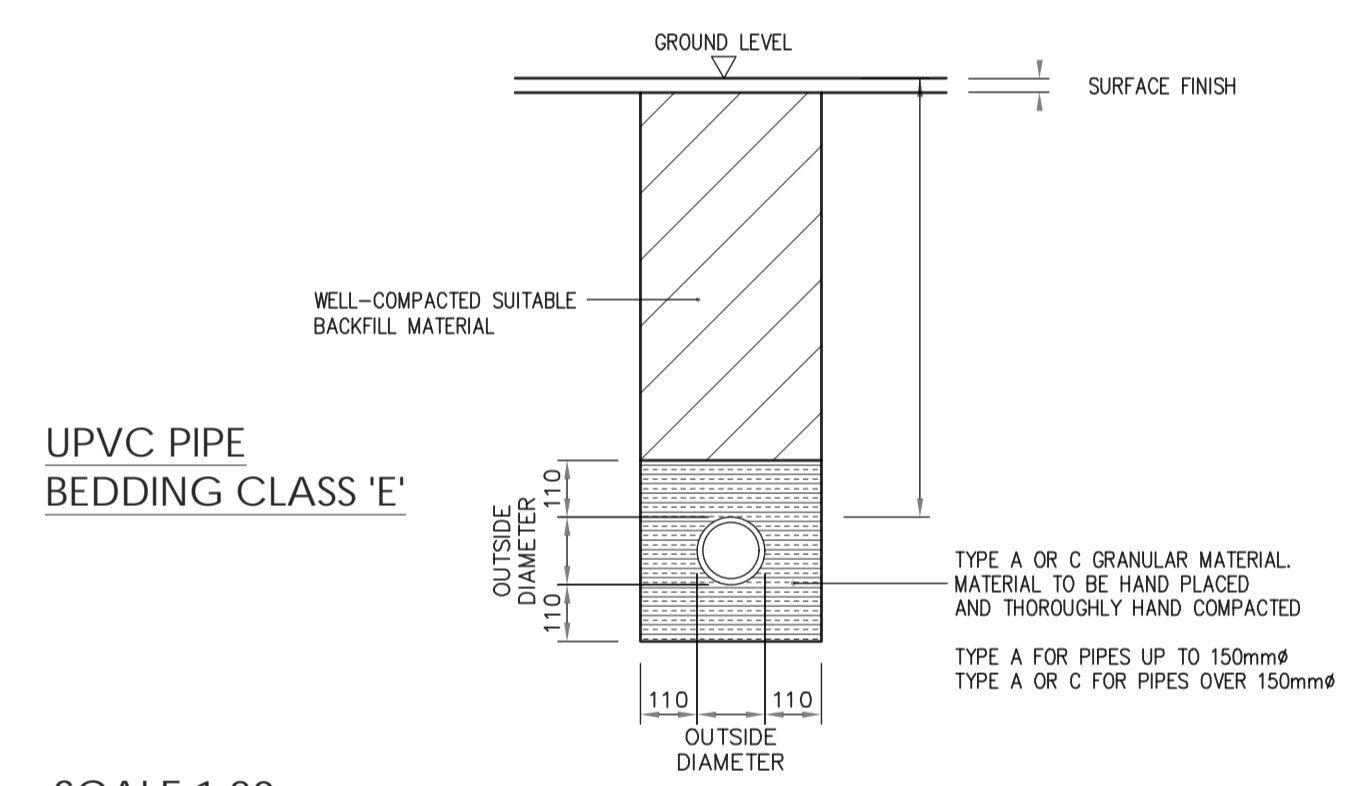


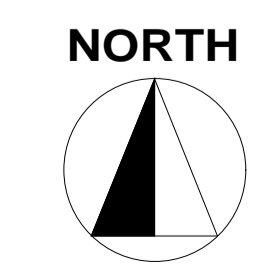
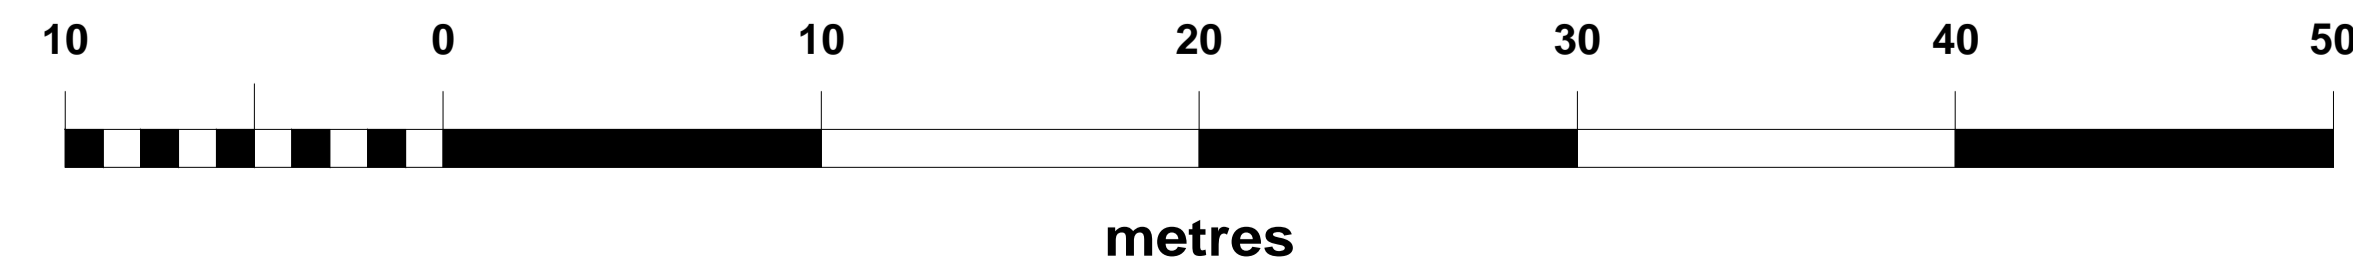
SCALE 1:20

- All works to be carried out in accordance with the following:-
1. UK water industry research Ltd. 'Civil Engineering Specification for the water Industry, 5th Edition.
 2. Building Regulations Section 'H'
 3. BE EN 752 Drain and Sewers Systems outside buildings.

- Foul Water: Falls in runs - 1:10 max - 1:60 min.
- All new drainage branches to be swept in direction of flow.
- All new drainage branches to be fitted with a RE.

- SUDS
- All parking areas are to constructed with a porous build up on free draining stone.
 - All pods to have a 250mm wide by a min 200mm deep gravel border to both draining sides.

-  OWNERSHIP BOUNDARY
-  SHARED ACCESS
-  SITE BOUNDARY



Date	Description	Rev	By

Revision Description



Project:
**Proposed Glamping Site - For Andrew Young
 Middle Farm, Grendon Underwood, Aylesbury
 HP180SP**

Drawing Title:
PROPOSED DRAINAGE PLAN

Drawing Number:
230406-01-04

Revision: A
 Date: 25.05.23
 Scale: 1:200 @ A1
 Drawn By: TA
 CAD Dwg File: -
 Checked By: EC

Issue Status:
Full Planning Application