



- General Notes**
- This drawing is to be read in conjunction with other engineers, designers, subcontractors and specialists drawings and any associated specifications and details. Any discrepancies are to be reported to the CA/client or relevant project manager before proceeding with the works.
 - All workmanship and materials are to be carried out in accordance with current British Standards, Codes of Practice and good building practice.
 - All work to be to the satisfaction of the Building Control checking authority.
 - Do not scale this drawing. All dimensions to be as noted. Contractor to check all dimensions on site before carry out works.
 - Where existing elements are exposed or investigated during the building works and are found to be not as assumed then contractor to confirm and notify CA/design team/client as applicable before proceeding with works.
 - The contractor is responsible for site health & safety including taking all necessary precautions to ensure stability of both existing and proposed structures at all times during construction. Contractor to contact structural engineer immediately where any doubts arise on site.
 - All services/utilities are to be located and protected as necessary by the contractor prior to the commencement of the works.
 - This drawing is for the private and confidential use of the client for whom it was undertaken and it should not be reproduced in whole or in part or relied upon by third parties for any use without the express written authority of Beech Architects Limited.

RESIDUAL RISK TO HEALTH & SAFETY

Whilst we have made every attempt to design out risk associated with our design some risks may remain. Significant residual risks relating to our design are detailed below with our assessment of how these may be managed. The contractor remains responsible for identifying and managing risk associated with construction processes and site safety and these risks should be identified within the contractor's Construction Health & Safety Plan all operations carried out in accordance with HSE requirements, Current Code of Practice and compliance with CDM 2015 regulations.

Numbered triangles further highlight specific locations where residual risks remain:

- 1 - Access equipment for cleaning and maintenance will be required and works undertaken by qualified and competent person.
- 2 - The risks associated with working at height should be reduced by using appropriate scaffold, platforms, mobile elevating equipment, safety nets or fall arrest systems as deemed appropriate by the contractor's review and assessment of the construction methodology & process.
- 3 - The locations of all existing services and utilities must be confirmed prior to commencement of the works.
- 4 - The engineer must be contacted immediately where unsure or concern raised regarding the stability of any structure.

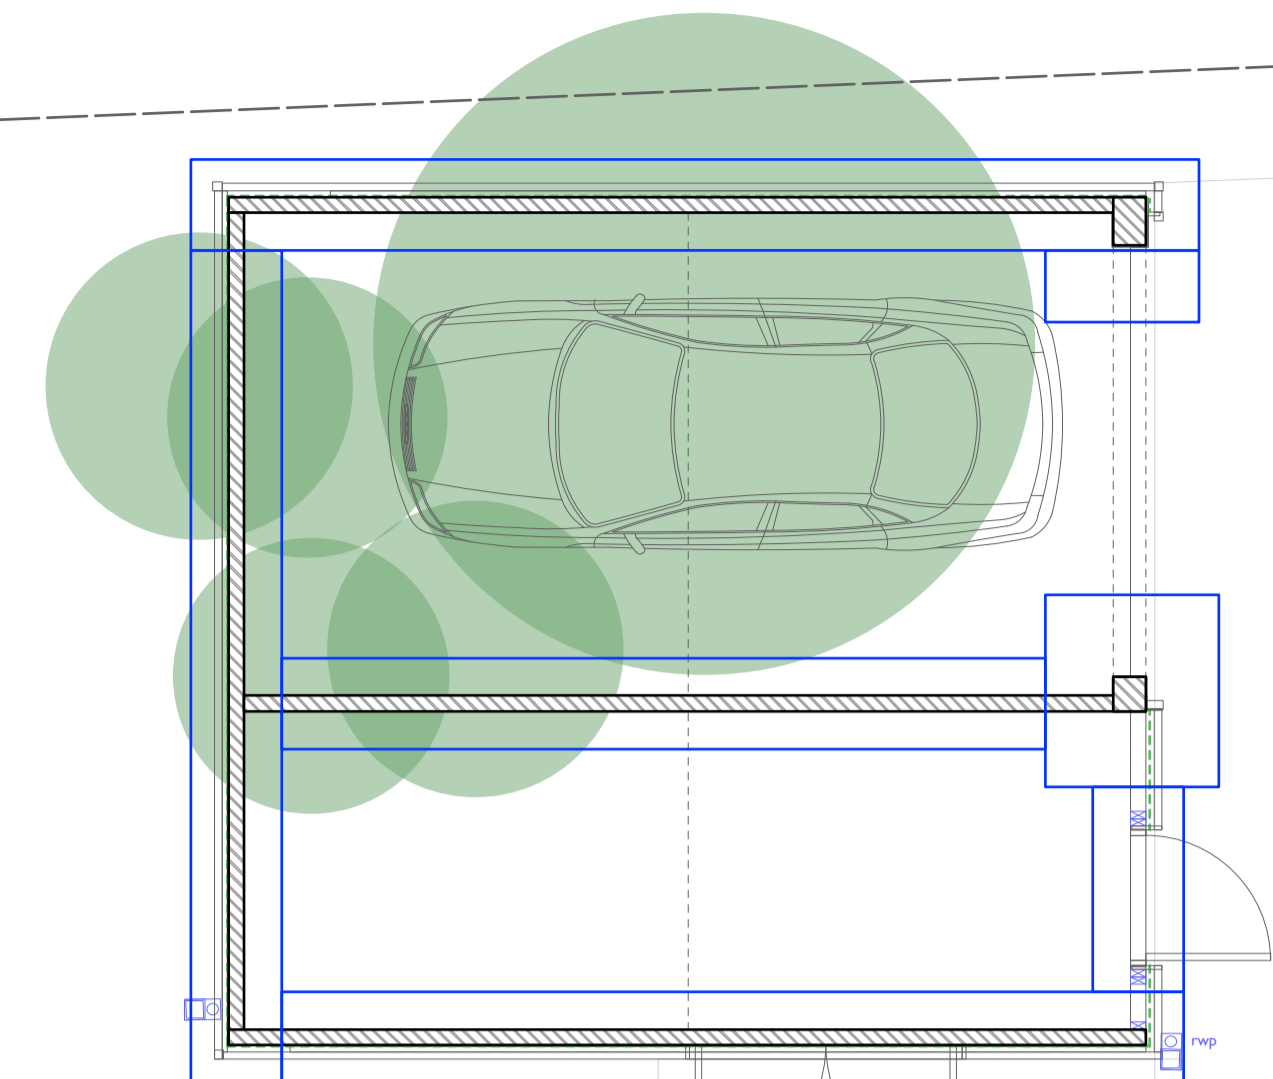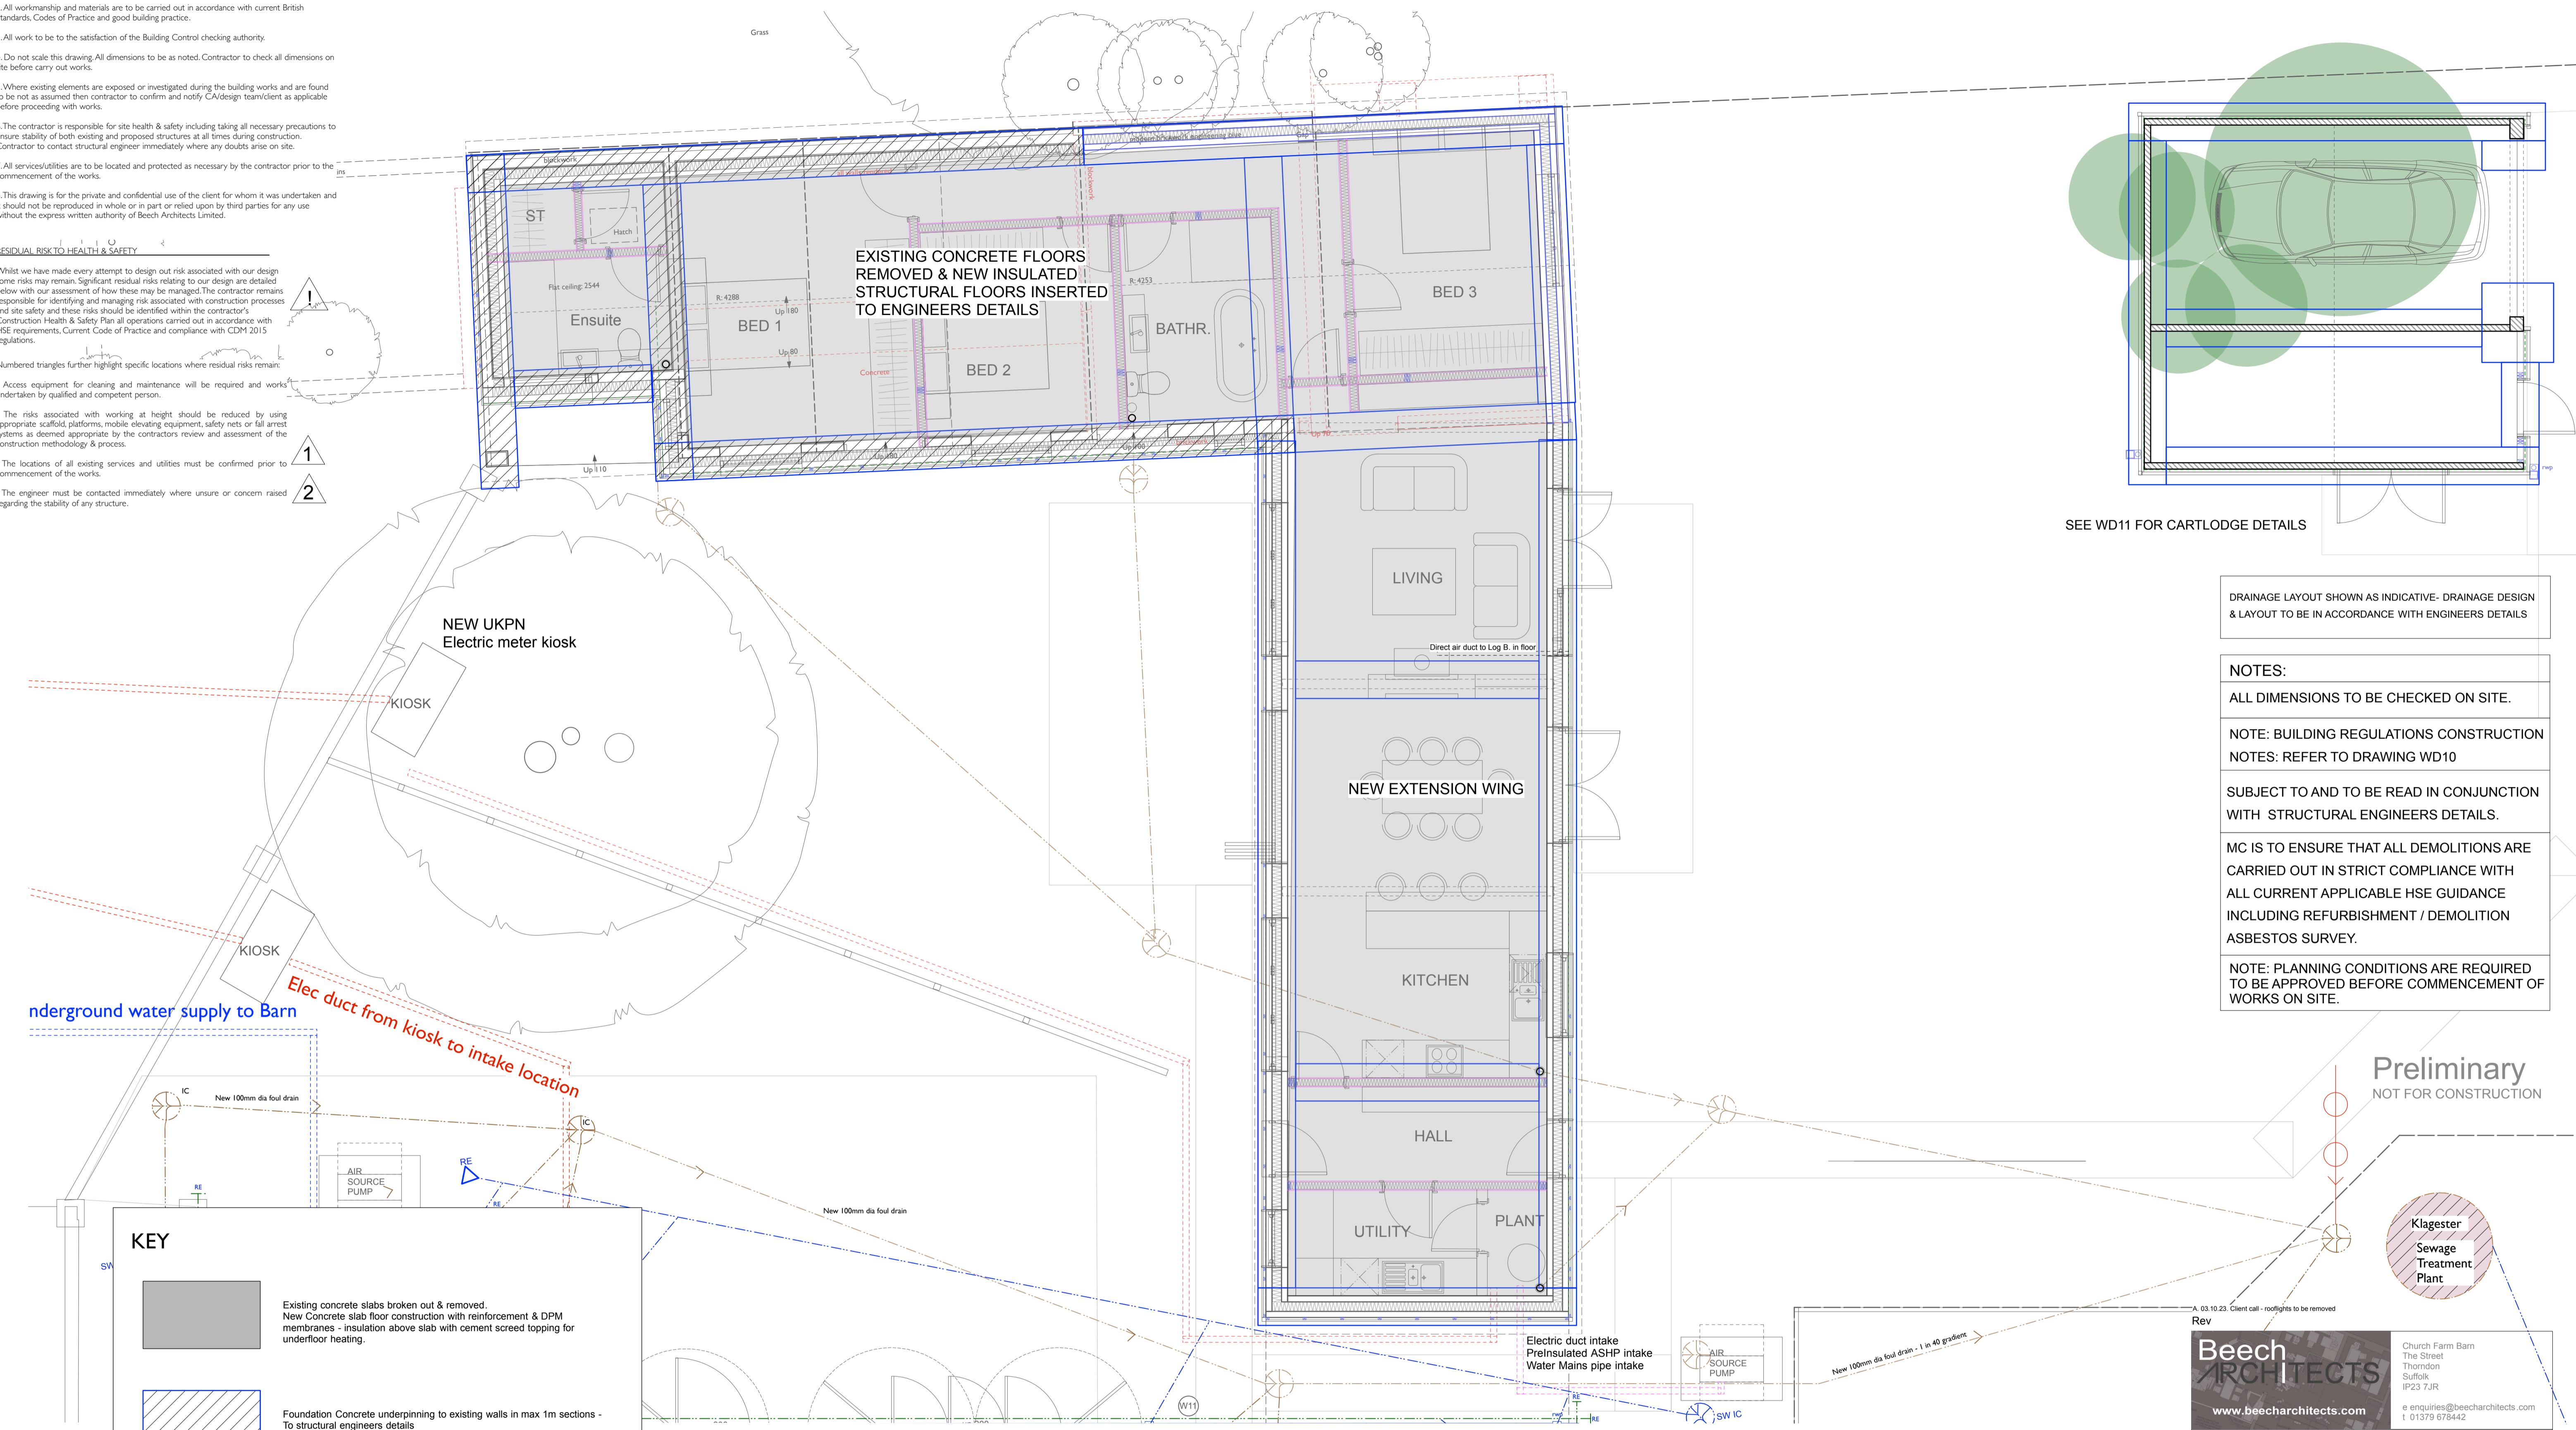


SEE WD11 FOR CARLUDGE DETAILS

DRAINAGE LAYOUT SHOWN AS INDICATIVE- DRAINAGE DESIGN & LAYOUT TO BE IN ACCORDANCE WITH ENGINEERS DETAILS

- NOTES:**
- ALL DIMENSIONS TO BE CHECKED ON SITE.
 - NOTE: BUILDING REGULATIONS CONSTRUCTION NOTES: REFER TO DRAWING WD10
 - SUBJECT TO AND TO BE READ IN CONJUNCTION WITH STRUCTURAL ENGINEERS DETAILS.
 - MC IS TO ENSURE THAT ALL DEMOLITIONS ARE CARRIED OUT IN STRICT COMPLIANCE WITH ALL CURRENT APPLICABLE HSE GUIDANCE INCLUDING REFURBISHMENT / DEMOLITION ASBESTOS SURVEY.
 - NOTE: PLANNING CONDITIONS ARE REQUIRED TO BE APPROVED BEFORE COMMENCEMENT OF WORKS ON SITE.

Preliminary
NOT FOR CONSTRUCTION

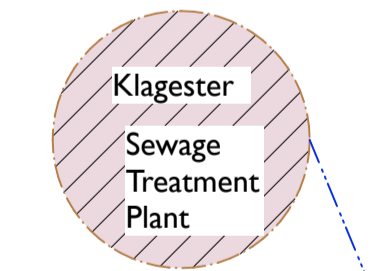


KEY

- Existing concrete slabs broken out & removed. New Concrete slab floor construction with reinforcement & DPM membranes - insulation above slab with cement screed topping for underfloor heating.
- Foundation Concrete underpinning to existing walls in max 1m sections - To structural engineers details
- New concrete foundations to engineers details

ALL FOUNDATIONS TO ENGINEERS DETAILS- REFER TO STRUCTURAL ENGINEERS DRAWINGS FOR DETAILS

REFER TO ENGINEERS DRAWINGS FOR STEELWORK COLUMN POSITIONS AND DETAILS.

STEELWORK FABRICATION:
ALL STEELWORK TO ENGINEERS DETAILS. BARN TO BE SURVEYED BY STEEL FABRICATOR PRIOR TO PRODUCTION OF STEELWORK DRAWINGS. FABRICATION DRAWINGS TO BE PRESENTED TO ENGINEER AND CONTRACTOR FOR APPROVAL PRIOR TO ORDER. ALL SITE DIMENSIONS TO BE CHECKED AND CONFIRMED PRIOR TO ORDER.

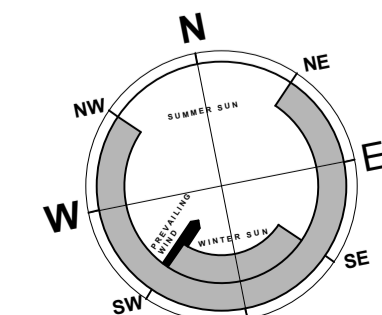

Rev A. 03.10.23. Client call - rooflights to be removed

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PROJECT Harvest Dairy Barn Hoxne Road Eye IP23 7NP			
DRAWING FOUNDATION, PLINTH & DRAINAGE PLAN (PHASE 2)			
SCALE 1:50 @ A1	DATE March 2023	DRAWN BY	CHECKED
DRAWING NUMBER WD02	JOB NUMBER 704	STATUS PRELIMINARY	REV A

FOUNDATION PLINTH SETTING OUT AND DRAINAGE PLAN scale 1:50

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