
Refer to Building Regulation Drawings for Full Specifications - Please Note: We Recommend All Drainage is Surveyed Copyright 2022

4m 5m 1m 2m 3m

VISUAL SCALE 1:50 @ A1


Room Schedule								
						Finish		
Number	Name	Level	Department	Area	Percentage of area	Wall Finish	Floor Finish	Ceiling Finish
Ground Floc	r Plan							
1	Bathroom	Ground Floor Plan		5.67 m ²	7.90%			
2	WC	Ground Floor Plan		2.03 m ²	2.83%			
3	Inner Hall	Ground Floor Plan		1.27 m ²	1.77%			
4	Dining Room	Ground Floor Plan		12.83 m ²	17.89%			
5	Hallway	Ground Floor Plan		7.56 m ²	10.54%			
6	Living Room	Ground Floor Plan		13.31 m ²	18.56%			
7	Porch/Office	Ground Floor Plan		11.37 m ²	15.86%			
8	Kitchen	Ground Floor Plan		8.21 m²	11.44%			
9	Utility Room	Ground Floor Plan		5.88 m ²	8.20%			
10	Boiler Room	Ground Floor Plan		3.59 m ²	5.00%			
Ground Floc	r Plan: 10	· · · · · · · · · · · · · · · · · · ·		71.72 m ²	100.00%			
Total area: 1	0			71.72 m ²				

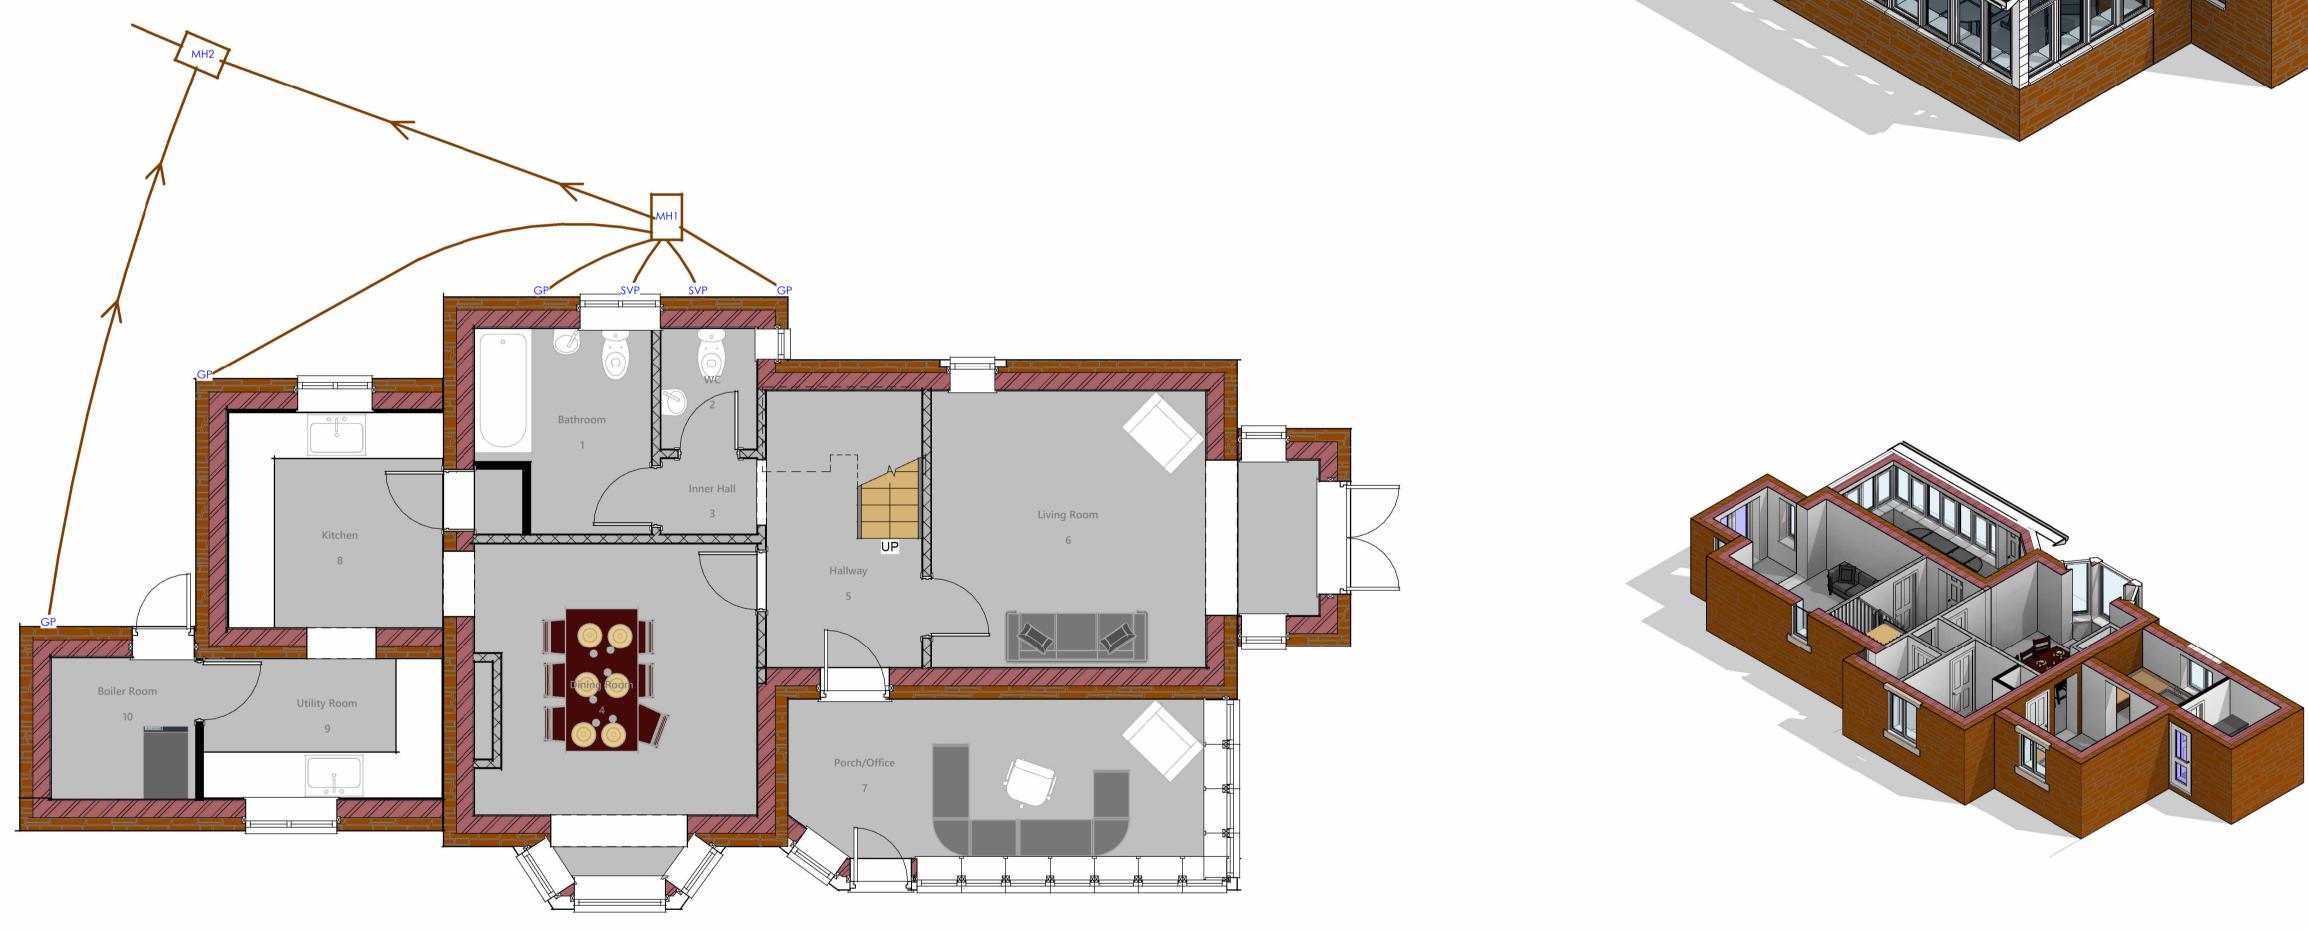



DRAWING NUMBER



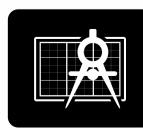


BRO ARCHITECTURE DESIGNING YOUR DREAMS

Mobile: 07508 856621 Website: www.broarchitecture.co.uk E-mail: info@broarchitecture.co.uk

CLIENT

SITE ADDRESS

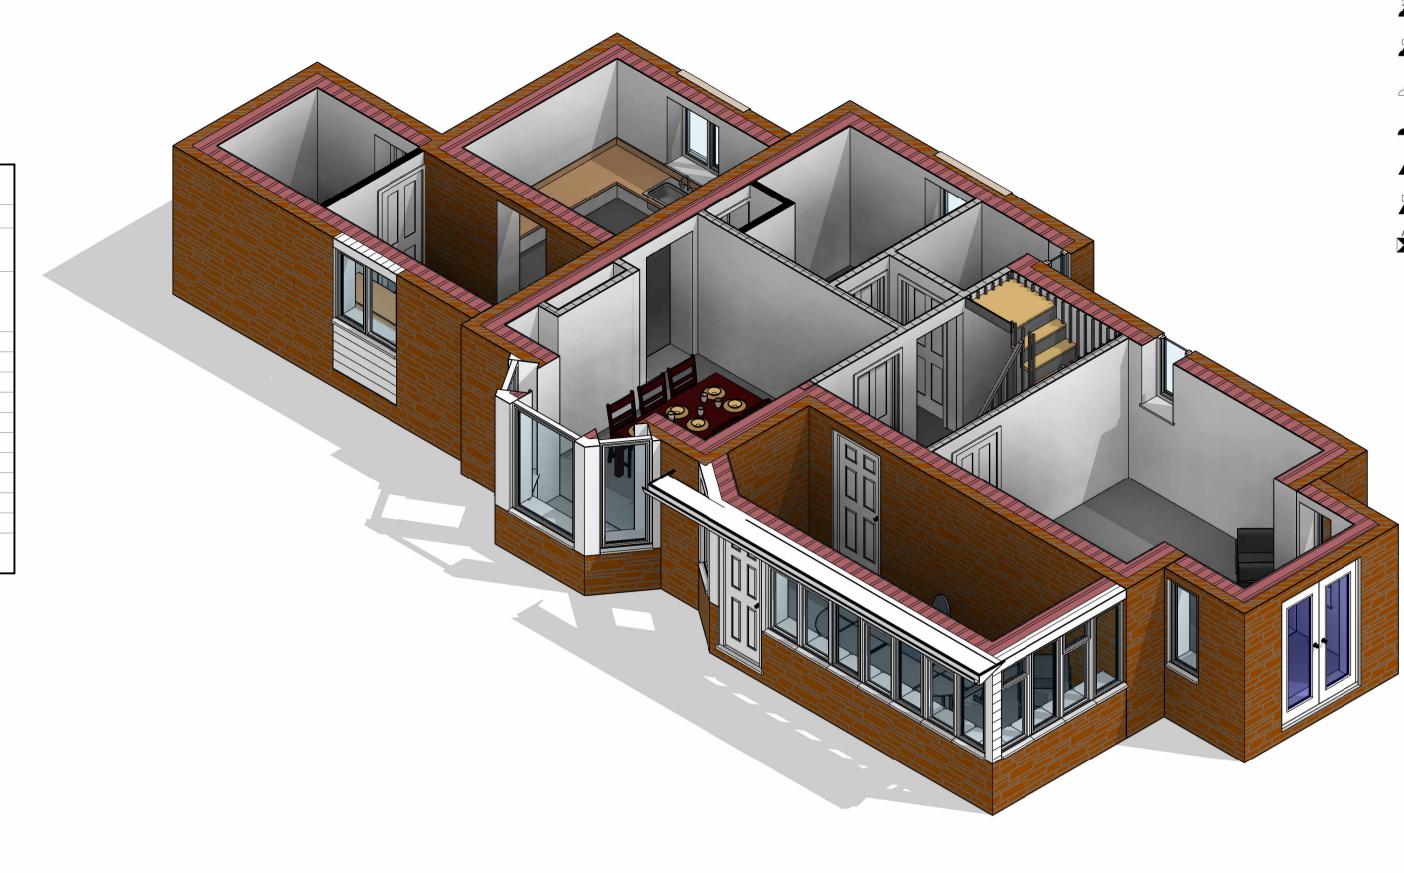

Proposed Extension - Front & DRAWING NAME Matthew Lilly **Existing Floor Plans** Rear Health and Safety Notice Client and contractor to be aware: Old School House Ash The design has elements of working at height
The design has drainage elements
The design includes demolition tasks
The design has trenching works at various depths
The design has manual handling tasks
The design requires vehicle movements and crane lifts Thomas EX16 4NT

1	Single Power Socket	FIRE	Fire Alarm Panel		Distribution Board
2	Double Power Socket	SS	Shaver Socket	SD	Smoke Detector
Ç	Cooker Point	SP	Speaker Point	(H)	Heat Detector
		0		\bigcirc	Carbon Monoxide Detector
	Unswitched Fused Spur	TV	TV Aerial Point	\otimes	Extract fan
	External Power Socket	FB	Floor Box	\bigcirc	Underfloor heating control
▲	Telephone Point	FS-2	Floor Socket		
D	Cat 6 Data Point	Ø	Passive Extract		
A	Extract Vent		Mechanical Extract		

Wall Structure Key:

	Cavity Wall: Render
	Cavity Wall: Face Brick
	Block Work: 100mm
	Studwork Wall: 75mm
<u> </u>	Metal Frame: 70mm
	Solid Brick Wall: 215mm
$\land \land \land \land \land \land \land$	Solid Block Wall: 215mm
	Structural Opening
	Walls Removed

Please note:

All drawings are for the purposes of planning only unless marked for construction.

All builders to site measure to confirm measurements.

Report all discrepancies to the person named below, do not proceed without instruction.

BRO take no responsibility should any drawing/s unless specified are used for building purposes and measurements aren't checked on site.

All drawings remain the property of BRO Architecture

<u>Drainage Key</u>

Storm Drainage
Manhole
Foul Drainage
Soil Vent Pipe
Gulley Pot
Rainwater Pipe
ACO Drain

Ducting Colour & Use

Red	Electric cable
Yellow	Gas Pipe
Blue	Water pipes
Green	Data/Comms
Grey	BT
Purple	Security - Cameras
Orange	Garden Lighting non Security



DATE 8th Apr 22 REV

DRAWN BY SH

SCALE (@ A1) 1 : 50 `

CHECKED BY Client

PROJECT NUMBER SH/BRO/080422-ML