
Reference Documents

[1] Part H (Drainage and Waste Disposal), The Building Regulations 2010

Notes

- 1. The roof has a total non-permeable surface area of 244.31 square meters. The size of the soakaway, which is likely to be circa 4-6 cubic meters based on the roof size and soil type (flint/chalk), will be determined by building control during the construction process. According to reference [1], section 3.26, soakaways serving larger areas (> 100sqm) are generally lined pits or trenchtype soakaways.
- 2. The sustainable drainage systems (SuDS) design goal is to manage stormwater locally and to mimick the natural cycle of water management by retaining water where it lands. Therefore, all paving will be permeable and fully compliant with reference [1], Section H3 (Rainwater Drainage).

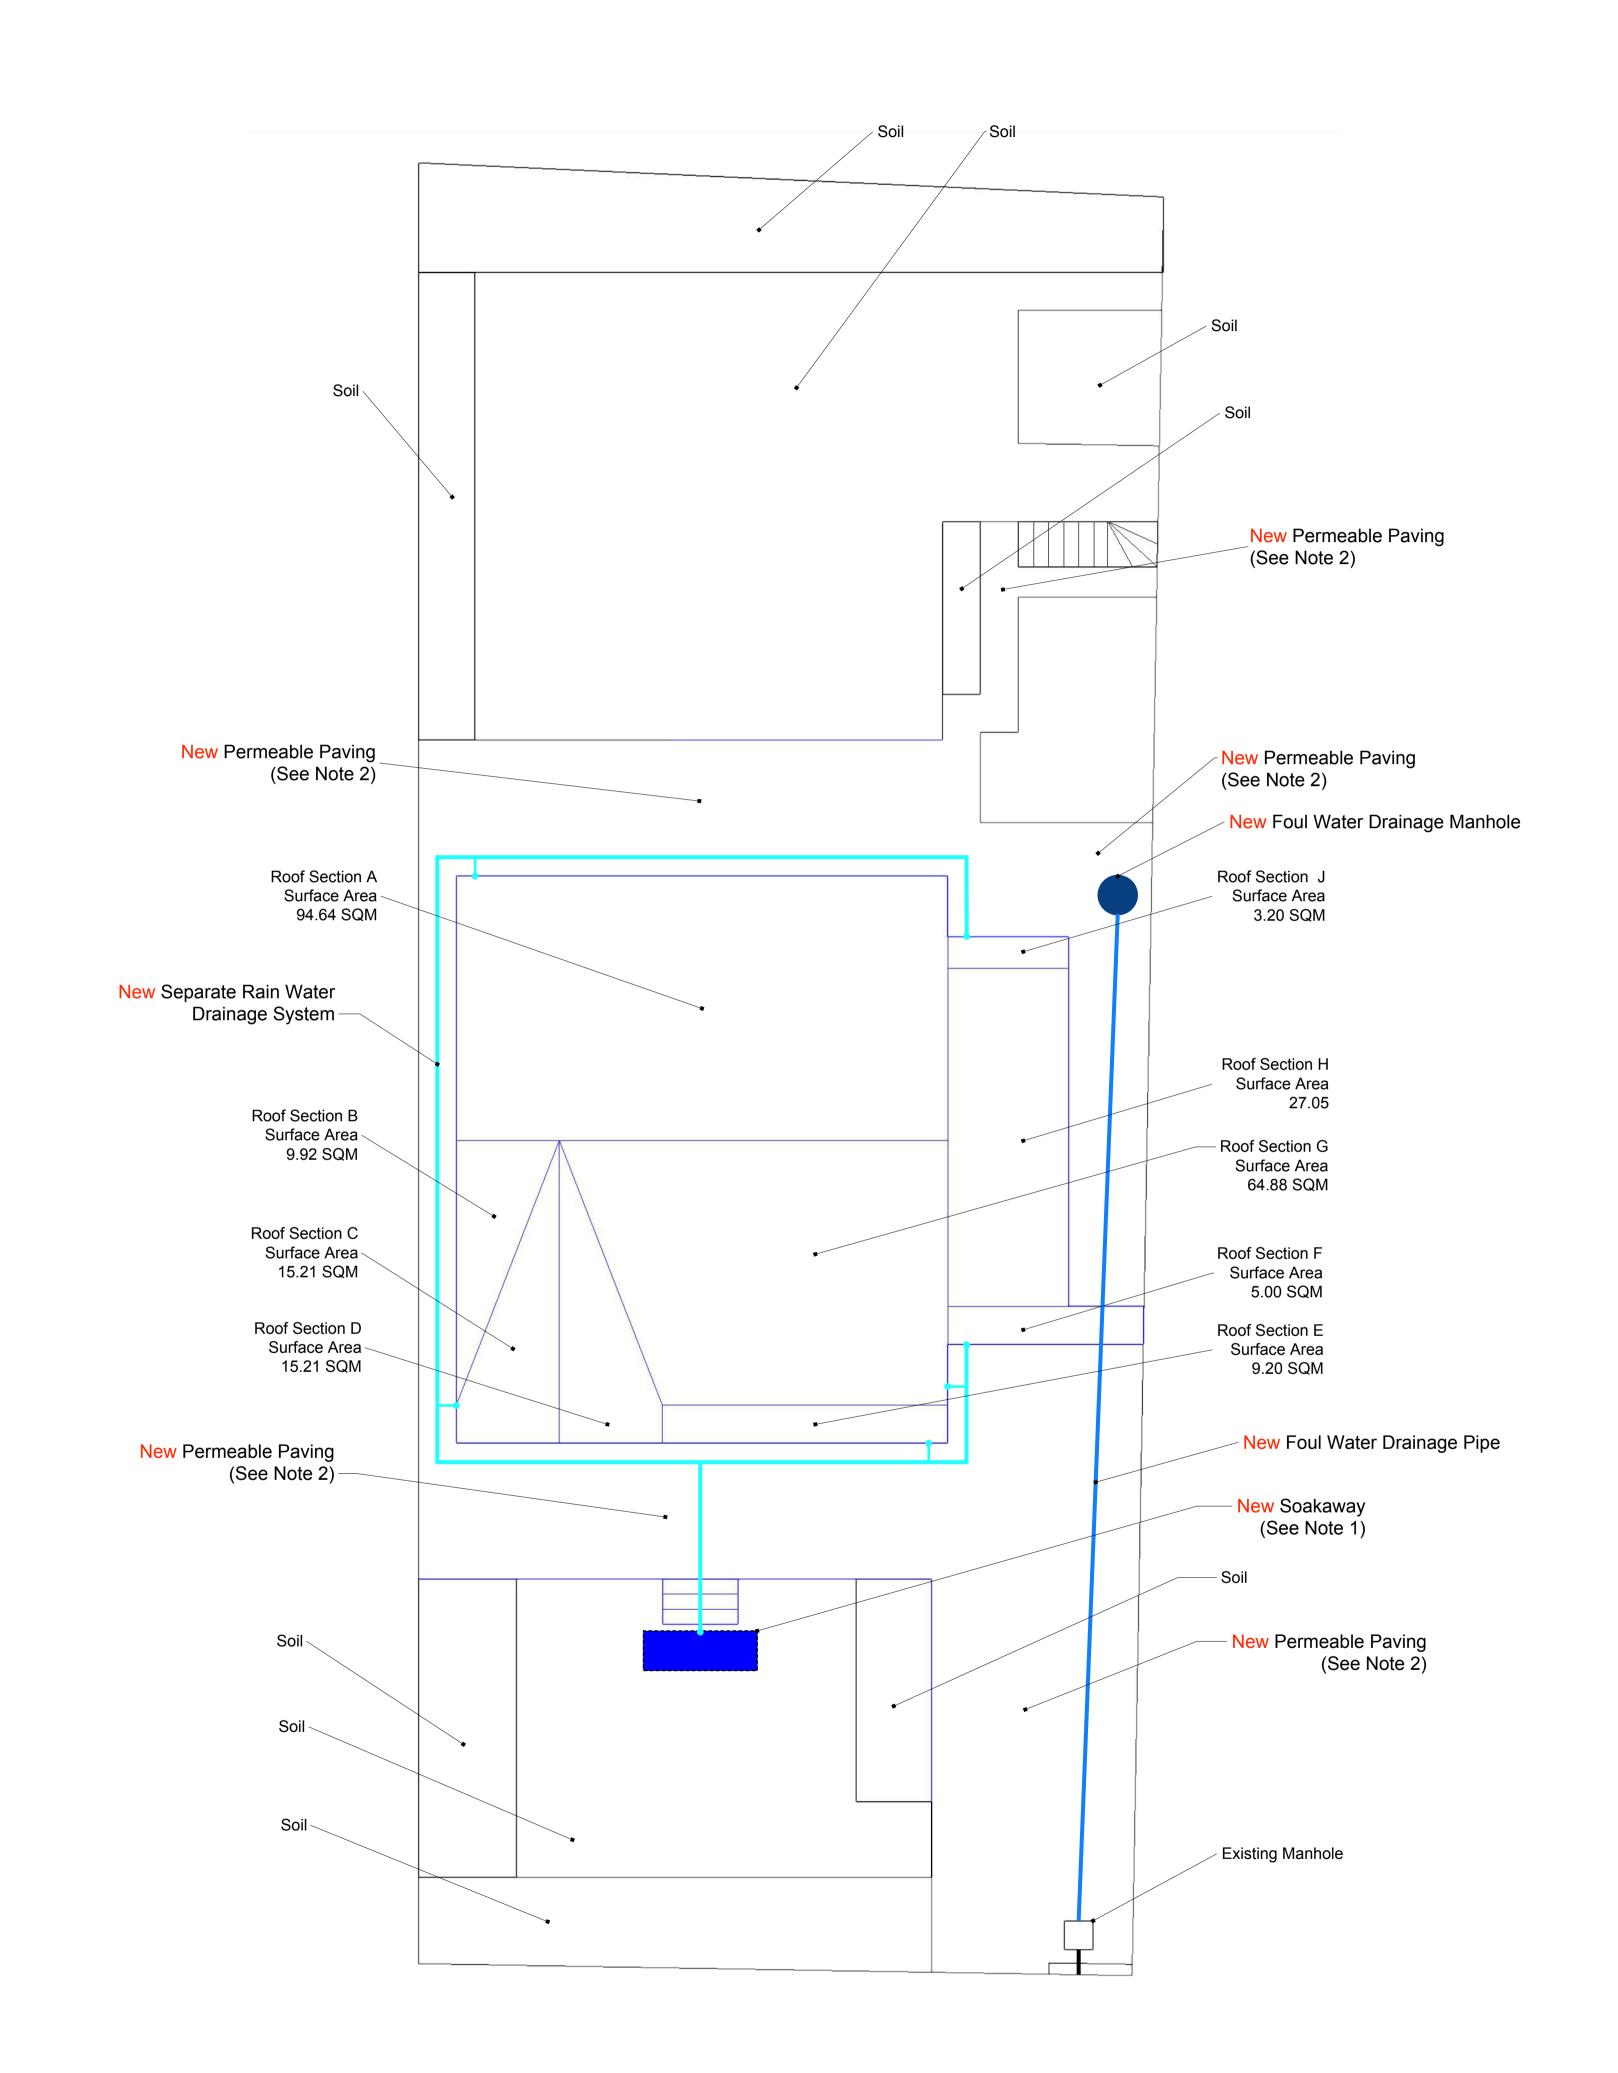

APPROVED DOCUMENT

DRAINAGE PLAN

19 Downs Ave

Scale 1:100 @ A1

Date: 15 Jun 2023

Version 1

DP-01

Drawing: 19DA-DP-01 Drawn By: Adrian Smith