
## FOR PLANNING PURPOSES ONLY

PRIOR TO COMMENCEMENT OF WORKS ON SITE AND WITH ADVANCED NOTICE, CLIENT-CONTRACTOR TO SUBMIT A BUILDING NOTICE APPLICATION TO BUILDING CONTROL. NO WORKS TO COMMENCE UNTIL APPROVALS GRANTED. FULL PARTY WALL AGREEMENT TO BE SUBMITTED BY CLIENT APPOINTED PARTY WALL SURVEYOR.

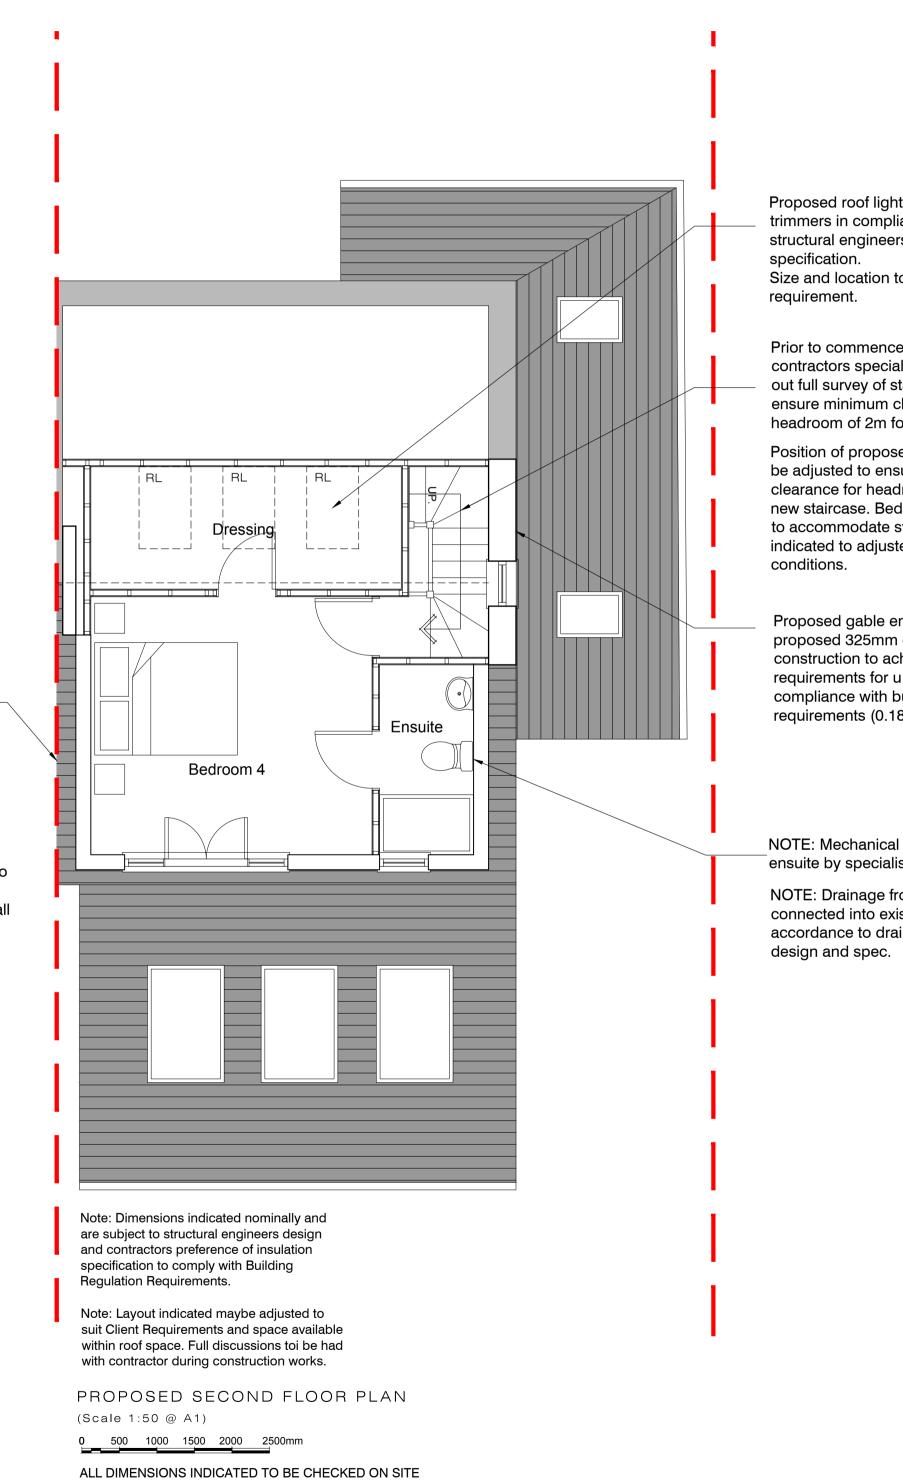

Assumed line of boundary. prior to commencement of works on \_\_\_\_ site full confirmation to be obtained from deed plans and clients solicitor.

Prior to commencement works full discussion and agreement to be made with neighbours for confirmation of intended works to be carried out. Contractor must ensure full protection is provided to boundary. Client appointed party wall surveyor to confirm if party wall notice is required to be served.

Proposed roof lights. All necessary trimmers in compliance with structural engineers design and

Size and location to suit client

Prior to commencement of works contractors specialist joiner to carry out full survey of stairwell area to ensure minimum clearance for headroom of 2m for new staircase.

Position of proposed staircase may be adjusted to ensure minimum clearance for headroom of 2m for new staircase. Bedroom 03 reduced to accommodate stairs - dimension indicated to adjusted to suit site


Proposed gable end roof with proposed 325mm cavity wall construction to achieve latest requirements for u value in compliance with building control requirements (0.18w/m2k) tbc.

NOTE: Mechanical ventilation ensuite by specialist contractor.

NOTE: Drainage from ensuite connected into existing SVP. All in accordance to drainage engineer's

Note: Heights indicated nominally and are subject to structural engineers design and contractors preference of insulation specification to comply with Building Regulation Requirements.

Note: Layout indicated maybe adjusted to suit Client Requirements. And space available with roof space.

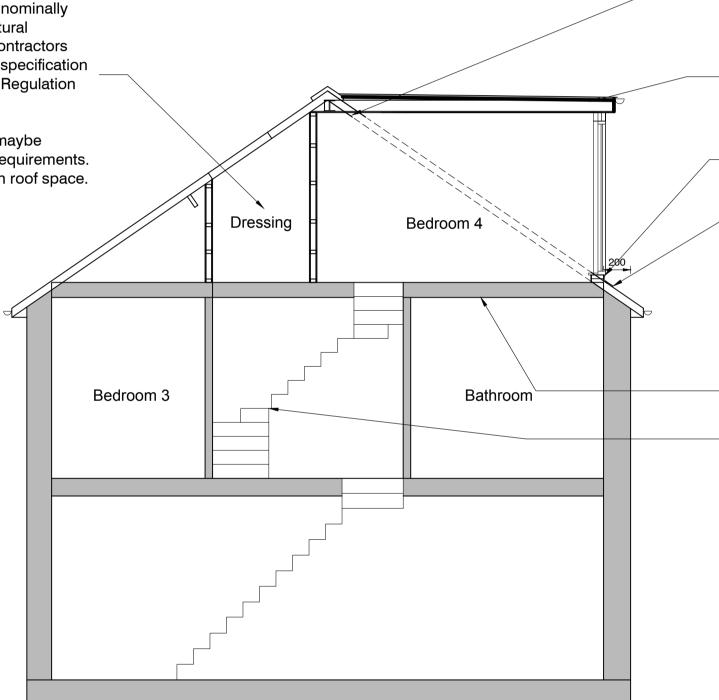

PROPOSED ILLUSTRATIVE SECTION (Scale 1:50 @ A1)

0 500 1000 1500 2000 2500mm

ALL DIMENSIONS INDICATED TO BE CHECKED ON SITE

Proposed new installed all in structural engin specification. S plaster board & 30 min fire resis

Proposed flat re single membrar specialist contr centers as per design and spe

Minimum 150m flashing upstan abutment.

Critical dimensi development to existing wall as

## Proposed floor to be designe

Prior to comme contractors spe out full survey of ensure minimu headroom of 2

Position of prop be adjusted to clearance for h new staircase. to accommoda indicated to adj conditions.

<ul> <li>PROPOSED FINISHES LEGEND</li> <li>Roof Finish - Slates.</li> <li>External Walls - render &amp; tiles.</li> <li>Fascia and soffits in white uPVC.</li> <li>External doors, windows and patio doors in white &amp; grey uPVC units.</li> <li>Gutters and Downpipes - Black uPVC gutters and downpipes with matching fixings.</li> <li>Prior to commencement works full discussion and agreement to be made with neighbors for confirmation of intended works to be carried out. Contractor must ensure full protection is provided to boundary. Client appointed party wall surveyor to confirm if party wall notice is required to be served.</li> <li>NOTE : These drawings have been prepared for planning purposes only. Full building control approval to be obtained by the client/ contractor prior to commencement of works on site.</li> <li>All dimensions indicated to be checked on site prior to any fabrication of materials. note all dimensions indicated taken with standard tape measure for planning purposes. Full electronic station survey to be taken for complete accuracy.</li> </ul>	
<ul> <li>r steel beams to be compliance with heers design and steel enclosed with a skim to achieve min stance.</li> <li>roof with sika sarnafil ane roofing felt by ractor. Joist sizes and structural engineers ecification.</li> <li>nm code 4 lead and maintained at roof</li> <li>sion for LPA permitted o be 200mm from line of a per latest Ipa policy.</li> <li>r joists and steel support d by structural engineer.</li> <li>encement of works received area to um clearance for 2m for new staircase.</li> <li>uposed staircase may ensure minimum headroom of 2m for Bedroom of 3 reduced ate stairs - dimension djusted to suit site</li> </ul>	<ul> <li>THE DRAWINGS RELATE TO THE PROPOSED EXTENSION WORKS AT 90 HEOL GABRIEL, WHITCHURCH, CARDIFF CF14 1JW.</li> <li>FOR STRUCTURAL DETAILS PLEASE REFER TO CLIENT APPOINTED STRUCTURAL ENGINEERS DESIGN AND FULL SPECIFICATION.</li> <li>THE DRAWING HAS BEEN PRODUCED FOR PLANNING PURPOSES ONLY.</li> <li>CONTRACTOR MUST ENSURE A FULL BUILDING CONTROL APPLICATION IS SUBMITTED PRIOR TO COMMENCEMENT OF ANY WORKS ON SITE.</li> <li>ALL DEMOLITION WORKS SUBJECT TO STRUCTURAL ENGINEERS APPROVAL AND FULL DESIGN AND SPECIFICATION.</li> <li>ALL PLANNING CONDITIONS TO BE APPROVED PRIOR TO COMMENCEMENT OF RELATED WORKS.</li> <li>DRAINAGE DETAILS ARE INDICATIVE ONLY. CLIENT APPOINTED SPECIALIST TO PROVIDE DESIGN AND TO BE APPROVED BY BUILDING CONTROL AND WELSH WATER - PRIOR TO INSTALLATION.</li> <li>CONTRACTOR TO CHECK ALL DIMENSIONS ON SITE, BEFORE COMMENCEMENT OF ANY WORKS, ANY ANOMALIES MUST BE REPORTED. DO NOT SCALE FROM DRAWINGS.</li> </ul>
	Rev A NH SF October 2023         Red line to OS map adjusted.         Irre         DRAWING STATUS:         PLANNING         CLIENT:         MR NICK TATHAM         PROJECT:         90 HEOL GABRIEL, WHITCHURCH         CARDIFF CF14 1JW         SECOND FLOOR PLAN & SECTION         AR C H L C C C C C         DRAWING TITLE:         SECOND FLOOR PLAN & SECTION         AS PROPOSED         JOB NUMBER:       BY:         (23) 201       RV         SEARCE       SEPT 2023         DRAWING NUMBER:       RV:         (23) 201       RV         SCALE:         (23) 201       RV