


1. If you do not fully understand the risks involved during the construction of the items indicated on this drawing ask your manager, health & safety advisor or a member of the design team before proceeding.
2. Scaffold protection to be provided during roof works with internal fall protection.
3. Any manual handling risks to be identified and design team notified in advance of commencement of works.
4. The contractor should be aware that there may be buried or covered services such as electric, gas or BT not identified on drawings.
5. The contractor should be aware of the general condition and stability of building fabric- particularly during demolition and alteration work.
6. When working with lime products which are corrosive to skin and eyes, suitable protection is required.

THIS INFORMATION MUST BE CHECKED ON SITE AND ANY RISKS IDENTIFIED BY OTHER PARTIES REPORTED TO THE PRINCIPAL DESIGNER.

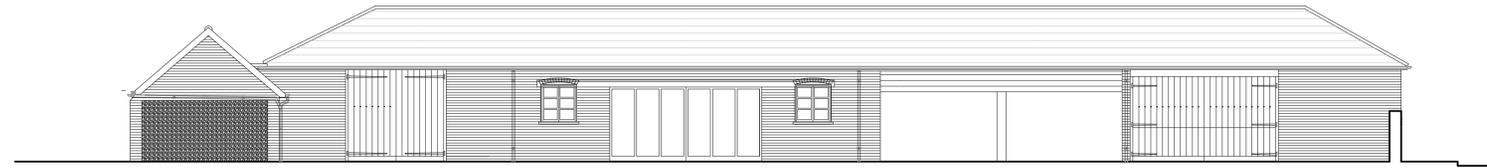

Existing West Elevation - scale 1:100



Existing South Elevation - scale 1:100




A - Internal view looking north showing brick and flint dividing wall



B - Internal view looking north showing brick and flint dividing wall; note tie beam



C - Internal view looking north showing composite brick external wall with area of random headers

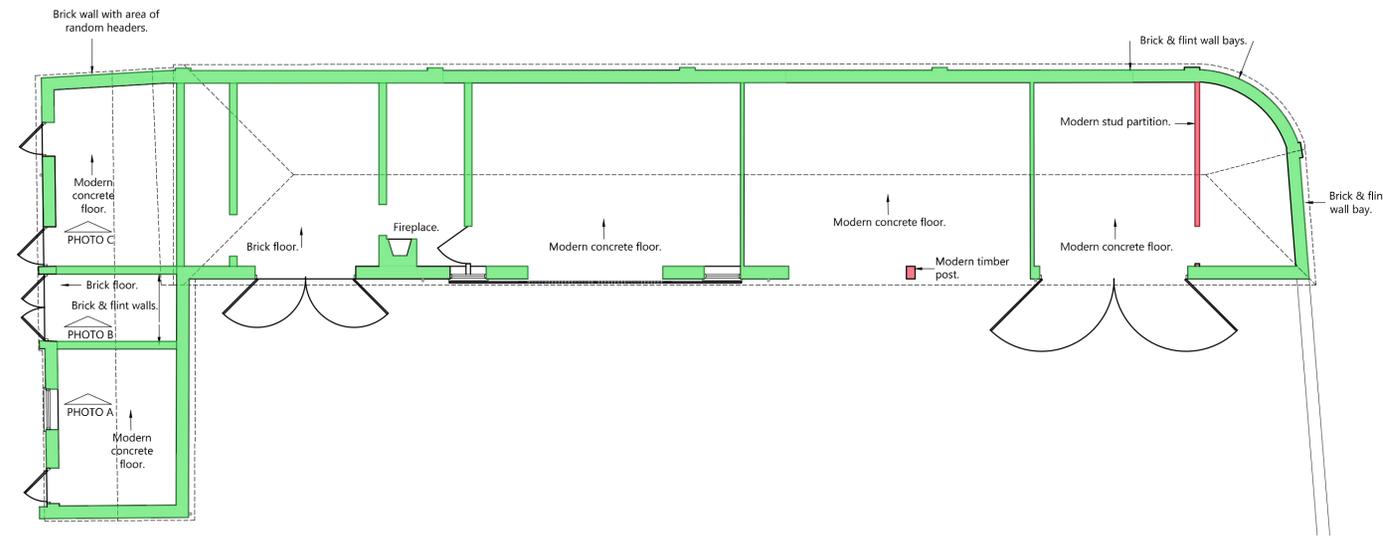

Existing Ground Floor Plan - scale 1:100

Morphology / Opening Up Works Key



Note: conjectural morphology based on professional judgement/site investigation & limited opening up works and historic record drawings  
 Plastered brick (dashed rectangle)  
 Areas of opening up shown by dashed rectangle and materials description

PL2	14.04.23	Morphology / Opening up information added	SJ	SS
PL1	15.09.22	PLANNING	SJ	SS

Rev.	Date	Details	Drawn	Checked


**Nicholas Jacob Architects**  
 Architecture • Conservation • Interiors  
 The Old Rectory, 5 Wherry Quay, Ipswich, IP4 1AS  
 01473 221153

**PLANNING**

Client/Project:  
 Cardinal Loft (Mill) Ltd  
 1-4 Church Close, Church Lane, Sproughton IP8 3BE

Drawing title:  
 Existing Outbuilding Plans and Elevations & Morphology

Project number:	Drawing number:	Revision:
21106	102	PL2
Scale:	Drawn By:	Checked By:
1:100	@A1 SJ	
		Date:
		March 2022

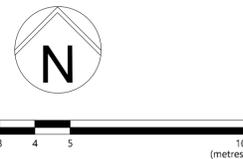

Crop marks are visible when the full extent of this drawing is plotted. Reference dimensions: 820mm from the crop mark to right of the block & 570mm between crop marks vertically