



All materials used in the proposed will match existing materials


Roof lights will not protrude more than 150mm above the roof line.

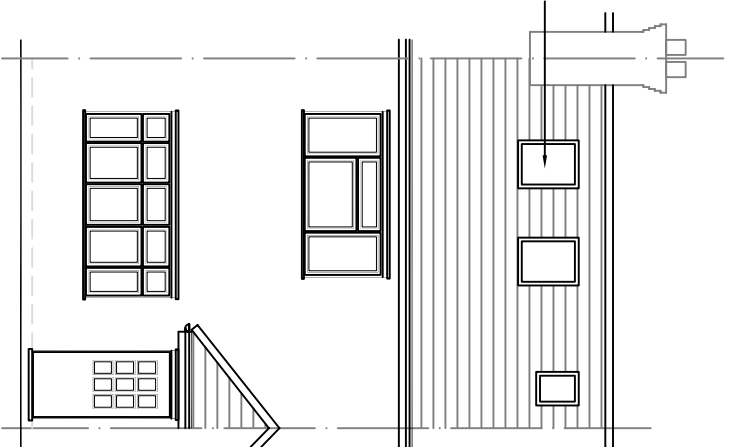


Front Elevation

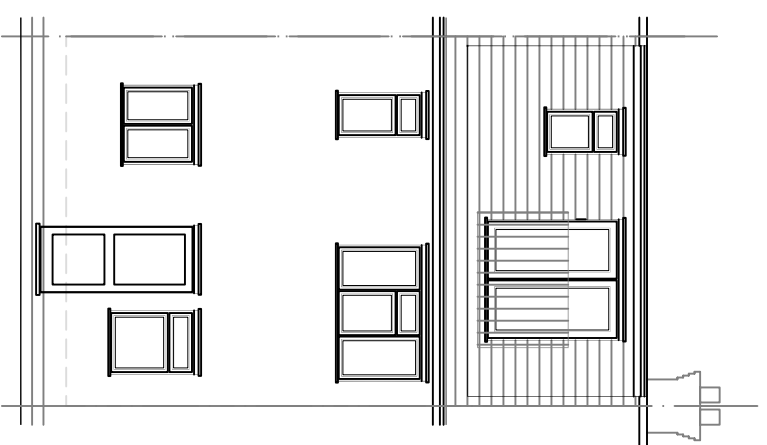


Rear Elevation

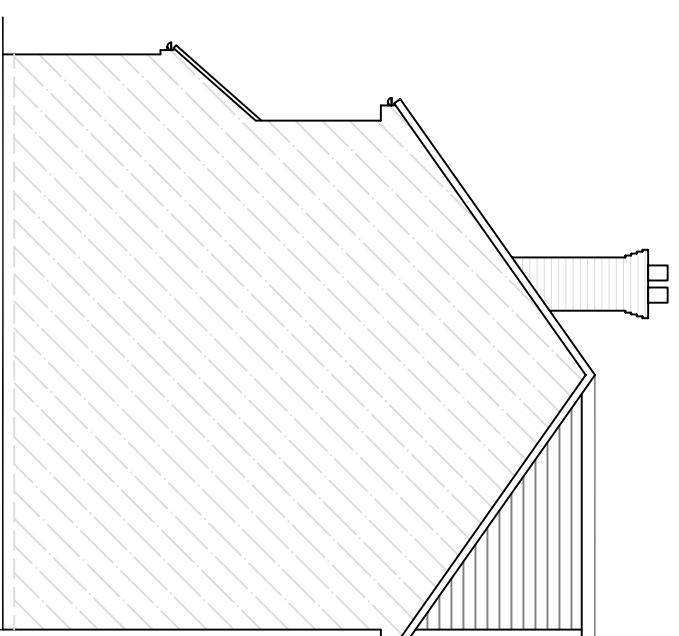

Side Elevation RHS

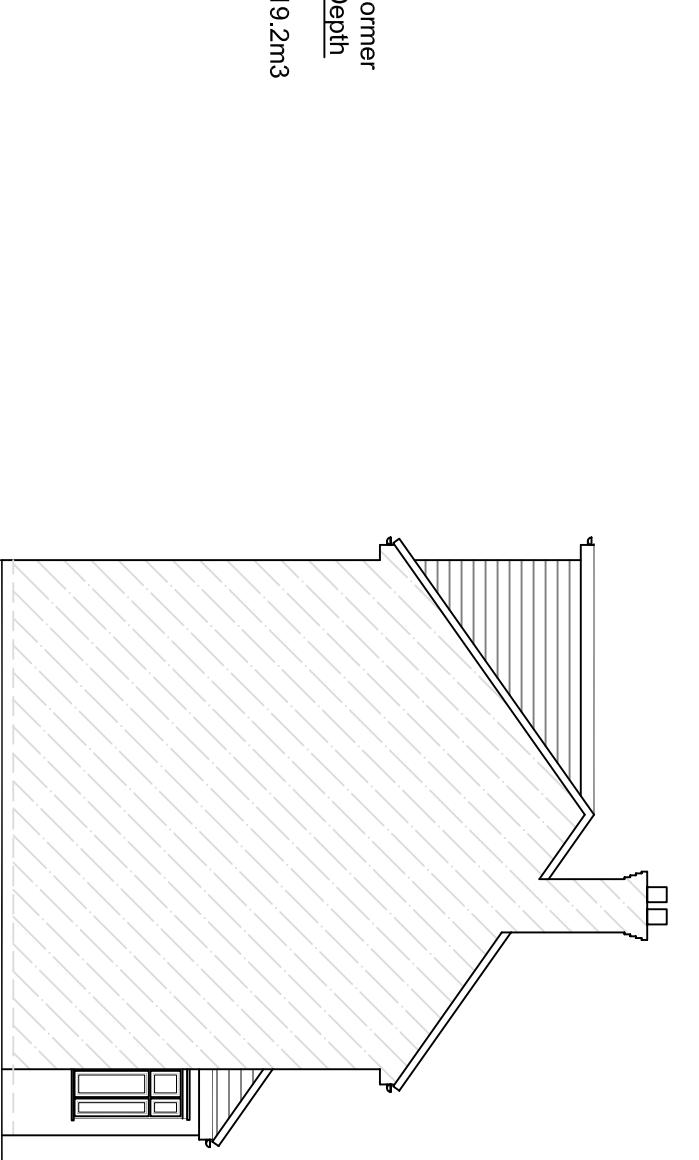

Side Elevation LHS

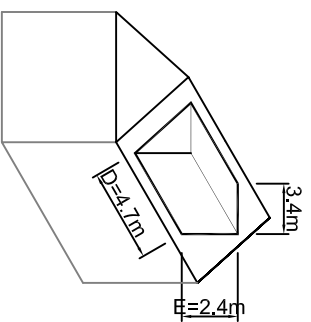

Volume of Rear Dormer
Height x Width x Depth
 $\frac{4.7 \times 2.4 \times 3.4}{2} = 19.2\text{m}^3$

- KEY:**
- HD - Heat Detector
 - SD - Smoke Detector
 - Half Hour Fire Door
 - Extractor Fan

These drawings should be approved by local Authority
No dimensions to be scaled from this drawing. All dimensions to be checked on site. This drawing is copyright and should not be reproduced without permission of the Architects.

client: **Ms. Dilini Srikantha**

project: **22 Berkeley Avenue
Greenford
UB6 0NX**

drawings:

Proposed Elevations

scale: 1:100 date: Oct 2023 drawn:

03 / 04

Scale 1 to 100

