



PROPOSED HIP TO GABLE VOLUME:
PROPOSED REAR/FRONT SECTION OF HIP TO GABLE VOLUME:
 (K) 4255 X (I) 3987 X (J) 2931 = 49.72/6 = 8.29M3 X 2 = 16.58M3
PROPOSED MIDDLE SECTION OF HIP TO GABLE VOLUME:
 (H) 1547 X (I) 3987 X (J) 2931 = 18.08/2 = 9.04M3
 16.58 + 9.04 = 25.62M3

PROPOSED MAIN DORMER VOLUME:
 (A) 3869 X (B) 2289 X (C) 1548 = 13.71/2 = 6.86M3

PROPOSED SIDE DORMER VOLUME:
 (D) 2278 X (E) 2088 X (F) 1423 = 6.77/2 = 3.39M3
 (D) 2278 X (E) 2088 X (G) 1294 = 6.15M3
 (D) 2278 X AREA OF SHAPE (O) = 7.13M3
 (D) 2278 X 3.13M2 = 7.13M3
 3.39M3 + 6.15M3 + 7.13M3 = 16.67M3
TOTAL NEW VOLUME
 25.62M3 + 6.86M3 + 16.67M3 = 49.15M3
WITHIN THE 50M3 ALLOWANCE

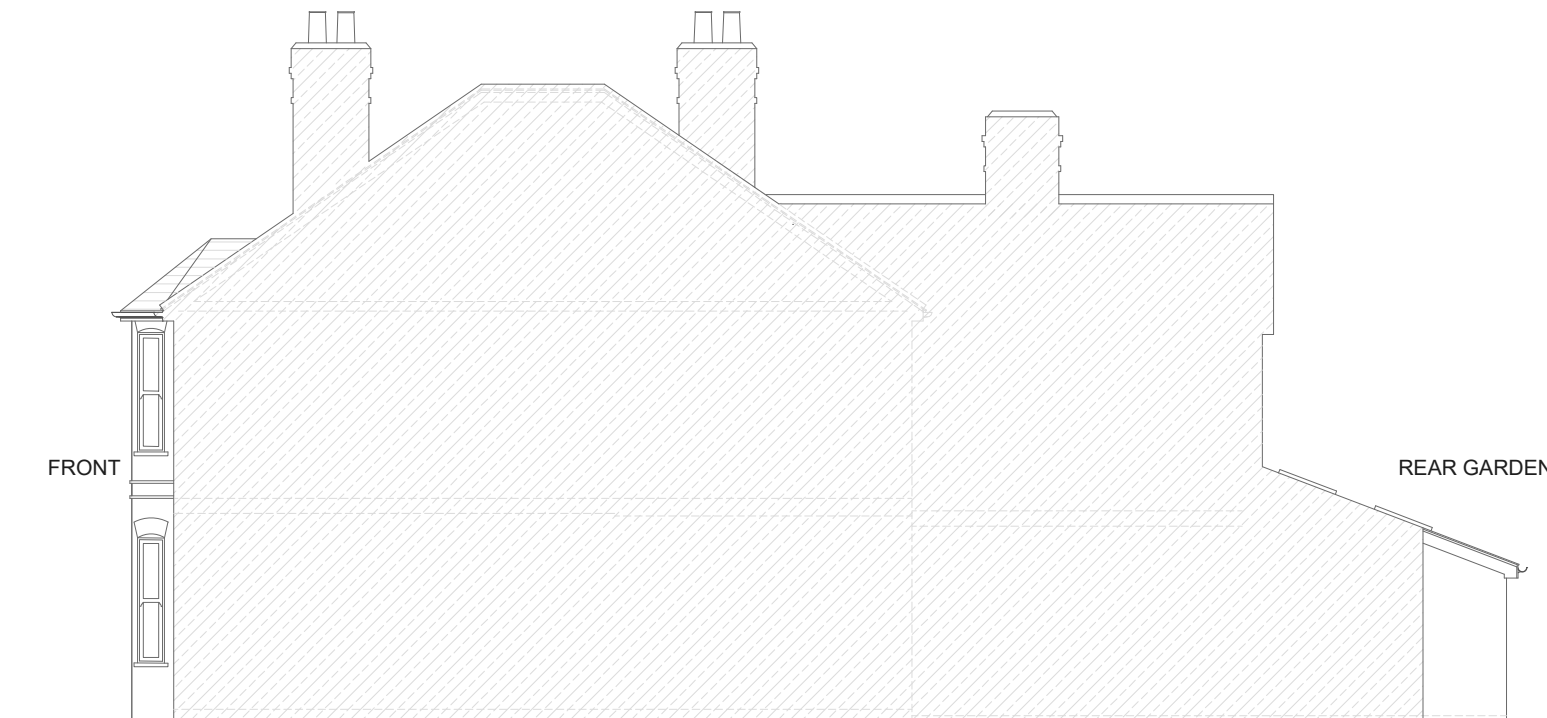

EXISTING NORTH ELEVATION
SCALE 1:100

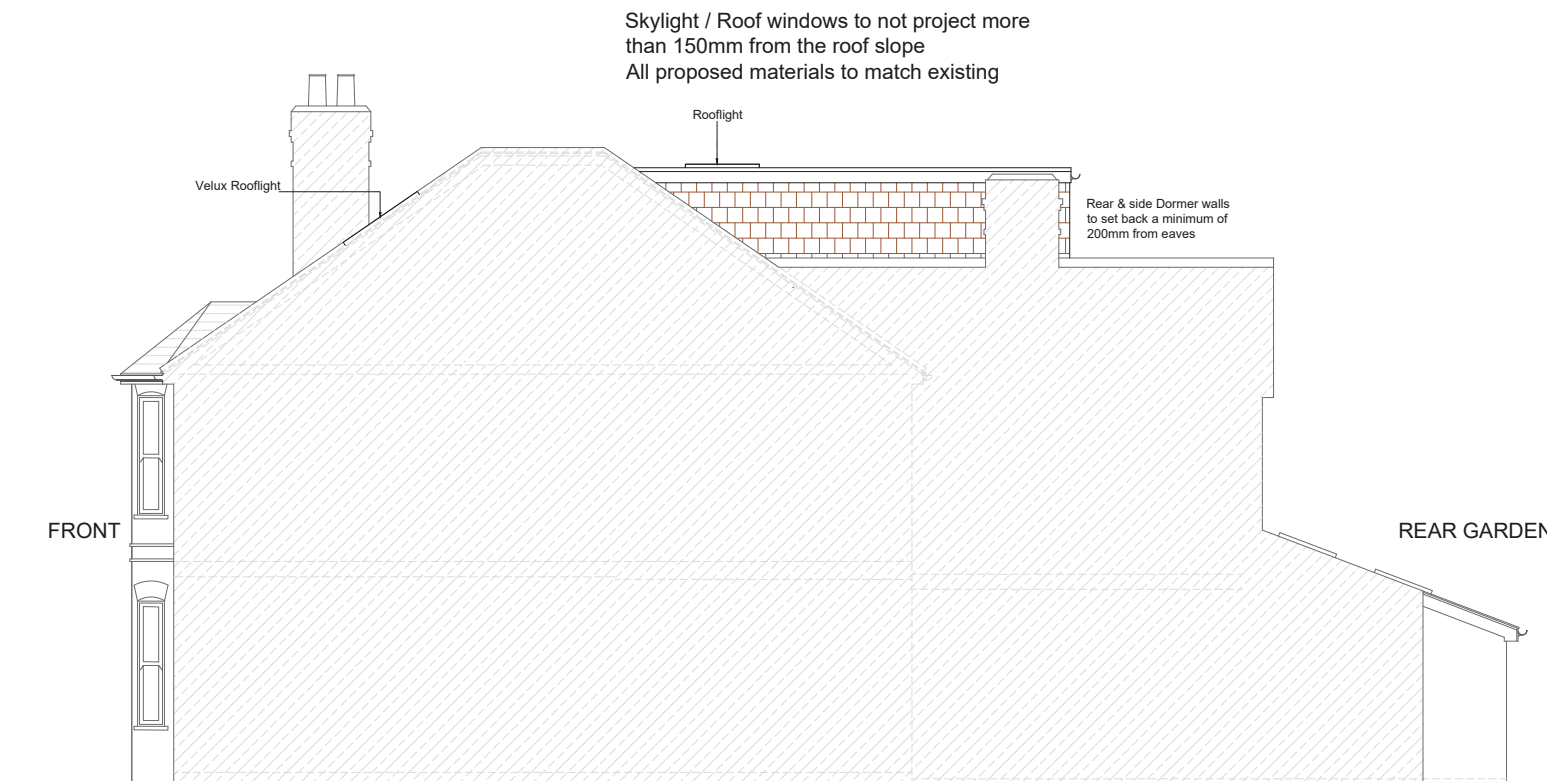

PROPOSED NORTH ELEVATION
SCALE 1:100

NOTES

REV	DATE	NOTES

CLIENT
Mr. & Mrs. BREND

PROJECT
35 FOXENDEN ROAD, GUILDFORD, GU1 4DL

DRAWING TITLE
EXISTING AND PROPOSED SIDE ELEVATIONS

SCALE
1:100@A3

DATE
24.10.23

DRAWN
SM

DRAWING NO.
PP-11

REV.



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