Heating Legend:

Indicates compact radiator position with TVR controls. Sizes are shown indicative only & are subject to heating specialist's design & heat loss calculations.

Indicates Heated Towel Rail.

Appliance Legend:

Built-in washing machine.

Built-in fridge freezer

4 zone electric hob.

Built-in dishwasher. DW

Built-in tumble dryer.

Built in double oven.

Tall larder unit.

General Electrical Notes:

- Any service control needed to be operated or read on a frequent basis, or in an emergency, should be included within the height band of 450-1200mm from finished floor level. please refer to Approved Document M4(2) of the building
- Refer to Aviary developments specification for details of all physical fittings.
- Switches for permanently wired appliances are located between 450mm and 1200mm above the floor, unless needed
- at a higher level for particular appliances. • The consumer control unit is to be mounted so that the switches
- are between 1350mm & 1450mm above FFL. • Switches, sockets, stopcocks and controls are to have their centre line between 450mm & 1200mm above FFL and a minimum of 300mm (measured horizontally) from an inside
- Boiler timer controls & thermostats are to be mounted between
- 900mm & 1200mm above finished floor level. Installation is to be carried out in accordance with the current IEE Regulations, the electricity supply regulations, and CIBSE
- guides and to the approval of the electricity board. • Please refer to the construction specification for further details.
- All lighting to be low energy.
- Ventilation shown indicative only. Refer to specialists design.
- This drawing is to be read in conjunction with the Aviary developments Finishes Specification.

Electrical Legend:

- Light switch (to be in multiples)
- Two/Three way light
- Door bell sounder

switch

- Door bell
- Hager Design 30 Lockable consumer unit mounted so that the controls are between 1350-1450mm from FFL
- Power supply for kitchen cooker hood extract
- (((1))) Heat detector
- Switched fused spur
- Mains powered smoke detector (optical only) with battery back up
- Triple pole switch
- BT socket
- Low level TV outlet.
- Low level TV outlet with 1no. RJ54 port.
- Double switched socket at low level
- Low energy pendant
- (CD))LED tube light fitting
- Thermostat
- Wall mounted external light fitting to have seperate PIR sensor
- EM electricity recessed meter Comprises of Optical
- network termination unit, HUB 1no. Double socket, 4no. RJ54 port.
- **△** Cooker outlet

multi-gang where shown

Kitchen control panel to comprise of 20a grid switches for integrated appliances and switch for

positioned above work

Double switched socket

- IP67 low voltage warm

extract fan override

- white led down lights Indicative route of electric
- cablina
- 45amp double pole switch for ovens
- dMEV ceiling mounted utility extract fan with minimum high rate if 30L/s
- dMEV ceiling mounted ₩/C extract fan with
- minimum high rate of 6L/s dMEV ceiling mounted bathroom extract fan with


15L/s

Cooker hood extract fan with minimum high rate if

minimum high rate of

- Indicates white shaver socket.
- Indicates indicative location of Union Bib Tap
- Indicates external TPCP mounted bux 10 treatment plant control panel to be fed from CCU
- Important Note:

electrical items shown upon this drawing are for indication & pricing purposes only and are to be verified by a competent & suitably qualified electrical contractor. All BT points (Voice & Data) to be wired back to master BT point situated at the HUB.

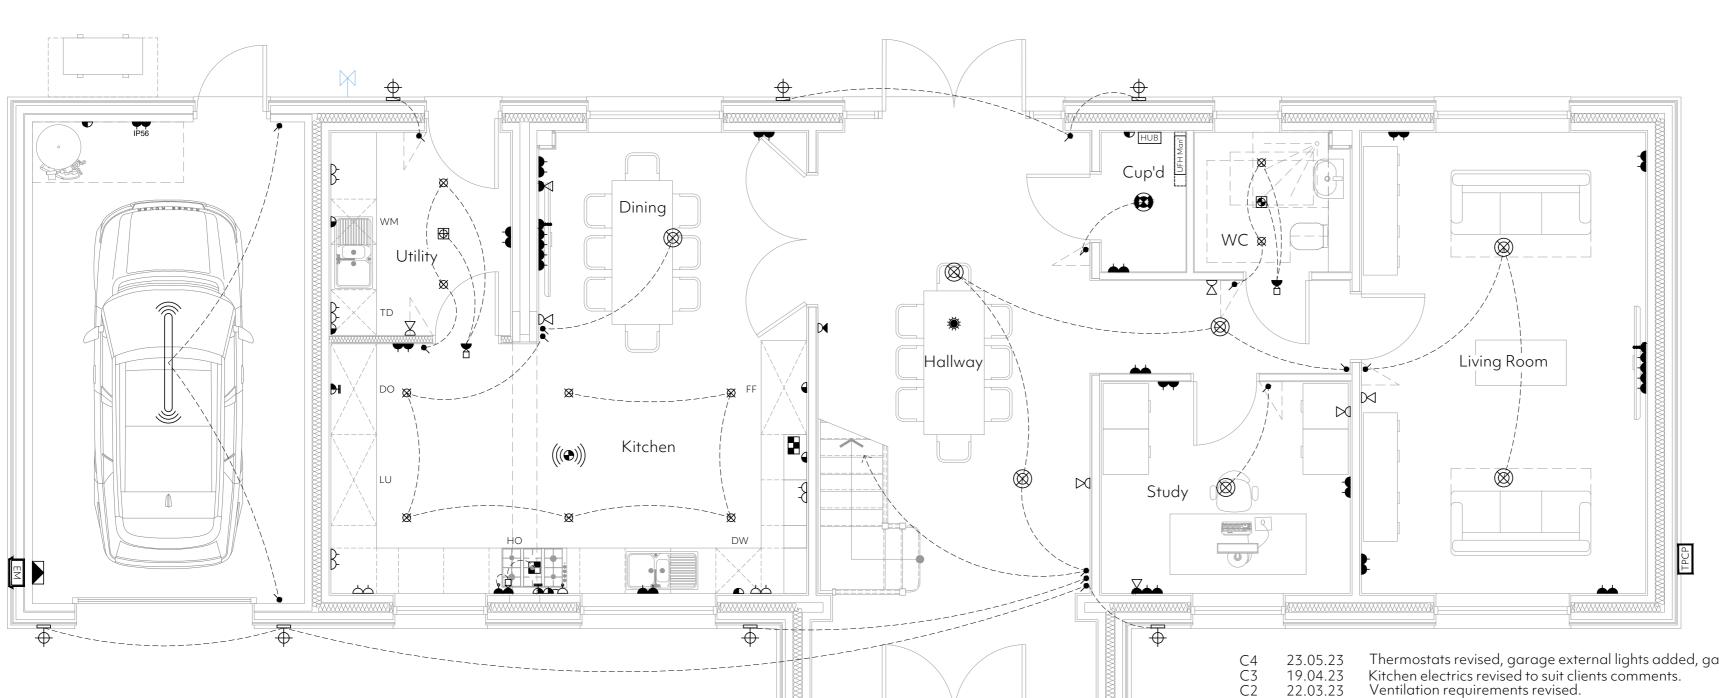

Thermostats revised, garage external lights added, garage internal light revised.

C1 27.07.22 Construction Issue. P1 01.07.22 Preliminary Issue.

Rev Date Amendment

Aviary Developments Client: Priors Hall Farm, Linsell Project: **Drawing:** Ground Floor Electrical Layout hello@projectarch.co.uk +44 (0) 1371 829095 Plot 02 **Status:** Construction Issue **C4 Dwg No:** 21-1032-129 Date: March 2022 **Scale:** 1:50 @ A2

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Ground Floor Electrical Plan

Plot 02

Scale 1:50