


DRAWN BY	PR	
SCALE	1:50 & 1:100	
DATE	Nov 2023	
DWG No.	AL95	

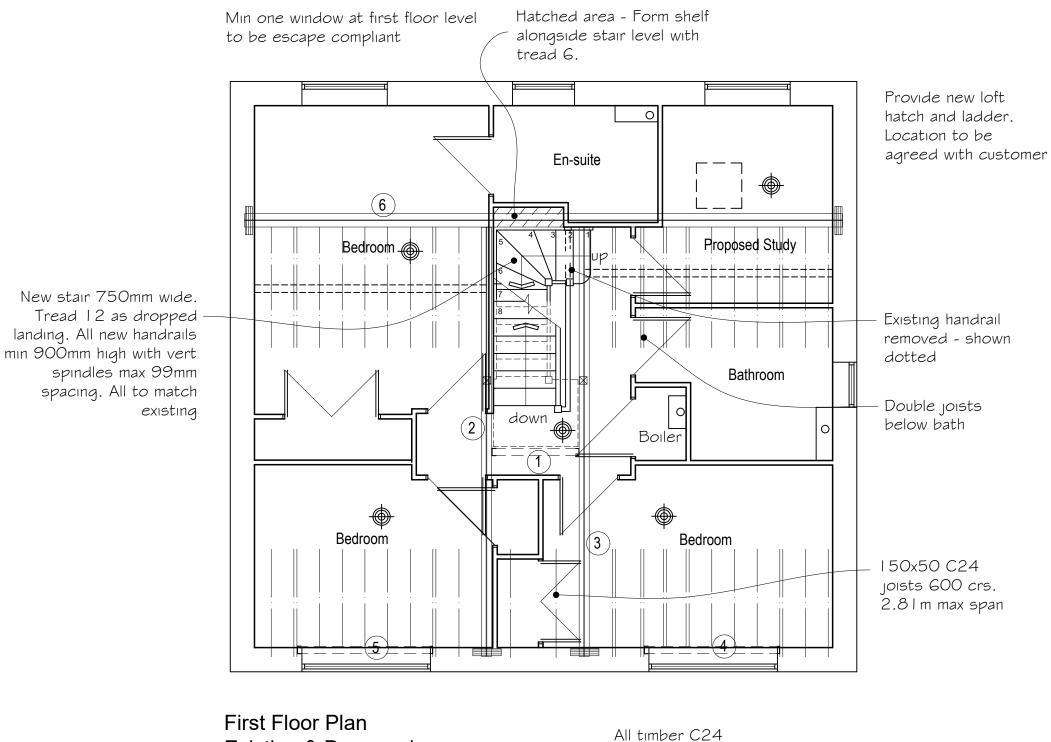


Existing & Proposed (loft structure above)


Beam sizes to be

added

Scale	1:50	at A3
0	1m 	2m

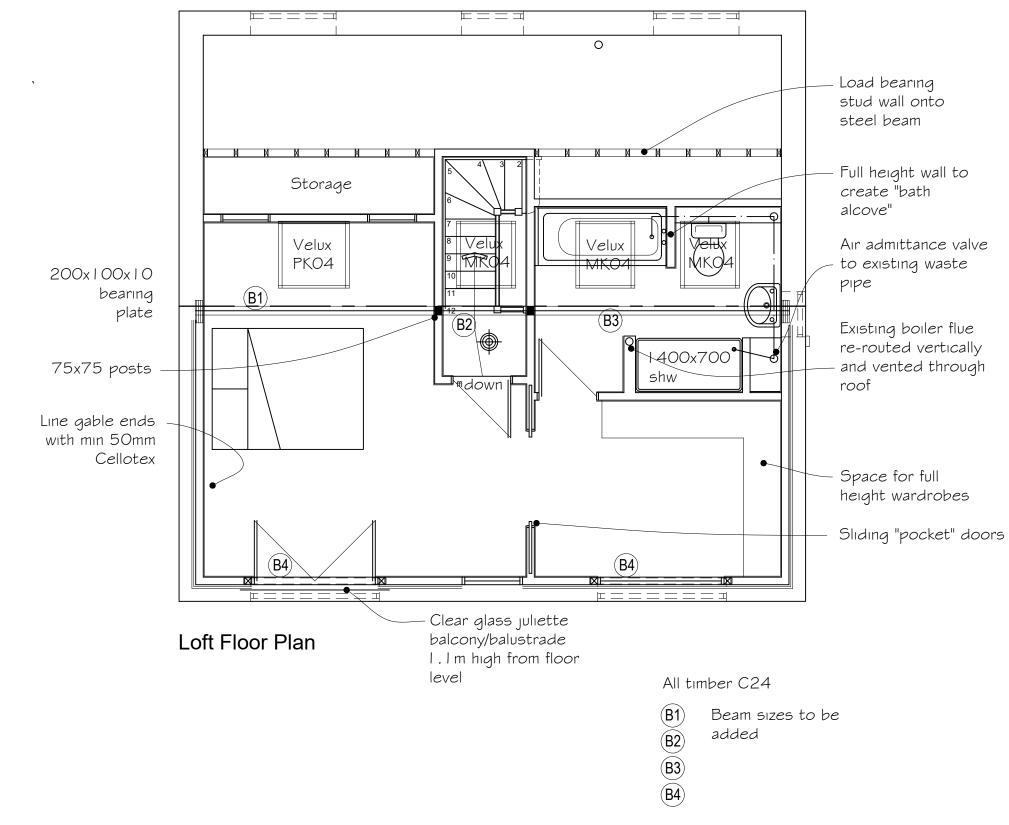

Scale	1:50	at A3
ò	1m	2m

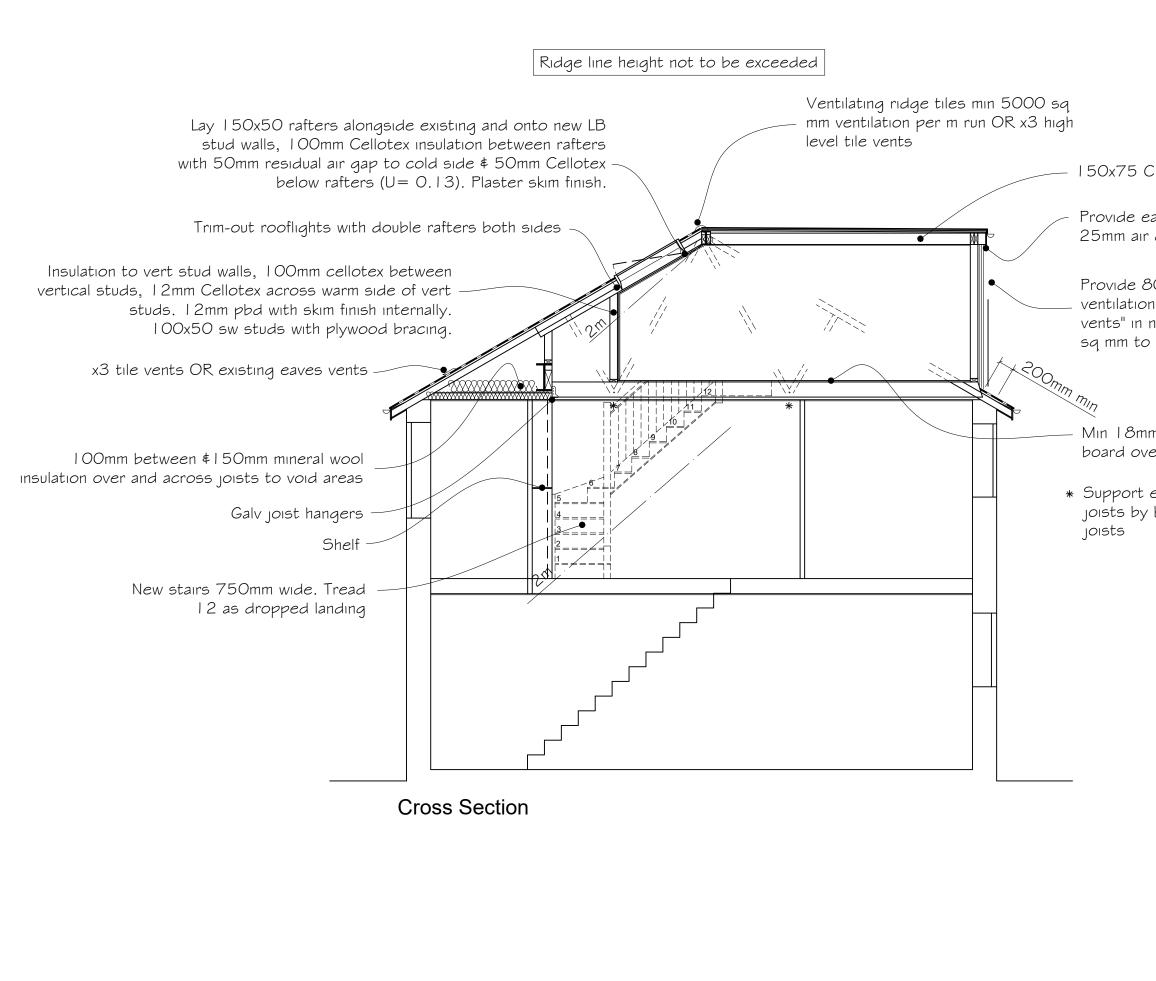

150x75 C24 joists at 400 crs

Provide eaves vents \$ mesh equal to 25mm air gap continuous


Provide 8000 sq mm permanent ventilation to new rooms with "trickle vents" in new window frames (4,000 sq mm to bathroom).

Min 18mm t\$g Weyrock board over new floor joists

* Support existing ceiling joists by bolting to new

0


Scale 1:50 at A3					
1	m I	2m 	3m		

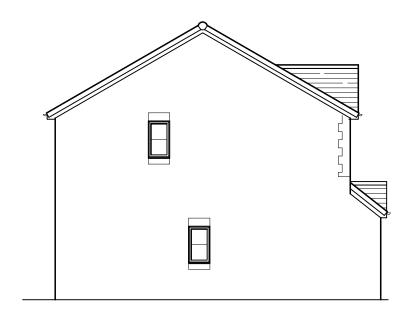



Side Elevation - Existing


Front Elevation -Existing

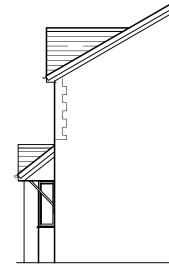


Side Elevation - Existing



Rear Elevation - Existing

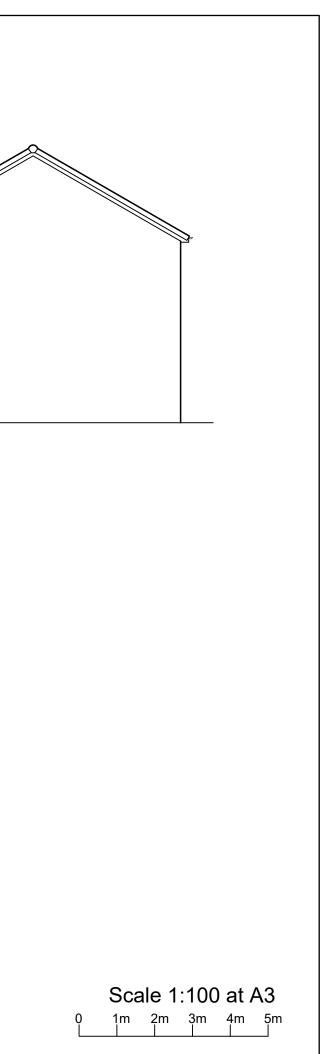

Side Elevation -Proposed

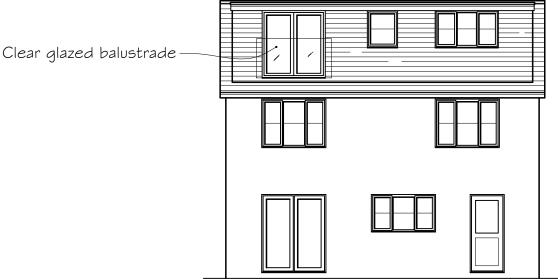


Rear Elevation -Proposed

Proposed dormer to be clad in hanging tiles to match existing roof in colour and texture. All fascia and rwg in upvc to match existing. White upvc dg windows.

Proposed dormer volume = $4 \mid cu m$

Proposed dormer to be set back min 200mm from eaves

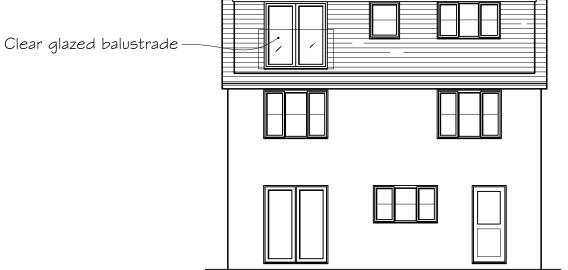

Front Elevation -

Proposed

Flush fitting rooflights (to protrude no greater than 150mm from roof plane)

