Martinique - New build

Proposed replacement of redundant	CONTENTS		6.0 MATERIA
storage buildings with 3no new build	1.0 INTROE	DUCTION	6.1 Pro
dwellings at:	1.1 1.2 1.3 1.4	Credits & Drawing Schedule Site Location Site Description Key Site Views	7.0 ACCESS
Martinique Farm, East Martin,	2.0 SITE CO		7.1 Ov 7.2 Ref 7.3 Fire
Fordingbridge, SP6 3JS	2.0 SHE CC	Site Analysis	7.4 Lar
	3.0 DEVEL	OPMENT	
Client: Mr Shering Planning Application	3.1	Planning Statement and History	
November 2023	4.0 PROPC		
0249-02-003	4.12	Plot 2 Floor plans Plot 3 Floor plans	
	4.14	Plot 1 Elevations Plot 2 elevations Plot 3 elevations	
	5.0 PRECE 5.1	DENTS Examples	

IALS

roposed

SS Overview & Accessibility Refuse ire .andscape

1.0 Introduction

1.1 Credits and drawing schedule

This Design & Access Statement is to be read in conjunction with:

All plans and elevations prepared by Birch Architects.

This document is intended to be a positive and helpful tool for the New Forest Council and invested third parties and demonstrates how the design proposals have evolved, having regard to site opportunities and constraints. The proposal has taken into account national, regional and local planning guidance additionally we carried out a pre-app with New Forest in 2021, and achieved a planning approval for the conversion of the barns in 2022.

An application for replacing the barns with New build was made in 2023 - the roof height and eaves were amended and a carport was added to plot 1. This was refused in October 2023. The case officer advised that a new build application that matched the existing approval could be supported.

This Design & Access statement has been prepared by Birch Architects on the behalf of Mr Shering to accompany a planning application for the replacement of three redundant agricultural buildings with three new build dwellings that match the existing approval. This document is intended to promote the development of a high quality residential scheme at Martinique. The document will highlight the design considerations of the surrounding site and context.

Schedule:

The following drawings are included with the document: 0249-02-01-001 - Location plan @1:1250/1:500 0249-02-01-002 - Topo @1:500 0249-02-91-001 - Existing Plot 1 floor plans @1:100 0249-02-91-002 - Existing Plot 3 floor plans @1:100 0249-02-91-003 - Existing Plot 3 floor plans @1:100 0249-02-91-004 - Existing site elevations @1:200 0249-02-02-001 - Proposed site plan @ 1:500 0249-02-03-001 - Proposed Plot 1 floor plans @1:100 0249-02-03-002 - Proposed Plot 2 floor plans @1:100 0249-02-03-003 - Proposed Plot 3 floor plans @1:100 0249-02-03-004 - Proposed Plot 3 floor plans @1:100 0249-02-03-004 - Proposed Plot 3 floor plans @1:100 0249-02-05-001 - Proposed Plot 1 elevations @1:100 0249-02-05-001 - Proposed Plot 3 floor plans @1:100

Design Team:

Architects: Birch architects - info@bircharchitects.co.uk

Planning Consultant - RAW planning - kerry@rawplanning.co.uk

Ecology and biodiversity: ABR Ecology - abrecology@gmail.com

Topographical survey: Andy Stretch ADS surveys. - andy@ads-surveys.uk

Transport Statement: Nick Culhane - nick@nickculhane.co.uk

1.0 Introduction1.2 Site Location

SITE LOCATION:

Martinique Farm is a large plot with three redundant storage buildings in the village of East Martin. It has houses either side of the plot, is near the town of Fordingbridge and has good access to the A345 leading to the cities of Salisbury and Bournemouth.

This document supports proposals to replace the buildings with three high quality, sensitive, new environmentally sustainable homes that will match the existing approval.


The site is in the New Forest District in an Area Of Natural Beauty (AONB).

HIGH SPEED BROADBAND STATEMENT:

Super-fast Fibre is available at SP6 3JS Martinique Broadband speed:

Your download speed 45.7 Mb Your upload speed 19 Mb

Super fast fibre will be brought into each new dwelling

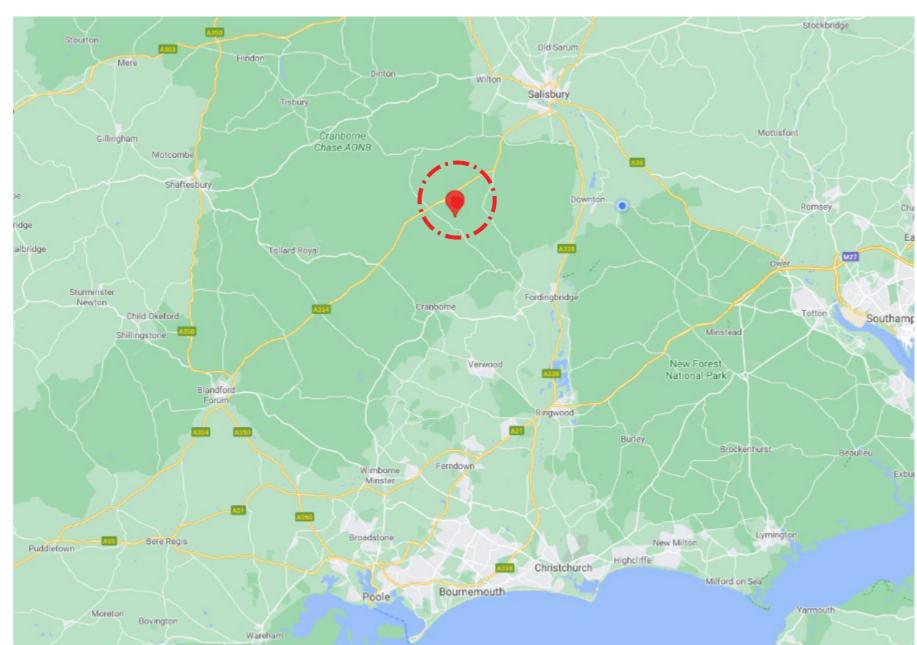


1.0 Introduction1.3 Site Description

SITE DESCRIPTION

Martinique is a plot of land with three redundant workshop buildings.

The access is via a private track off the road. There is an existing gate and access point between the road and the track to the site which allows visibility in both directions. There is an existing native hedge and mature established trees along the road boundary and to the boundary edge of the access track. The buildings are largely screened from the road by mature trees and bushes, and does not overlook the neighbouring dwellings either side. To the rear of the buildings there is a mixture of grass and hard standing with views over mature hedgerow to fields beyond and a public right of way.

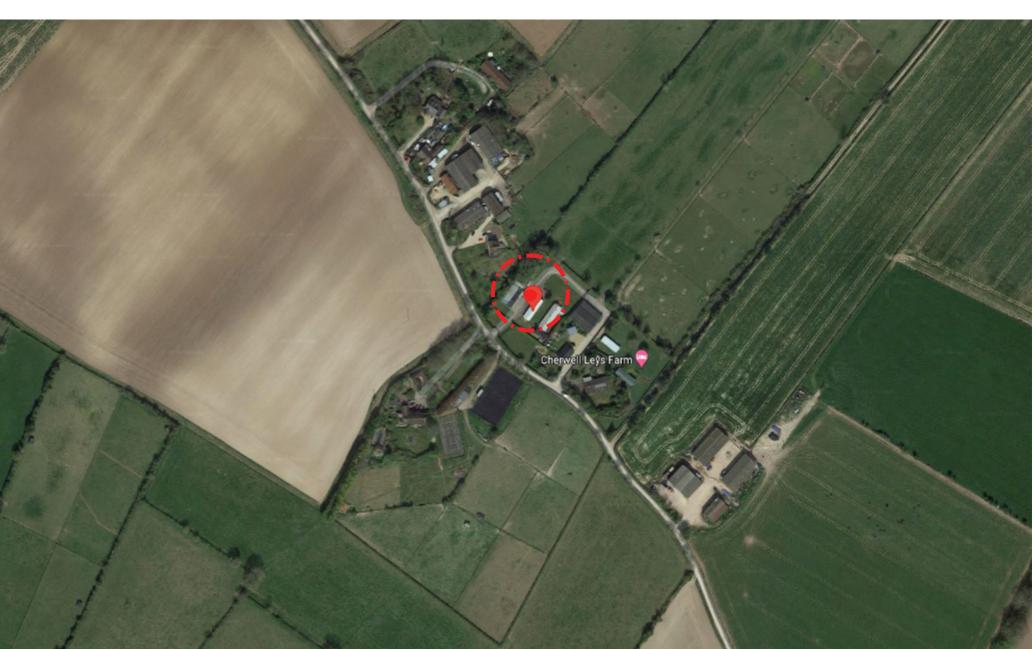

PROPOSAL OUTLINE:

There is an existing planning approval to convert the three existing buildings on the site into three new detached dwellings - 22/11012 - 30th August 2022.

This proposal is to replace the existing three buildings with three high quality, well insulated, energy efficient dwellings which will replicate the existing building footprint and are identical to the existing approval in appearance. Each will have generous amenity space and parking and create great new homes.

The ability to build new replacement structures will allow the client to build better quality, more sustainable homes that will offer more flexibility for client's changing needs and will reduce the impact on the environment and climate. The existing barns can be converted in dwellings, as has been demonstrated with the previous application and structural report, but a new build process will achieve higher air tightness, greater insulation levels and and lead to a less waste on site. The new build homes will be identical in appearance to the approval for the conversion of the barns.

1.0 Introduction1.4 Local Context





VIEW 01



KEY PLAN





VIEW 07

VIEW 05

VIEW 06


VIEW 08







1.0 Introduction 1.5 Site Images

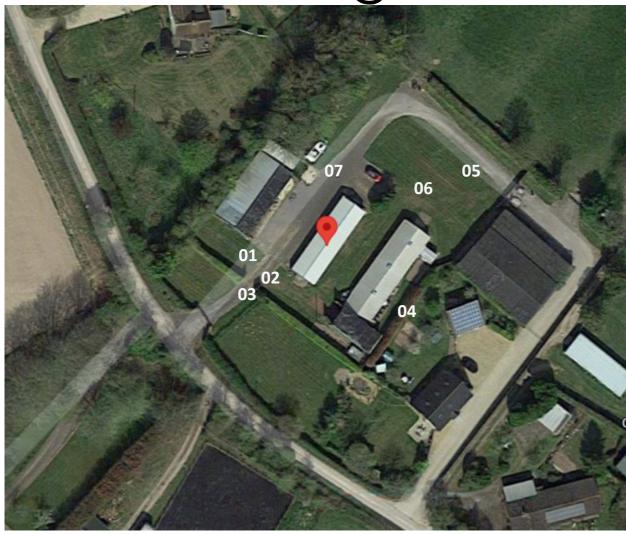



VIEW 01











VIEW 05

VIEW 06

birch architects





VIEW 04





2.0 Site Context2.1 Site Analysis

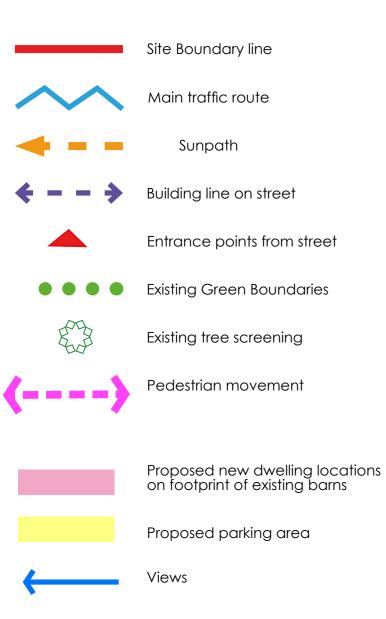

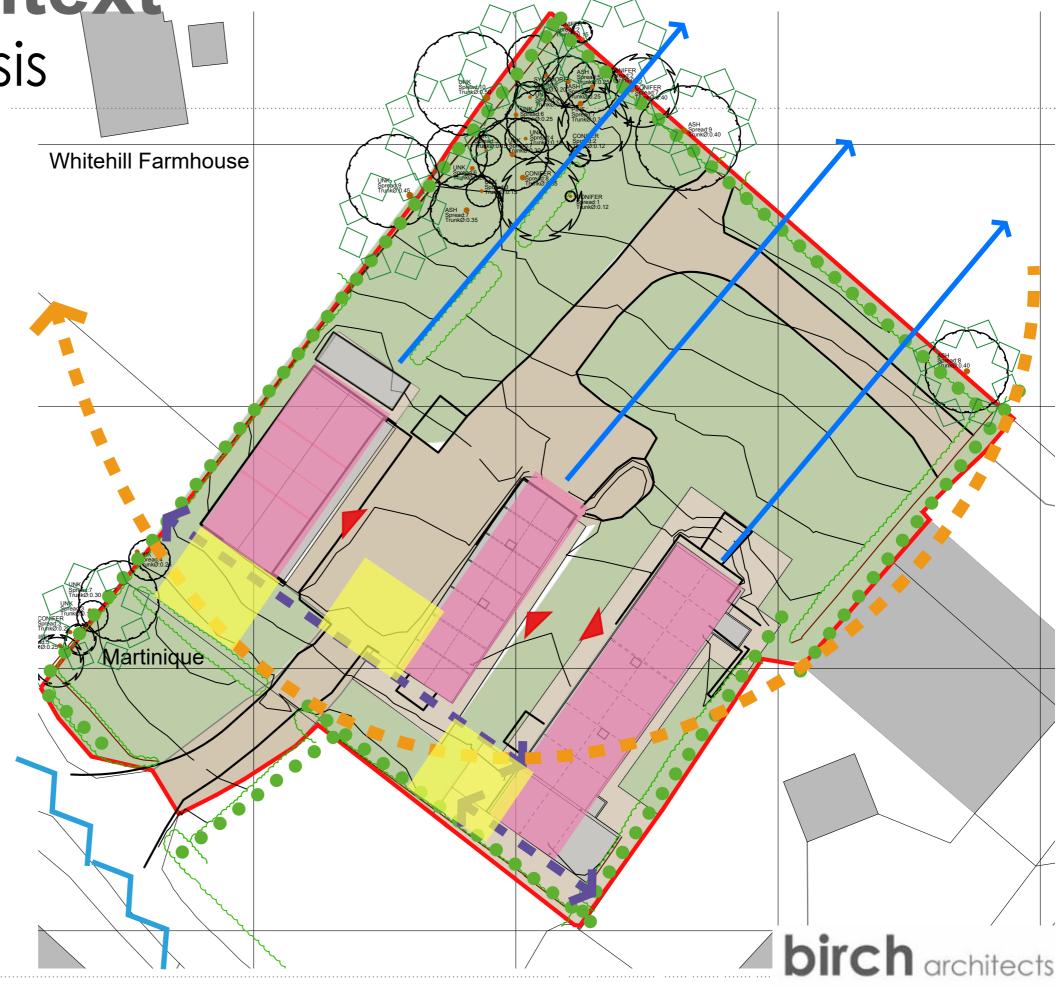

3.0 Development3.1 Planning Statement and History

STATEMENT

• Please refer to planning statement by RAW planning

4.0 Proposal 4.1 Proposal Description

PROPOSAL DESCRIPTION

This proposal is for the replacement of three existing workshop buildings on the plot of Martinique in East Martin with three new build dwellings that match the existing approval. The planning application is to change the use into three new high quality dwellings of the same floor area.

All of the dwellings will be accessed off a single track which leads to the entrances of each plot.

Plot 1 -

Building 1 (the western most building) is the smallest of the 3 dwellings measuring 18m x 9.4m and 2.4m to eaves and 3.6m to ridge.

The proposed new dwelling will replicate the footprint and aesthetic of the existing barn. The ridge height will be identical to the existing. The ground, wall and roof will all achieve higher levels of insulation, weather and air tightness required for new homes. The walls will be clad with horizontal natural timber, and the roof will be upgraded with natural slate. New large sliding timber barn doors to the side elevation will be pinned back and opened to create a large glazed opening in each side of the long elevation of the barn and form the main entrance.

Externally there will be residential gardens to the front and rear with a new mature hedge and post and rail fence creating privacy on the front to the entrance track and with plot 2. There is an existing hedge and fence along the boundary with Whitehill Farmhouse which will be retained and enhanced to maintain privacy.

A static caravan will be removed and there will be a minimum of 3no. Parking spaces and bin/cycle storage to the front.

Solar PVs will be located on the South east facing roof area along with new rooflights.

Internally the space will be vaulted with bedrooms to the front and family spaces to the rear. The garden facing elevation opens onto a patio area and allows views over the fields, but avoids overlooking of neighbouring plots.

Plot 2 -

Building 2 (the central building) measures 21m x 6.2m and 2m to eaves and 3m to the ridge.

The proposed new dwelling will replicate the footprint and aesthetic of the existing barn. The ridge height will be identical to the existing. The ground, wall and roof will all achieve higher levels of insulation,

weather and air tightness required for new homes. The walls will be clad with horizontal natural timber, and the roof will be upgraded with natural slate. New large sliding timber barn doors to the side elevation will be pinned back and opened to create a large glazed opening in each side of the long elevation of the barn and form the main entrance.

Externally there will be residential gardens to the front and rear with a new mature hedge and post and rail fence creating privacy on the front to the entrance track and to plots 1 and 3.

Internally the hall and utility area are all located in this section. The open plan living/kitchen/dining space is located to the garden elevation and allows more natural light and via sliding doors creates a physical connection between interior and exterior.

Externally, a minimum of 3no. Dedicated parking spaces are provided. There is ample turning space and existing hard standing is incorporated. The plot has private rear garden and additional garden space to the side. This is enclosed by a mature hedge along the track and screened from neighbouring plots by a new hedgerow and post and rail fence

This matches similar wall/hedge treatment to other nearby existing dwelling frontages. The site boundaries extend to the track however, boundary treatments will be set back around the existing gate entrance in order to preserve maximum visibility and allow for emergency vehicle turning.

Solar PVs will be located on the South east facing roof area along with new rooflights to improve natural daylight and natural ventilation

Internally the space will be vaulted with bedrooms to the front and family spaces to the rear. The garden facing elevation opens onto a patio area and allows views over the fields, but avoids overlooking of neighbouring plots.

Plot 3 -

Building 3 (the eastern most building) is the largest of the buildings with the main part of the building measuring 25.2m X 7.2m and 2m to eaves and 3.2m to ridge. A mono pitched element is located along the south elevation measuring 11.2m X 5.6m and with a ridge height of 4m at its highest point.

The proposed new dwelling will replicate the footprint and aesthetic of the existing barn. The ridge height will be identical to the existing. The ground, wall and roof will all achieve higher levels of insulation, weather and air tightness required for new homes. The walls will be clad with horizontal natural timber, and the roof will be upgraded with natural slate. New large sliding timber barn doors to the side elevation will be pinned back and opened to create a large glazed opening in each side of the

long elevation of the barn and form the main entrance.

The existing monopitch garage block will be removed and replaced with a single storey garage and carport that is clad to match the new dwelling

Externally there will be residential aardens to the front and rear with a new mature hedge and post and rail fence creating privacy on the front to the entrance track and to plot 2. There is a large existing hedge along the boundary with Futcher's Farm which will be retained to maintain privacy.

Internally the hall and utility area are all located in this section. The open plan living/kitchen/dining space is located to the garden elevation and allows more natural light and, via sliding doors, creates a physical connection between interior and exterior.

Externally a minimum of 3no. dedicated parking spaces are provided. There is ample turning space and existing hard standing is incorporated. The plot has private rear garden and additional garden space to the side. This is enclosed by a mature hedge along the track and screened from neighbouring plots by a new hedgerow and post and rail fence

This matches similar wall/hedge treatment to other nearby existing dwelling frontages. The site boundaries extend to the track however, boundary treatments will be set back around the existing gate entrance in order to preserve maximum visibility and allow for emergency vehicle turning.

Solar PVs will be located on the South East facing roof area along with new rooflights to improve natural daylight and natural ventilation.

Internally the space will be vaulted with bedrooms to the front and family spaces to the rear. The garden facing elevation opens onto a patio area and allows views over the fields, but avoids overlooking of neighbouring plots.

Design Principles:

The proposed dwellings have been developed in accordance with the following principles: • To be in keeping with and respectful of surrounding

properties.

• To preserve and enhance the character of East Martin.



4.0 Proposal4.2 Proposal Description

• To provide a high-quality residential development.

window reveals and horizontal timber cladding.

• To significantly improve the overall appearance of the existing site.

- To provide a scale of development appropriate to the locality, reflecting both scale and density found in the surrounding area.
- To introduce both sympathetic and modern design which respects the grain, scale and mass of the area and is respectful of the existing planning approval for the barn conversions.
- To preserve the visibility provided by the site onto the track whilst avoiding overlooking and maintaining privacy.

The constraints of the site are an important element that needs to be understood when considering development. As such a review of the site and its surroundings were undertaken to help to inform the design process. The constraints and opportunities are as follows:

Layout constraints:

- Existing building envelope sizes.
- Existing structures within site boundary that will be removed as part of the application.
- The principles of building regulations for new dwellings.
- Ensuring adequate amenity space for dwellings.
- Provision of adequate parking whilst maximising area able to be landscaped.

Layout opportunities:

- Enhancement of site and surroundings creating a low density site with a high quality well insulated and ventilated sustainable dwellings;
- Opportunity to provide a property that relates to the surrounding context;
- More effective land use whilst providing a new home to contribute to the housing demand;
- Views afforded from the site.
- Improvement on the existing buildings and better use of the surroundings and will create great, sustainable family homes. available space.

Aesthetics:

The dwellings have been designed to match the existing approved design and with the local vernacular in mind, with inspiration taken from the area including: slate roof tiles, long vertical windows, deep

Sustainability:

The proposed dwellings are located on a previously developed site and will result in more effective and sustainable land use. The new dwellings will also incorporate a number of features which will allow for a good environmental performance. These will include:

- Quality windows and doors with high U-Values.
- High performance heating system using air source heat pumps and MVHR.

• High levels of insulation and air tightness achieved with a new build structure.

Landscape:

There are no landscape features which will be lost due to development. The proposal seeks to provide opportunity to further enhance the site through the use of hard and soft landscaping.

Flood:


The site is not located in a Flood Zone, nor will its development result in flooding elsewhere.

Access:

The track is suitable for bin access and fire tender. There is a bin and bike store located off the drive on each plot with a collection point at the main gate. Level access leads from the parking area to the main entrance and the utility door. The new bi-fold doors in the gable will open onto a level patio space. All internal doors are sized to allow for 'lifetime Homes' principles (door sizes of 838) and avoid level changes at ground floor. All windows to bedroom and habitable spaces are sized to act as means of escape in an emergency.

Conclusion:


As set out in this Design and Access statement, we believe the proposals provide high quality, well designed and sustainable accommodation, whilst seeking to enhance and add further to the character of the area. They do not cause any material harm or undue impact on the surroundings and will create great, sustainable family homes.

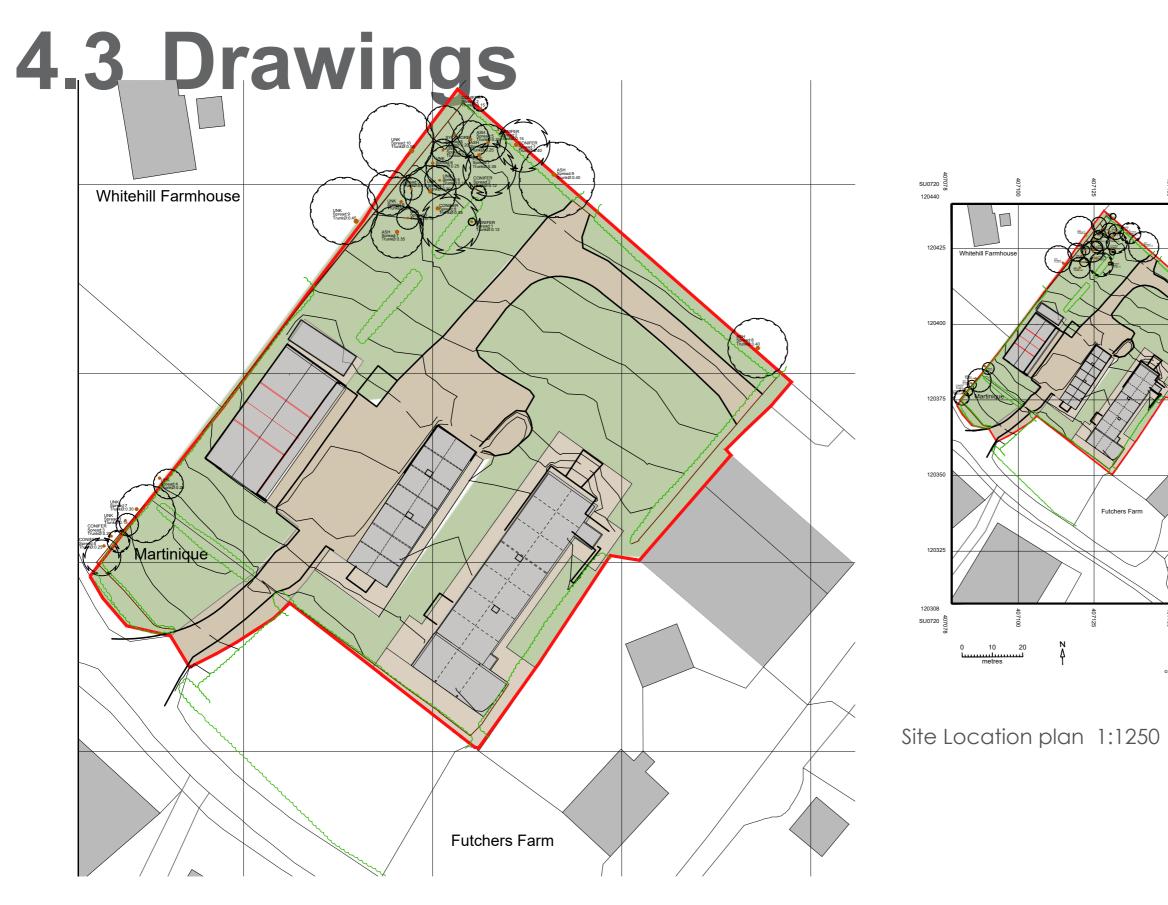

Existing Site plan 1:500





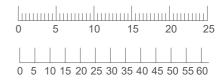

Rev -

rev a_31-10-2023_application to replace existing approved scheme for identical new build scheme.

.

Client: Mr C Shering		Planning		
Project: Martinique Farm, East Martin FORDINGBRIDGE, SP6 3JS		Drawing No: 249-02-01-001	Revision: A	
Title: Existing Site plan	Drawn: sb Check:	Scale: 1:500 & 1250 @ɑ3	First Issue: Aug 2022	
birc Lambourne, Grove Lane, I: +44 (0) 1725 510407 e: info@bircharchitect	Redlynch	salisbury, Wilts		

4.4 Drawings



Existing Topo plan 1:500



. . .

Topographical Plan ADS Surveys Ltd office:

Andell House, Highfield Lane, Woodfalls, Salisbury, Wiltshire, SP5 2NG


T: 07738462205

1:500 1:500 0 5 10 15 20 25

rev A_31-10-2023_application to replace existing approved scheme for identical new build scheme.


Rev -			
Client: Mr C Shering		Planning	
Project: Martinique Farm, East Martin FORDINGBRIDGE, SP6 3JS		Drawing No: 249-02-01-002	Revision: A
Title: Topo plan	Drawn: SD Check:	Scale: 1 :500@ɑ3	First Issue: Aug 2022
Lambourne, Grove Lane, I: +44 (0) 1725 510407 e: info@bircharchitects	Redlync	h, Salisbury, Wilts	

4.5 Drawings

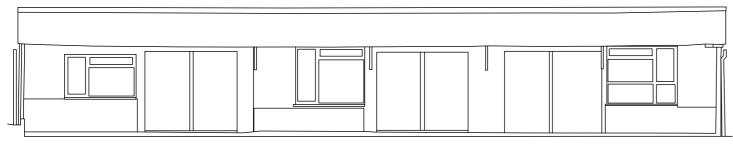


EAST


Side elevation @ 1:100

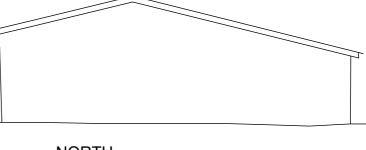


NORTH

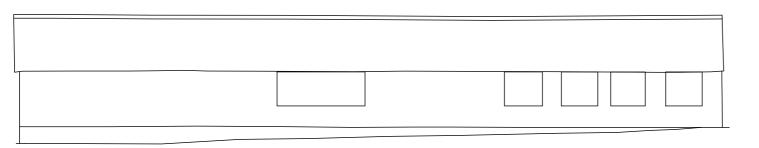

WEST

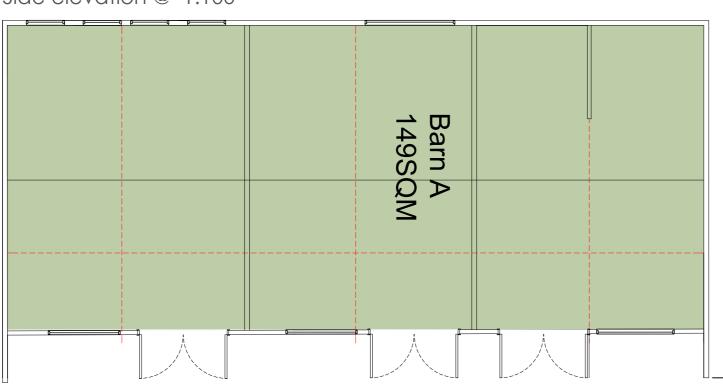

Side elevation @ 1:100

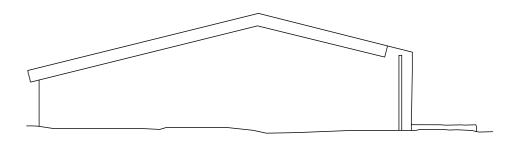

SOUTH



Topographical and elevation survey carried out by ADS

Existing plan @ 1:100

Topographical and elevation survey carried out by ADS

Rear elevation @ 1:100

Front elevation @ 1:100



1:100 1 2 3 4 5 rev A_31-10-2023_application to replace existing approved scheme

for identical new build scheme


Client: Mr Shering		Planning	
Project: Martinique Farm, East Martin FORDINGBRIDGE, SP6 3JS		Drawing No: 249-03-91-001	Revision: A
Title: Plot 1 Existing elevations	Drawn: ND Check:	Scale: 1:100 @ɑ3	First Issue: Aug 2022
birc Lambourne, Grove Lane, T: +44 (0) 1725 510407 e: info@bircharchitects	Redlynch	salisbury, Wilts	

4.6 Drawings


EAST Side elevation @ 1:100	NOR Rear ele
WEST Side elevation @ 1:100	sout Front ele
Barn B 1277SQM	

Topographical and elevation survey carried out by ADS

Iopographical and elevation survey carried out by ADS

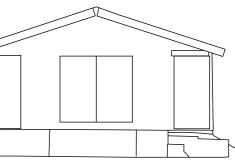

RTH evation @ 1:100

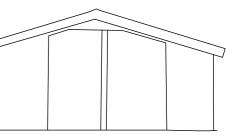

ΓН




rev b_31-10-2023_application to replace existing approved scheme for identical new build scheme.

rev a 2	1-11-2022_	plans and	elevations	updated	to reflect	t existing
10V u_2	1 11 2022	piùns unu	cicvations	upuulou	10 101100	r existing


Client: Mr Shering		Planning	
Project: Martinique Farm, East Martin FORDINGBRIDGE, SP6 3JS		Drawing No: 249-03-91-002	Revision: B
Title: Plot 2 Existing elevations	Drawn: ND Check:	Scale: 1:100 @ɑ3	First Issue: Aug 2022
birc Lambourne, Grove Lane, T: +44 (0) 1725 510407 e: info@bircharchitects	Redlynch	salisbury, Wilts	


4.7 Drawings

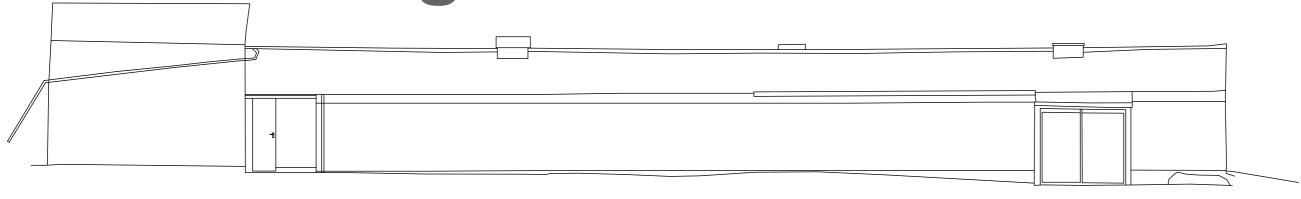

EAST

Side elevation @ 1:100

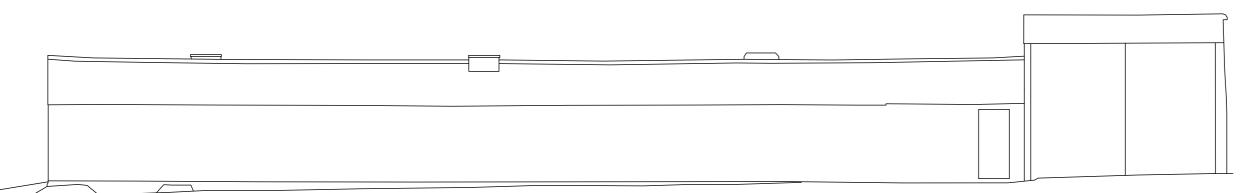

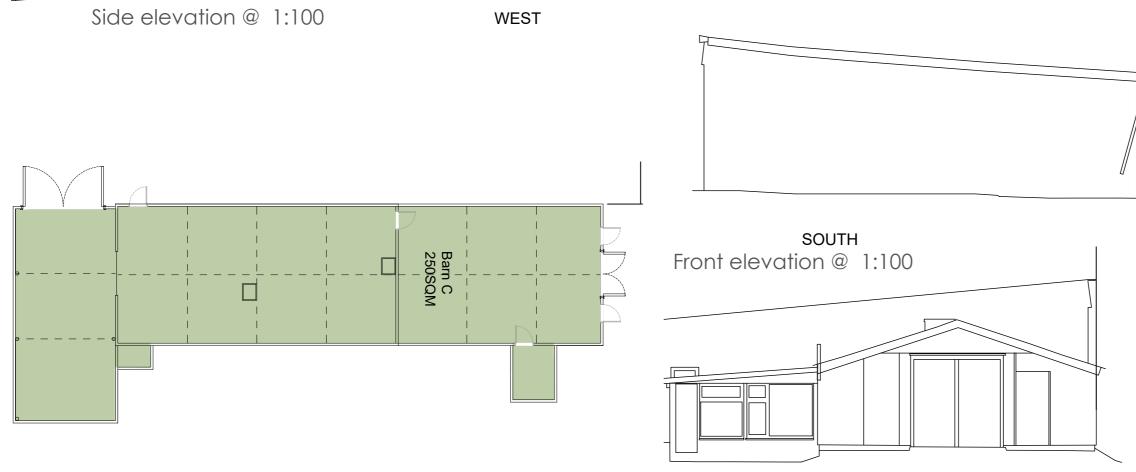

Existing plan @ 1:200

NORTH Rear elevation @ 1:100

Topographical and elevation survey carried out by ADS




1:100 1 2 3 4 5 rev A_31-10-2023_application to replace existing approved scheme

for identical new build scheme

Client: Mr Shering		Planning	
Project: Martinique Farm, East Martin FORDINGBRIDGE, SP6 3JS		Drawing No: 249-03-91-002	Revision: B
Title: Plot 2 Existing elevations	Drawn: ND Check:	Scale: 1:100 @ɑ3	First Issue: Aug 2022
Lambourne, Grove Lane, T: +44 (0) 1725 510407 e: info@bircharchitect	Redlynch	Irchit Salisbury, Wilts,	


4.8 Drawings

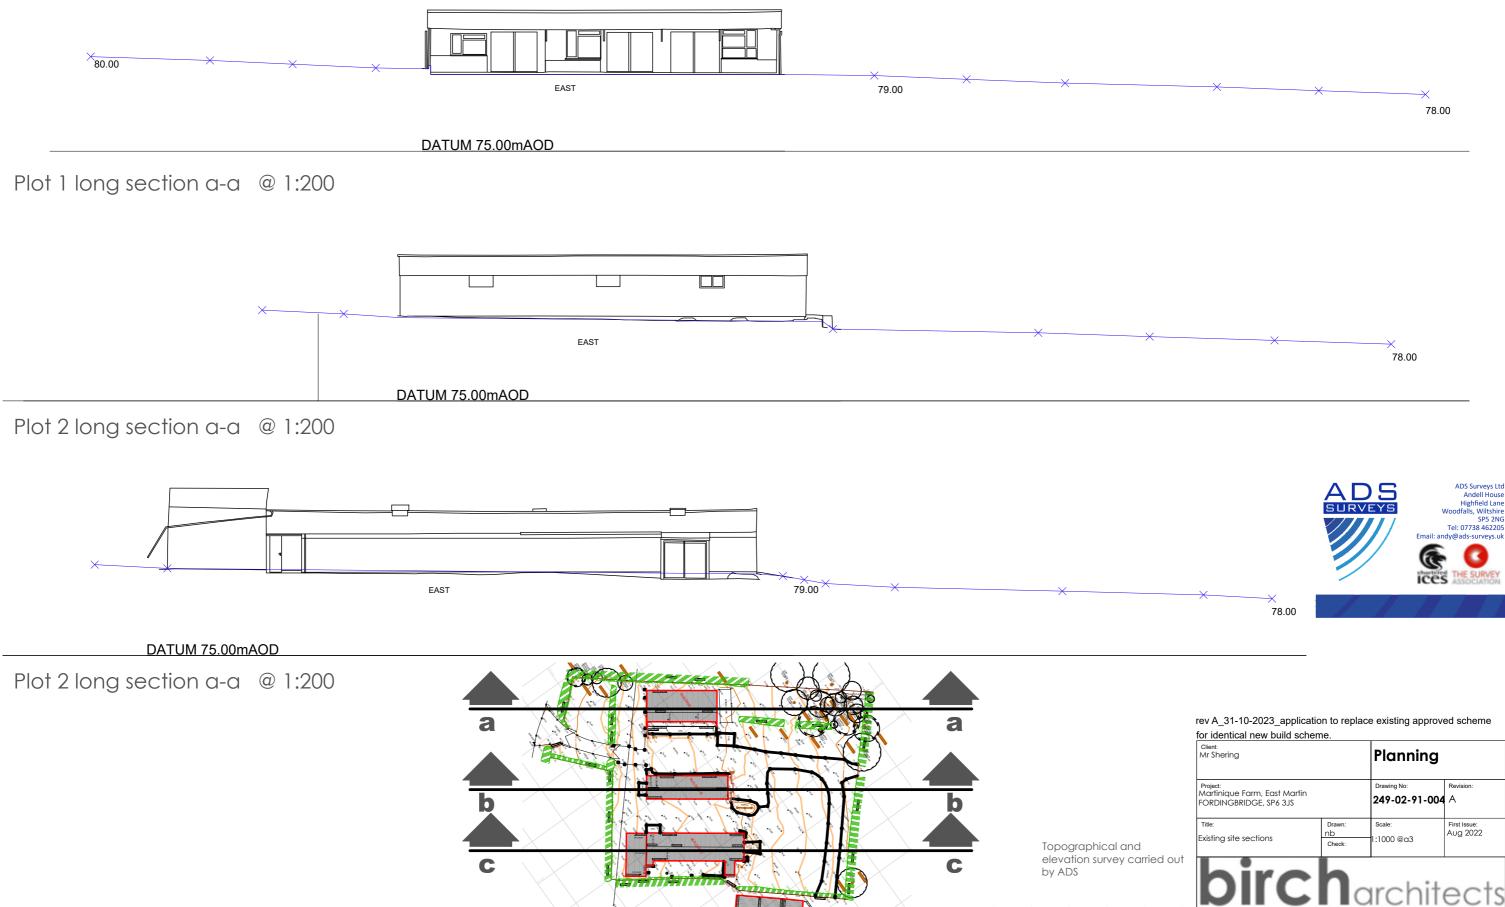

Key plan

0 10 20 30 40 0

	Client: Mr Shering		Planning	
	Project: Martinique Farm, East Martin FORDINGBRIDGE, SP6 3JS		Drawing No: 249-02-91-004	Revision: A
	Title: Existing site sections	Drawn: ND Check:	Scale: 1:1000 @ɑ3	First Issue: Aug 2022
out	Lambourne, Grove Lane, T: +44 (0) 1725 510407 e: info@bircharchitects	Redlynch	salisbury, Wilts	

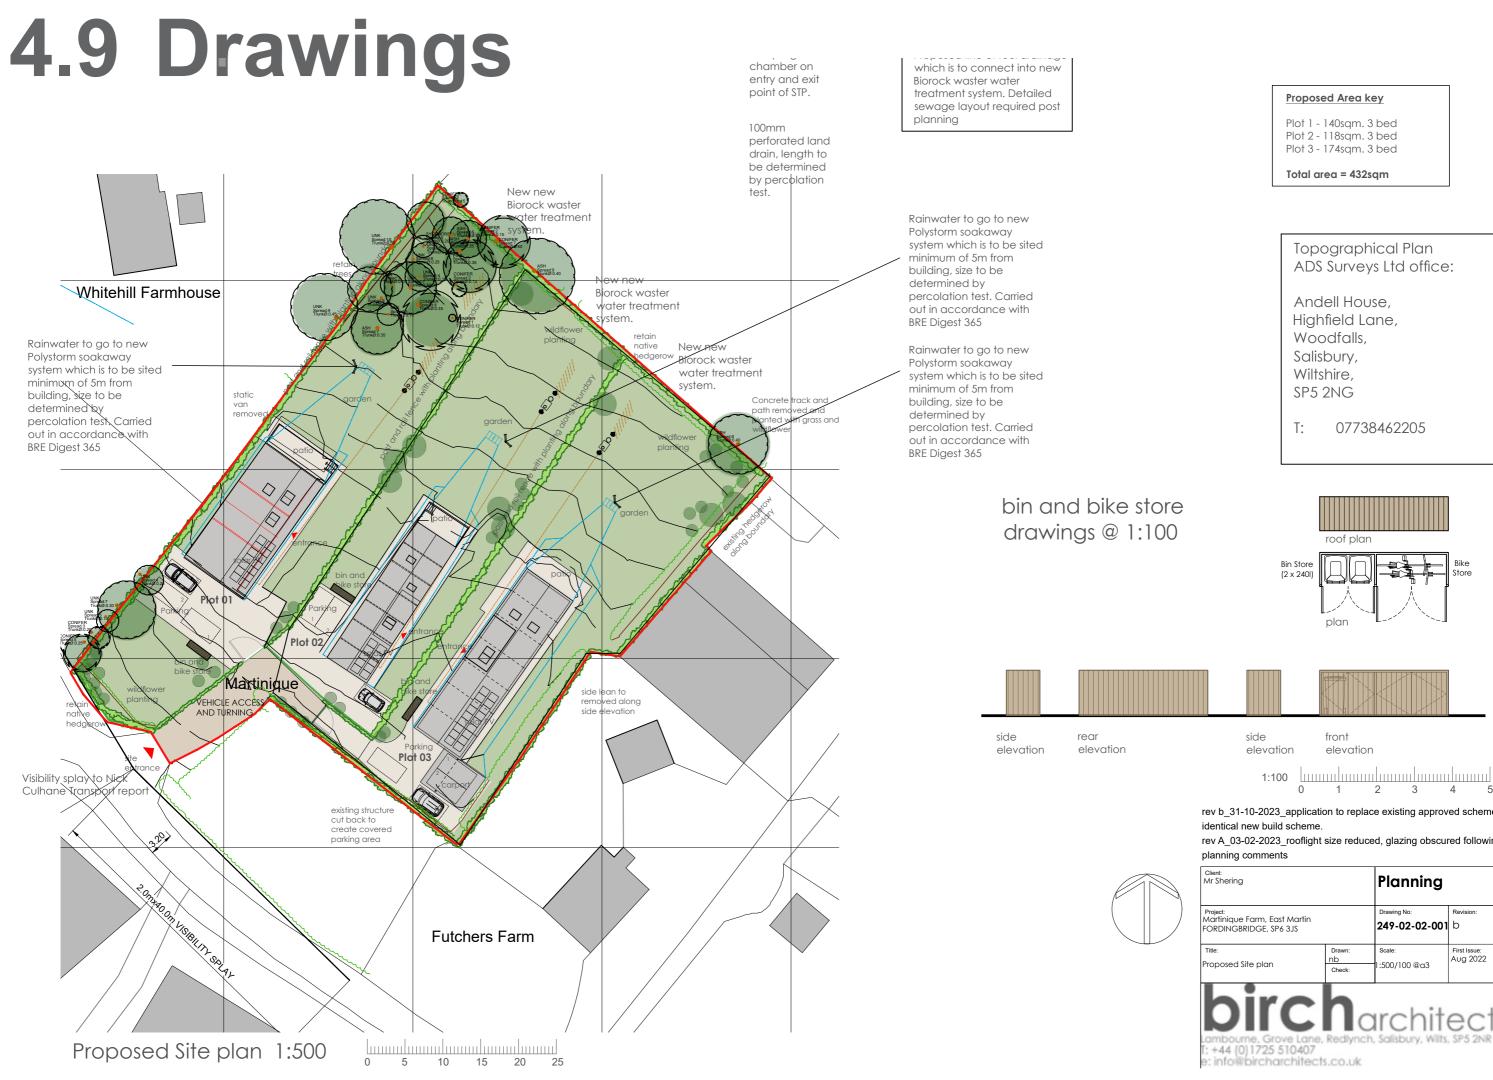





rev b_31-10-2023_application to replace existing approved scheme for

rev A 03-02-2023 rooflight size reduced, glazing obscured following

Client: Mr Shering		Planning	
Project: Martinique Farm, East Martin FORDINGBRIDGE, SP6 3JS		Drawing No: 249-02-02-001	Revision: b
Title: Proposed Site plan	Drawn: ND Check:	Scale: 1:500/100 @ɑ3	First Issue: Aug 2022
Lambourne, Grove Lane, I: +44 (0) 1725 510407 e: info@bircharchitects	Redlynch	salisbury, Wilts	

4.10 Drawings



Note:

Fixed blinds provided to certain window openings in order to minimise light pollution in this sensitive AONB. To be clarified by case officer




rev C_31-10-2023_application to replace existing approved scheme for identical new build scheme.

rev b_03-02-2023_rooflight size reduced, glazing obscured following planning comments rev a_21-11-2022_Windows rationalised and amended following

rev a_21-11-2022_Windows rationalised and amended following planning comments

Client: Mr Shering		Planning	
Project: Martinique Farm, East Martin FORDINGBRIDGE, SP6 3JS		Drawing No: 249-02-03-001	Revision: C
Title: Proposed plan plot 1	Drawn: ND Check:	Scale: 1:100 @ɑ3	First Issue: Aug 2022
Lambourne, Grove Lane, 1: +44 (0) 1725 510407 e: info@bircharchitects	Redlynch	Irchit , Salisbury, Wilts,	

4.11 Drawings

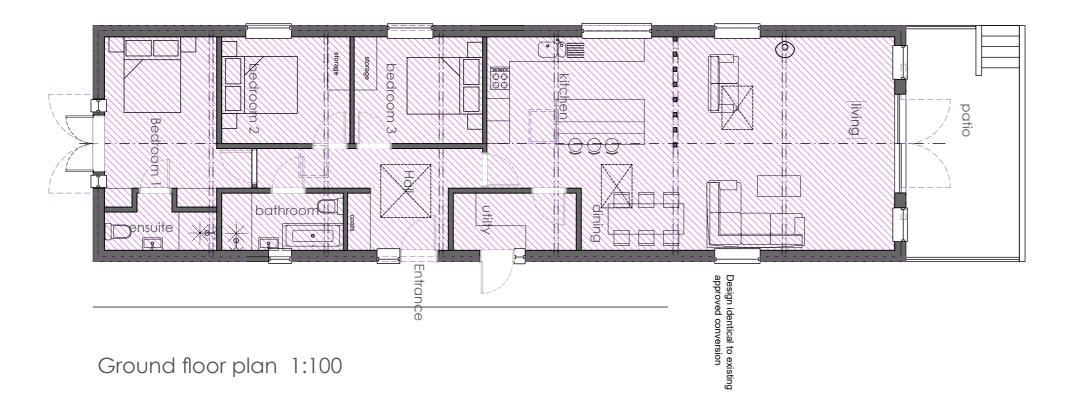

				rooflights to obscure gla reduce ligh	o have azing to t emittance	
		[]	[]	[]		
		ii ii	ii ii			

Roof plan 1:100

rooflights to have obscure glazing to reduce light emittance

rooflights to have obscure glazing to reduce light emittance

Note:

Fixed blinds provided to certain window openings in order to minimise light pollution in this sensitive AONB. To be clarified by case officer




rev C_31-10-2023_application to replace existing approved scheme for identical new build scheme.

rev b_03-02-2023_rooflight size reduced, glazing obscured following planning comments


rev a_21-11-2022_Windows rationalised and amended following planning comments

Client: Mr Shering		Planning			
Project: Martinique Farm, East Martin FORDINGBRIDGE, SP6 3JS		Drawing No: 249-02-03-002	Revision: C		
Title: Proposed plan plot 2	Drawn: ND Check:	Scale: 1:100 @ɑ3	First Issue: Aug 2022		
bircharchitects Lambourne, Grove Lane, Redlynch, Salisbury, Wilts, SP5 2NR T: +44 (0) 1725 510407 e: info@bircharchitects.co.uk					

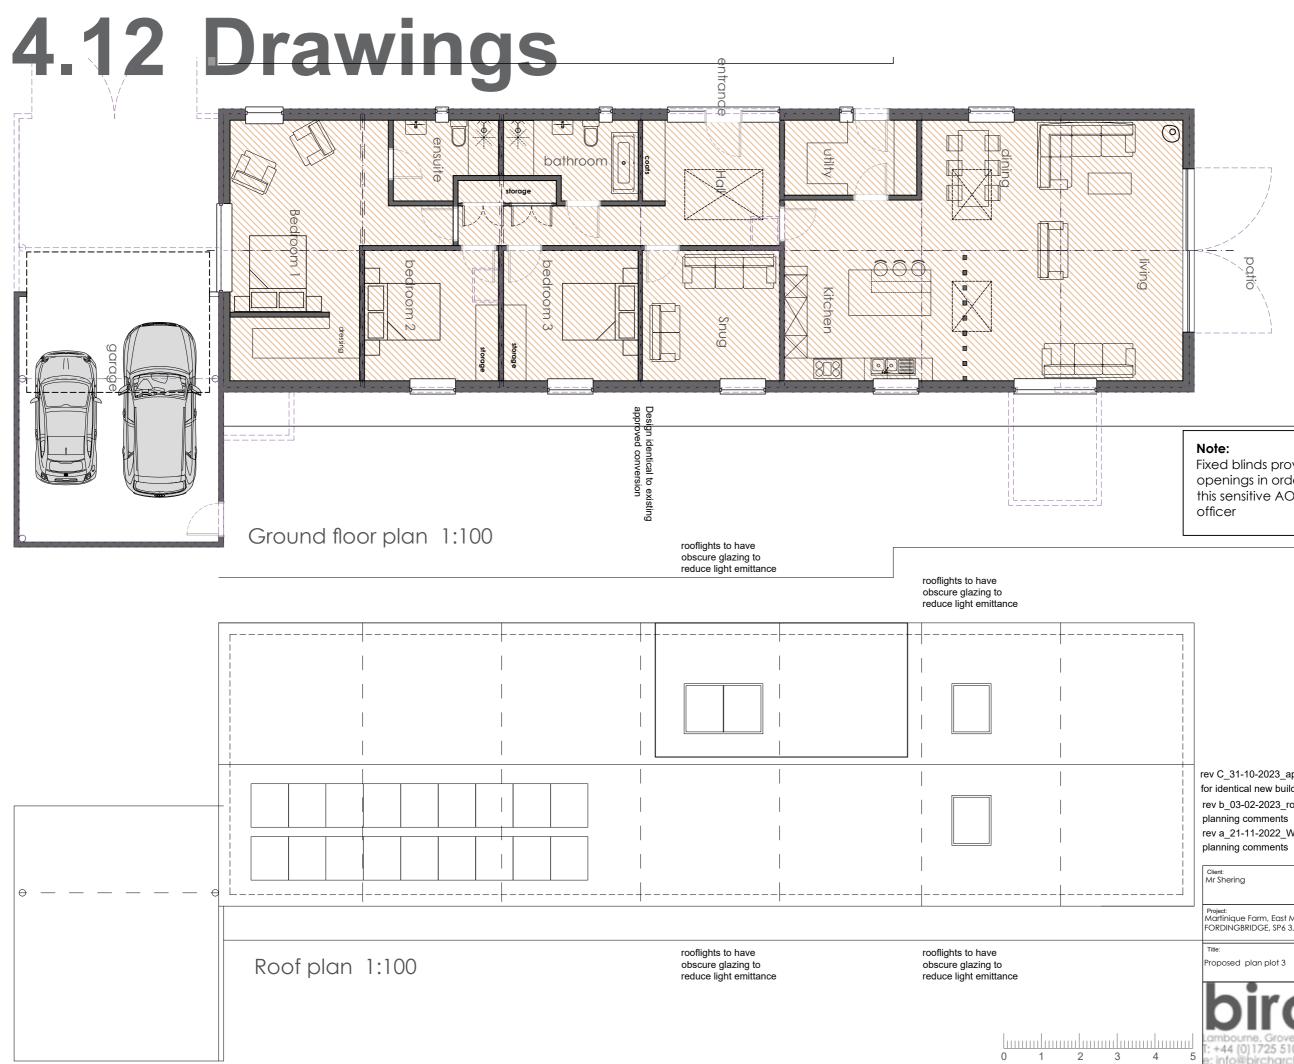

Fixed blinds provided to certain window openings in order to minimise light pollution in this sensitive AONB. To be clarified by case

	rev C_31-10-2023_application to replace existing approved scheme for identical new build scheme. rev b_03-02-2023_rooflight size reduced, glazing obscured following planning comments rev a_21-11-2022_Windows rationalised and amended following planning comments						
	Client: Mr Shering		Planning				
	Project: Martinique Farm, East Martin FORDINGBRIDGE, SP6 3JS	ı	Drawing No: 249-02-03-003	Revision: C			
	Title: Proposed plan plot 3	Drawn: ND Check:	Scale: 1:50 @ɑ3	First Issue: Aug 2022			
 5	T: +44 (0)1725 51040	ne, Redlynch,	Irchit Salisbury, Wilts,	~ ~ . ~			

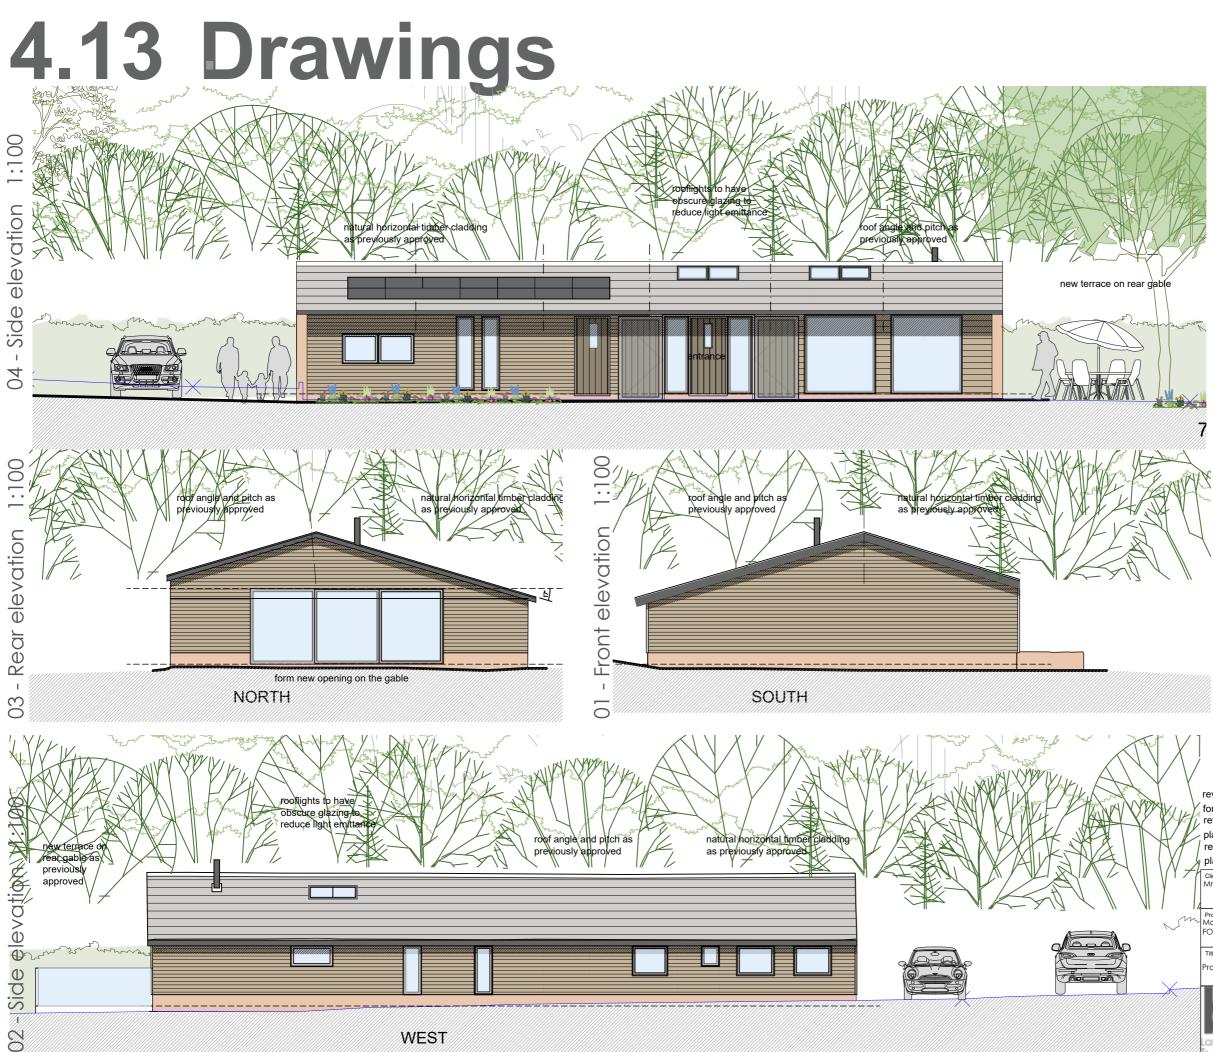

Material Key


- 1. Walls Brickwork plinth
- 2. roof slate tiles
- 3. Roof light velux
- 4. Gutters/downpipes half round / black

.....

- 5. Bi-fold-sliding doors grey aluminium
- 6. Windows grey aluminium
- 7. Fascias -grey
- 8. Walls- Natural timber cladding
- 9. walls render
 10. Door aluminium
- 11. glass balustrade
- 12. solar PVs
- 13. timber clad garage doors
- 14. timber post
- 15. new 5 bar gate

Note:

Fixed blinds provided to certain window openings in order to minimise light pollution in this sensitive AONB. To be clarified by case officer

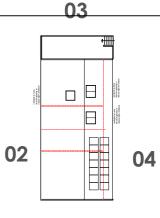

01 key plan 1:100 0 1 2 3 4 5


rev C_31-10-2023_application to replace existing approved scheme for identical new build scheme. rev b_03-02-2023_rooflight size reduced, glazing obscured following


planning comments rev a_21-11-2022_Windows rationalised and amended following

rev a_21-11-2022_Windows rationalised and amended following planning comments

Client: Mr Shering		Planning		
~	Project: Martinique Farm, East Martin FORDINGBRIDGE, SP6 3JS		Drawing No: 249-02-05-001	Revision: C
	Title: Proposed elevations plot 1	Drawn: Nb Check:	Scale: 1:100 @ɑ3	First Issue: Aug 2022
			Irchit Salisbury, Wilts	0.0

e: info@bircharchitects.co.uk

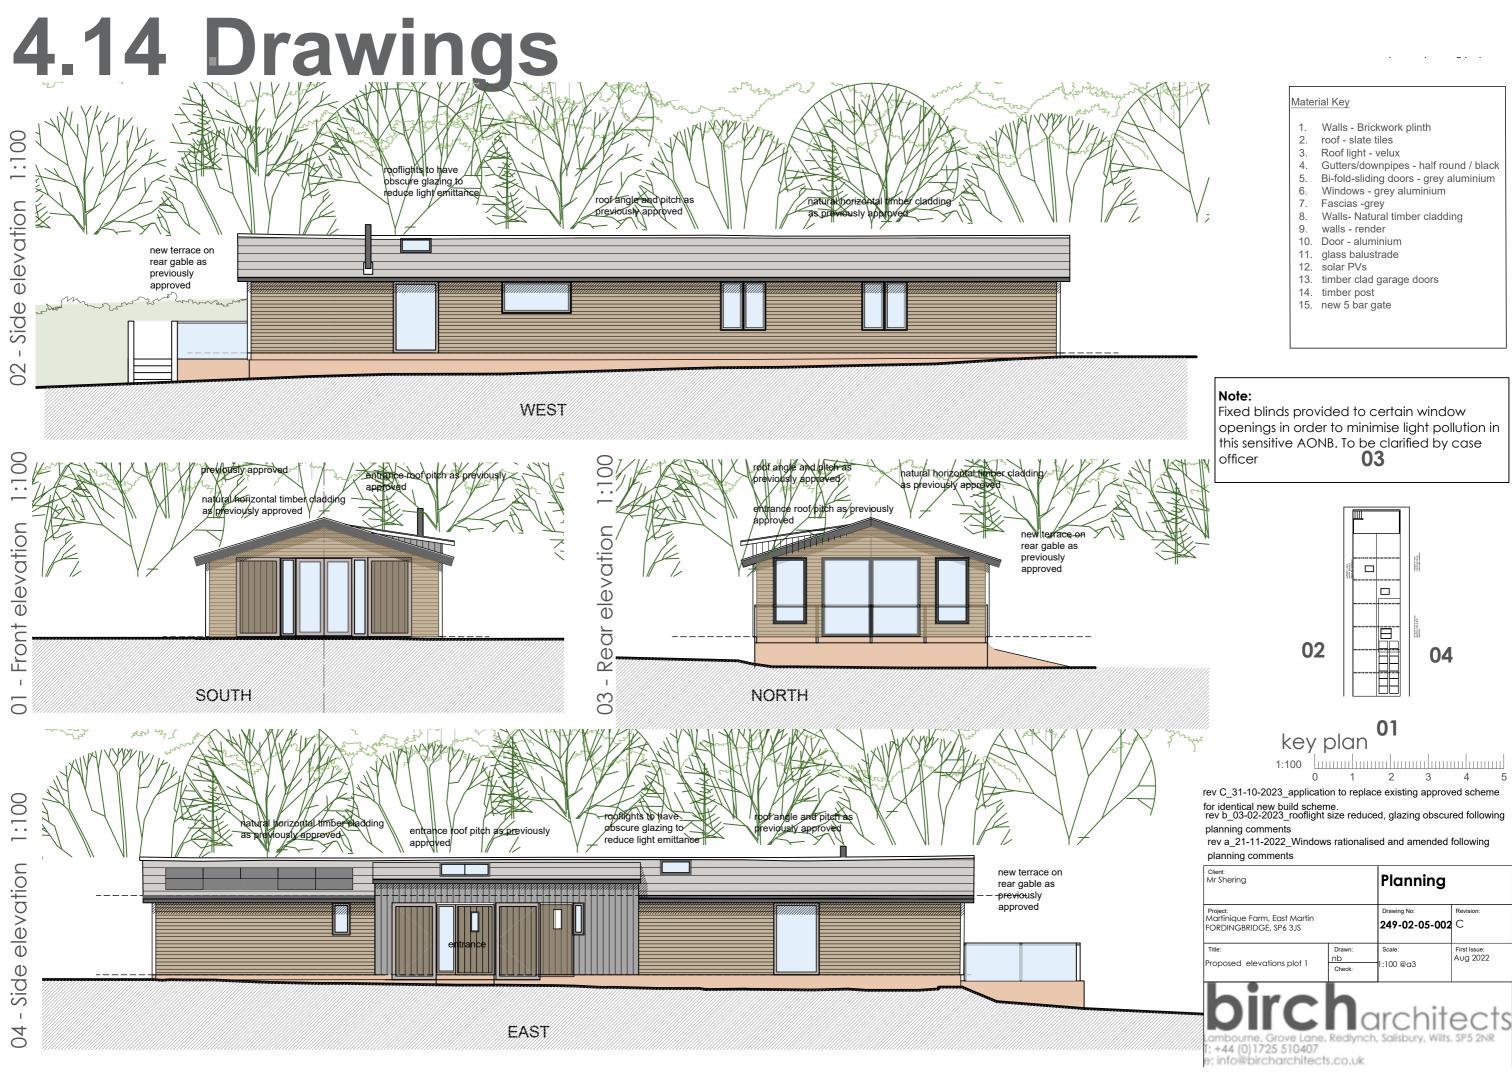

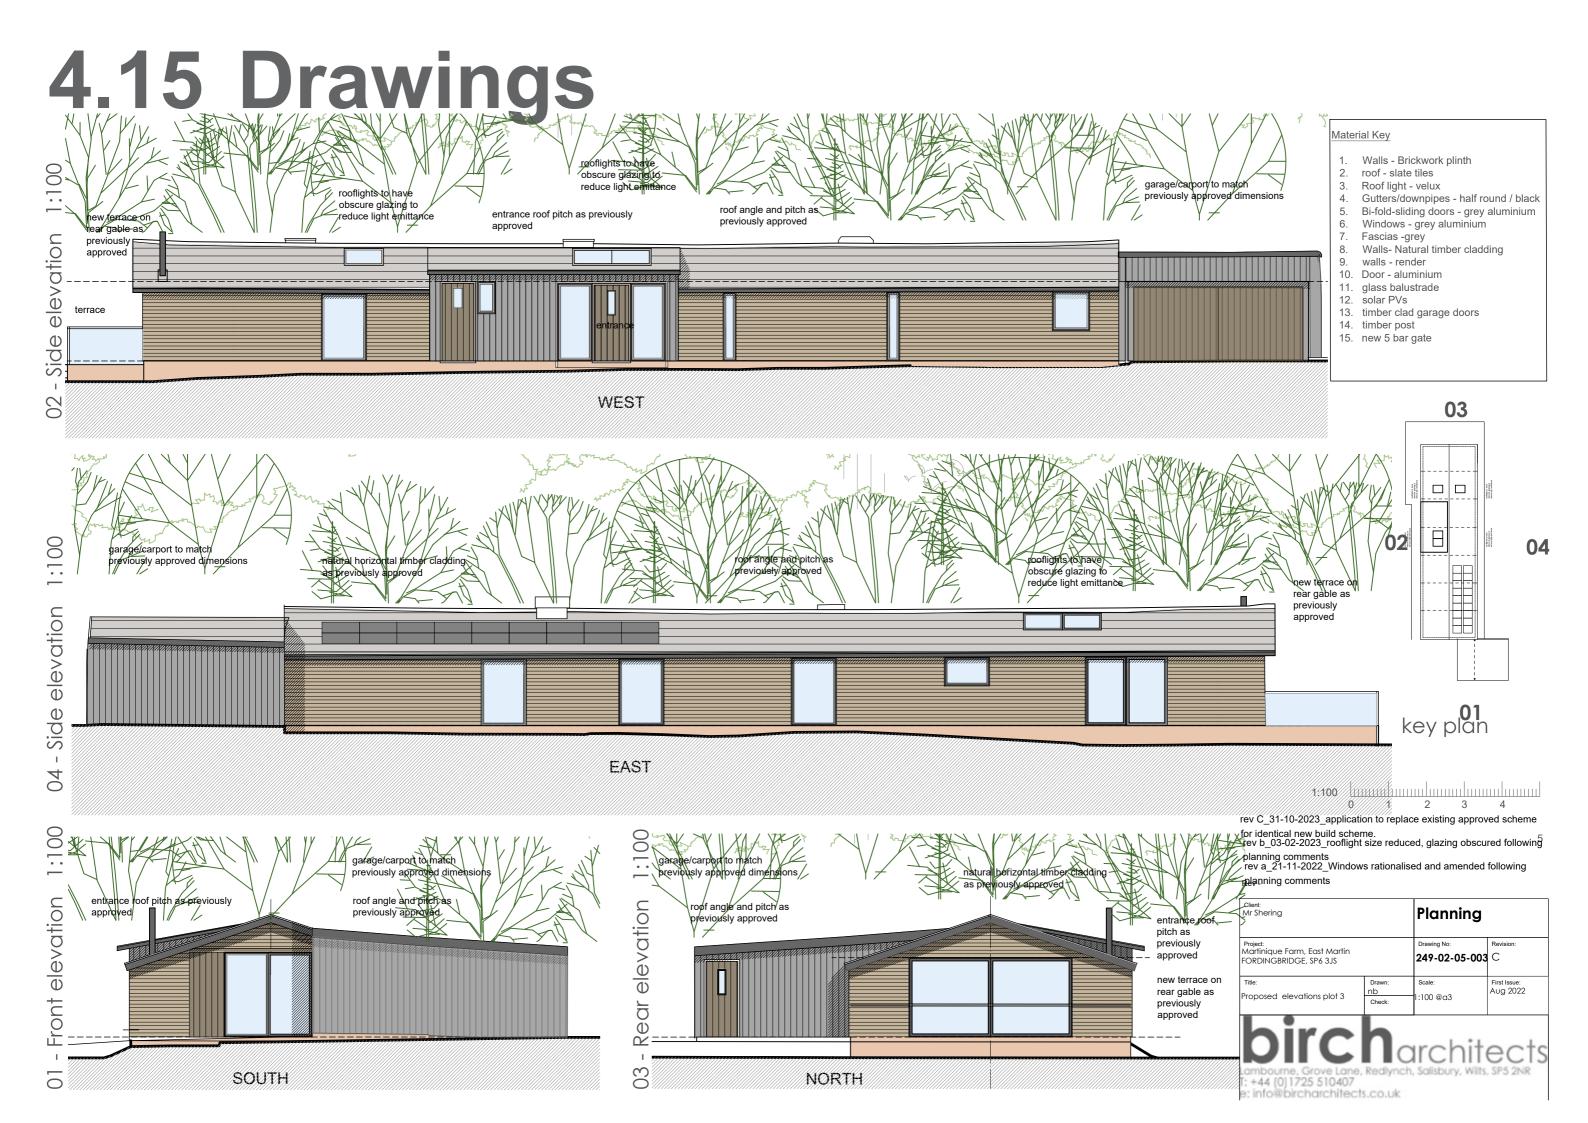

5.0 Precedents 5.1 Examples







7.0 Access Strategy7.1 Overview & Accessibility

VEHICULAR ACCESS

Vehicular access for the site is accessed from the existing track. There is an existing metal 5 bar gate providing access onto the track and new 5 bar gates will define the new entrance.

There are 3 parking spaces per plot.

BICYCLE ACCESS

Access for bicycles is provided along the vehicular access routes with individual storage areas provided on site in the enclosed secure garage areas.





7.0 Access Strategy7.2 Refuse

REFUSE

Refuse collection for all dwellings is from the roadside, with provisions for refuse storage provided on site in a dedicated storage area.




Refuse Storage



7.0 Access Strategy7.3 Fire

FIRE

In the event of fire the new dwellings are easily accessible from the existing track.

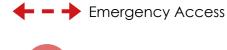

Turning area

PART B: Fire tender access.

Track to be minimum 3.7m wide and capable of supporting min 12.5ton vehicle. Min clearance height 3.7m

Gateway access to be min 3.1m clear. Turning circle 20m dia. All internal rooms with 45m of fire tender.



7.0 Access Strategy7.4 Landscape

Biodiversity Net Gain Enhancement




• Use native/wildlife-friendly shrubs and trees in the planting proposed around the dwellings

• Extend the hedge planting on boundary.

• Native hedge/shrub planting along the boundary of each plot to create privacy screen. To be maintained at a height of 1.8m.

• Existing grass to retain

• Seed at least a 1 metre wide area around the boundary of the garden space with Emorsgate EL1 - Flowering Lawn Mixture, to improve plant diversity and allow this grassland to grow long.

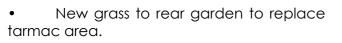

• Existing views into the site from the fields improved by design of new dwellings.

• Mature trees retained to screen the development from long distance views.

• Parking for the dwellings. Gravel finish with gravel board edging.

• New dwellings all replace existing building footprints. No new building line.

• Views along road unaffected by the proposals.

 Native mixed hedge row and trees spaced every 10m to southern boundary (oak and yew).
 Visibility splay to Nick Culhane Transport report

Whitehill Farmhouse

Rainwater to go to new Polystorm soakaway system which is to be sited minimum of 5m from building, size to be determined by

percolation test. Carried out in accordance with BRE Digest 365

> Lintinique Cult ACCESS IND TURNING

static

van

remo

Plot 03 1

existing structure cut back to create covered parking area







Contact

Birch Architects The Studio, Lambourne, Redlynch, Salisbury, Wiltshire, SP5 2NR t: (+44) 01725 510407

e: info@bircharchitects.co.uk

W: www.bircharchitects.co.uk

.....