DRAWING N°: BSC.718 000 Rev:

EMERGENCY LIGHTING TO COMPLY WITH BS 5266-1 2016. ELECTRICS TO COMPLY WITH BS 7671 2018. GLAZING TO COMPLY WITH BS 6262-2 2005. FIRE DETECTION TO BS 5839 2019 - L2

HAVE AN UP TO DATE "APPROVED" CERTIFICATION.

ALL M+E SERVICES/SYSTEMS INCLUDING (BUT NOT RESTRICTED TO) SMOKE & HEAT DETECTORS, BREAK GLASS, SOUNDERS, EMERGENCY LIGHTING, VOID/CEILING DETECTION, SPRINKLERS AND LED VOID INDICATORS ARE TO BE DESIGNED BY OTHERS AND TO BE INSTALLED IN ACCORDANCE WITH THE RELEVANT BRITISH STANDARDS. THE ELECTRICAL AND FIRE ALARM CONTRACT IS TO BE LET ON A DESIGN AND BUILD BASIS. CONTRACTORS UNDERTAKING ELECTRICAL WORK, MUST BE NIC FIC REGISTERED WITH "APPROVED" STATUS, AND TO BE CONVERSANT WITH THE IEE REGULATIONS 18TH EDITION AND BS 7671. CONTRACTORS WILL BE REQUIRED TO DEMONSTRATE THAT THEY HAVE AN UP TO DATE "APPROVED" CERTIFICATION.

GENERAL BUILDING CONTROL NOTES:



CLIENT CONILON LTD



PROJECT 423 STRAND, LONDON WC2R 0QE

DRAWING TITLE LOCATION AND BLOCK PLAN

PROJECT ID.	DRAWN BY
BSC.718	JMO
SCALE @ A1	DATE
1:25 @ A1	08/22
DRAWING NO.	REVISION
000	

REV DESCRIPTION

DATE

KITCHEN WASTES: 38MM DIAMETER BASIN WASTES: 32 MM DIA. UP TO 1.7 M WC WASTES: 110 MM DIA. UP TO 6 M MAX SINK WASTES: 40MM DIA. UP TO 3 M

ELECTRICAL NOTES: ELECTRICAL FIXTURES

EMERGENCY LIGHTING

OUTLETS AND CONTROLS OF ELECTRICAL FIXTURES AND SYSTEMS SHOULD BE POSITIONED AT LEAST 350MM FROM ANY INTERNAL CORNER, PROJECTING WALL OR SIMILAR OBSTRUCTION AND, UNLESS THE NEED FOR A HIGHER LOCATION CAN BE DEMONSTRATED, NOT MORE THAN 1.2M ABOVE FLOOR LEVEL. THIS WOULD INCLUDE FIXTURES SUCH AS SOCKETS, SWITCHES, FIRE ALARM CALL POINTS AND TIMER CONTROLS OR PROGRAMMERS.

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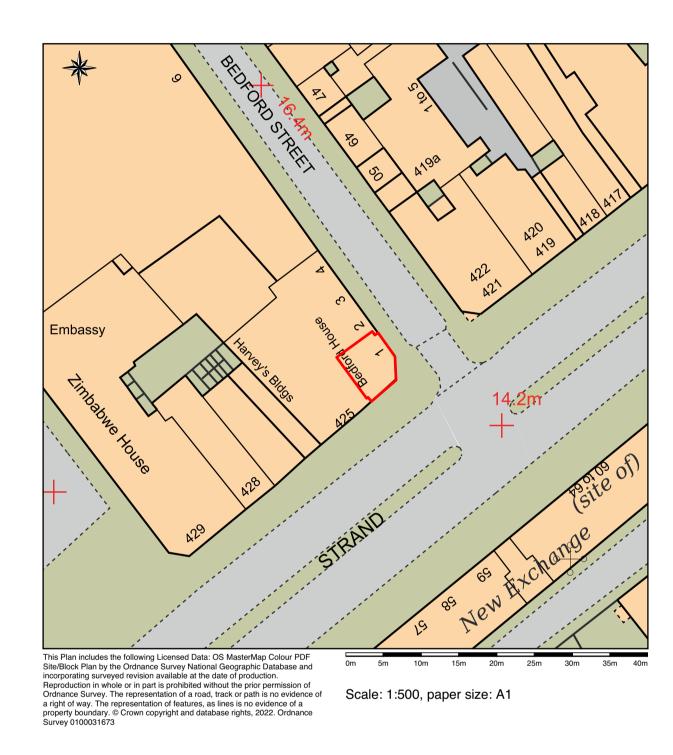
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SURFACE FINISHES TO WALLS AND CEILINGS TO MEET BUILDING CONTROL OFFICERS MINIMUM SURFACE SPREAD OF FLAME REQUIREMENTS, TYPICALLY:

SMALL ROOMS UNDER 30M2: D-S3,D2 OTHER ROOMS: C-S3,D2 CIRCULATION SPACES: B-S3,D2





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AIR CONDITIONING AND AUDIO SYSTEMS TO SHUT DOWN UPON ACTIVATION OF FIRE ALARM

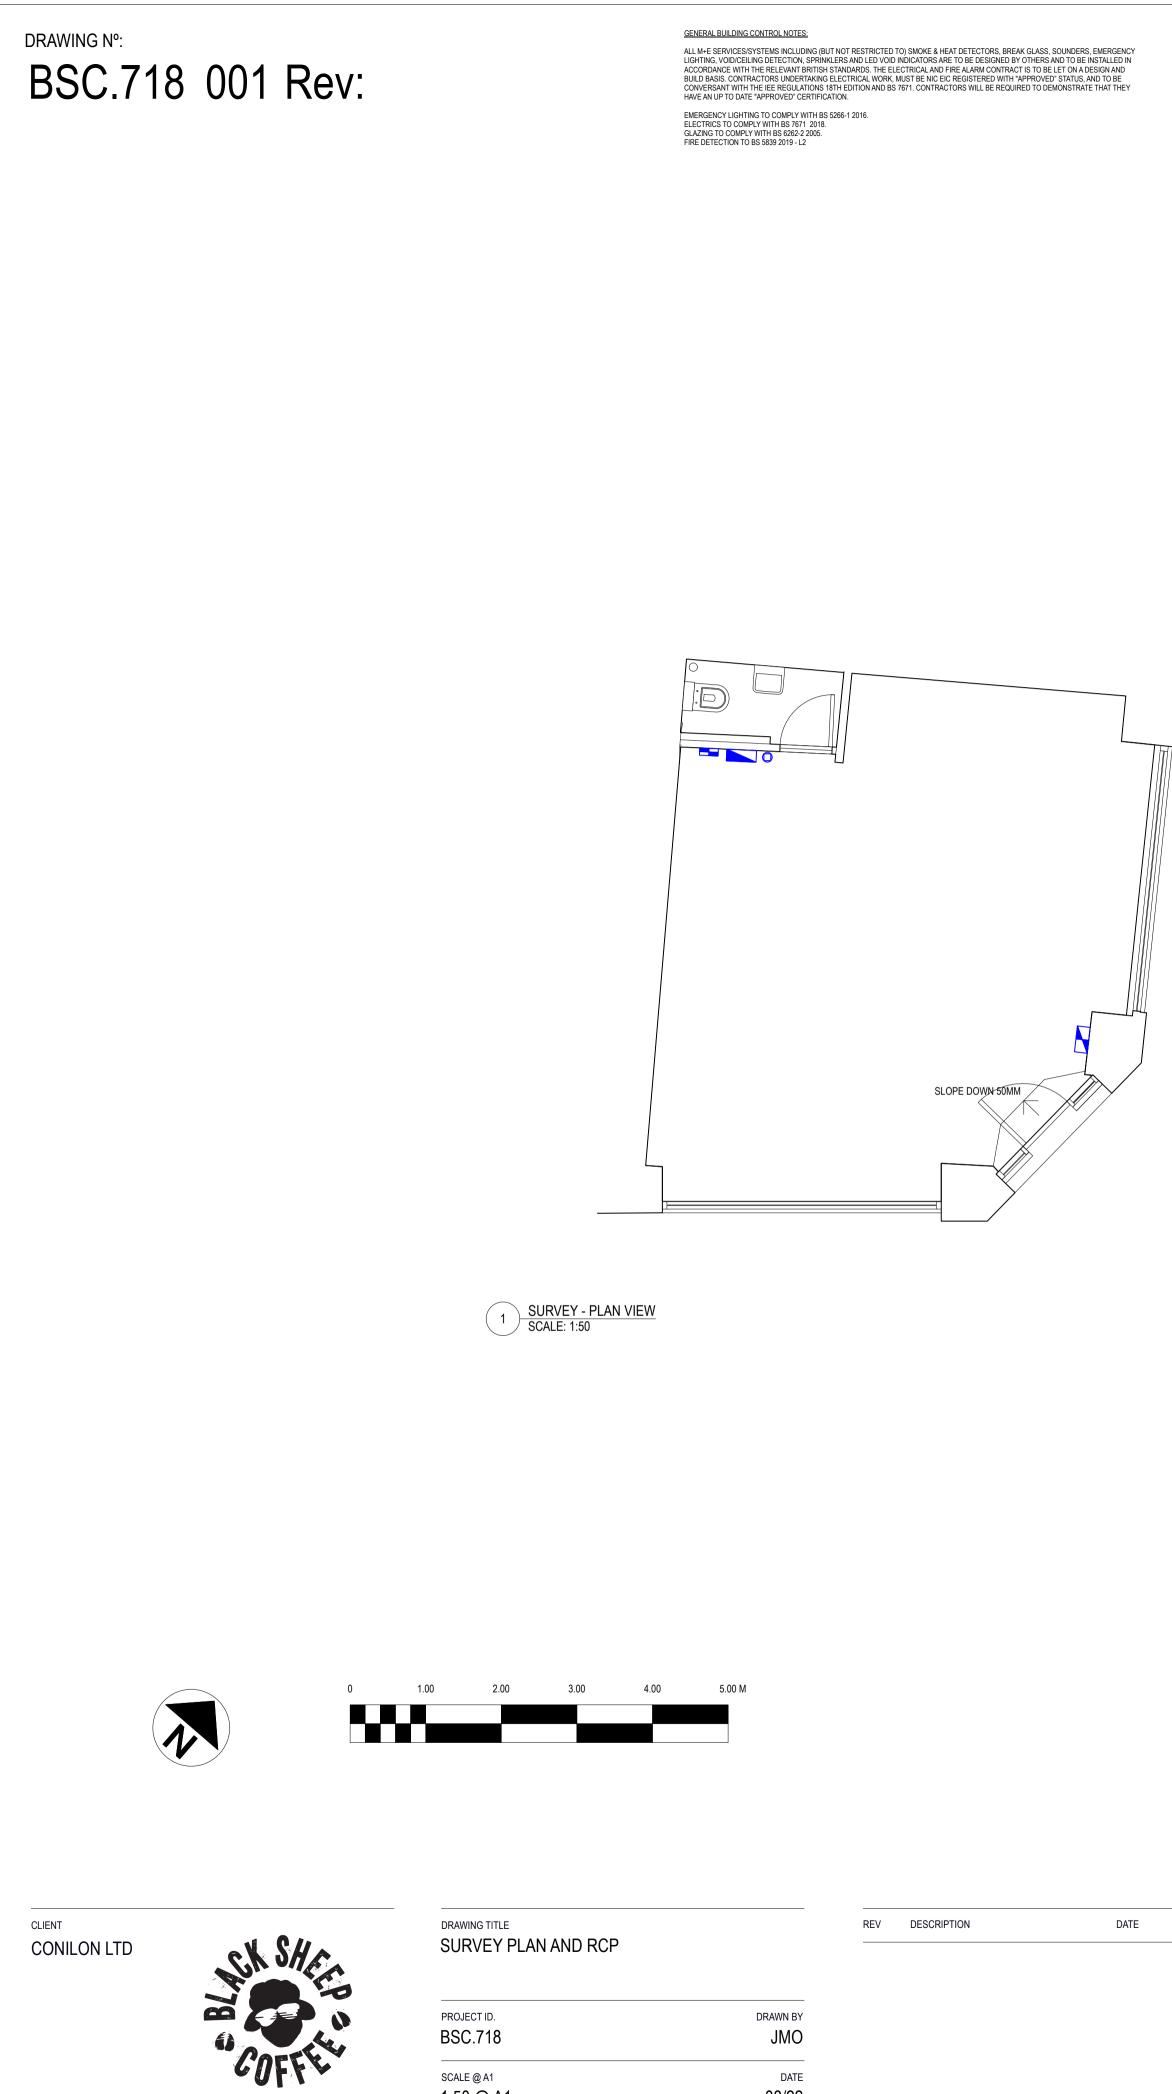
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1:50 @ A1 08/22 DRAWING NO. REVISION 001 ____

ALL PIPEWORK TO COMPLY WITH CURRENT LU, BUILDING REGS AND APPLICABLE BRITISH STANDARDS

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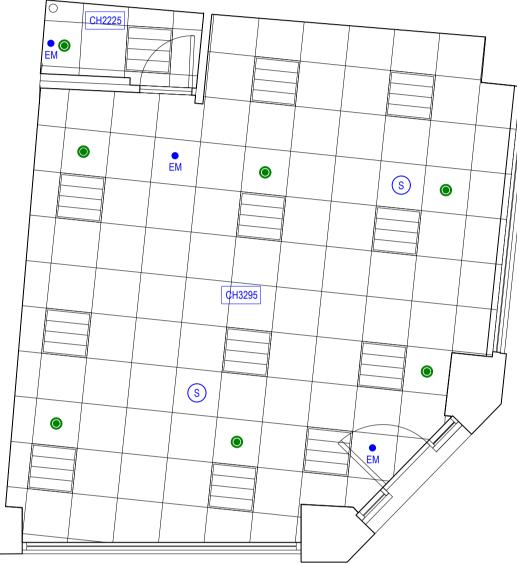
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1 SURVEY - RCP SCALE: 1:50

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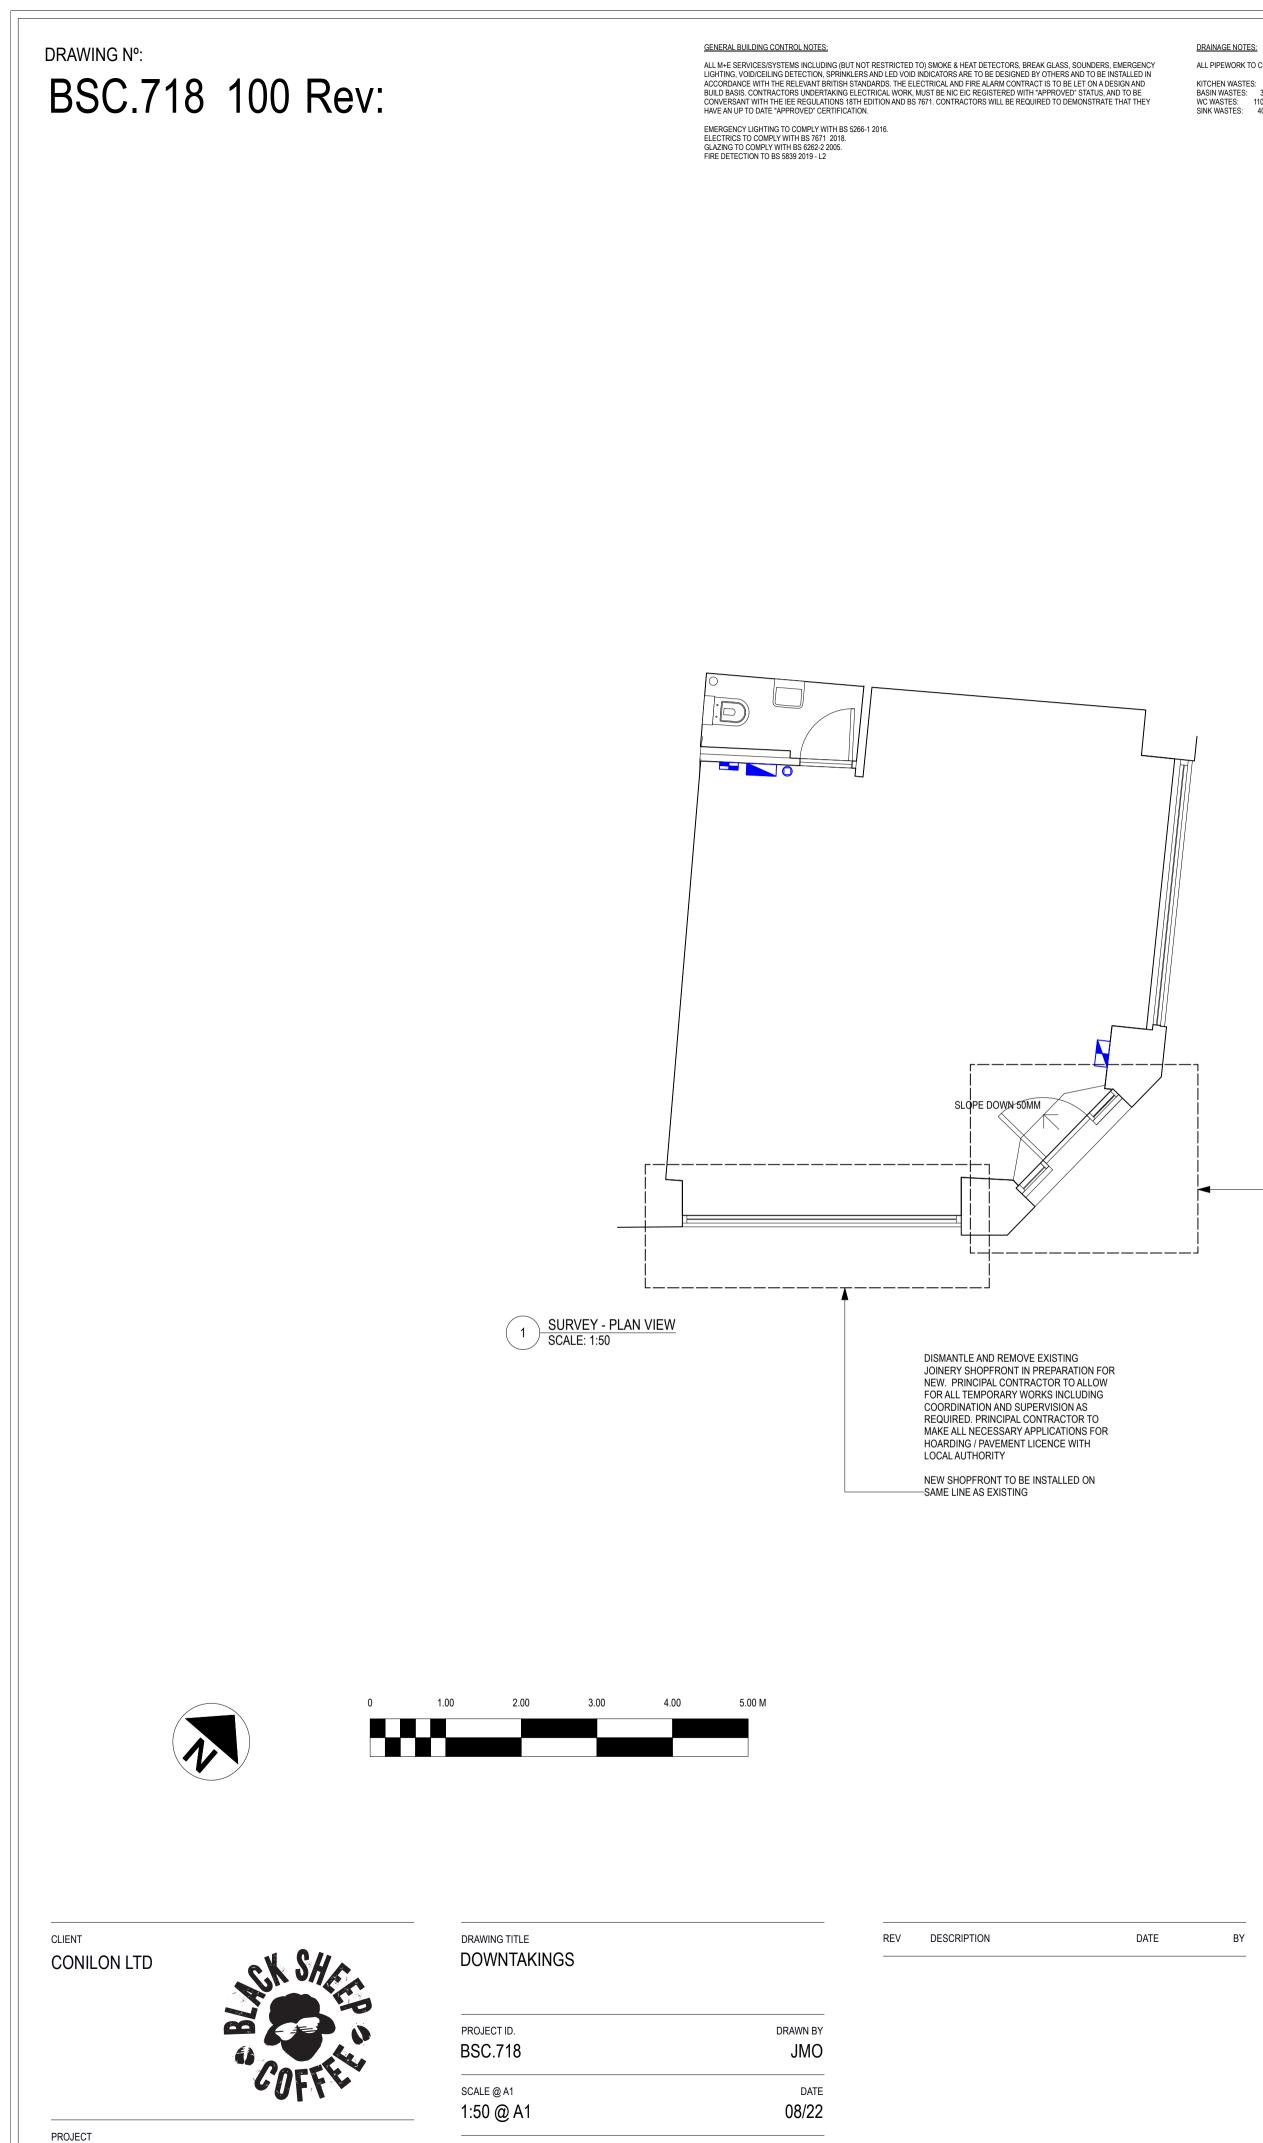
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423 STRAND, LONDON WC2R 0QE

100 ____

DRAWING NO.

REVISION

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DISMANTLE AND REMOVE EXISTING JOINERY SHOPFRONT AND SECURITY SHUTTER IN PREPARATION FOR NEW. PRINCIPAL CONTRACTOR TO ALLOW FOR ALL TEMPORARY WORKS INCLUDING COORDINATION AND SUPERVISION AS REQUIRED. PRINCIPAL CONTRACTOR TO MAKE ALL NECESSARY APPLICATIONS FOR HOARDING / PAVEMENT LICENCE WITH LOCAL AUTHORITY. NEW SHOPFRONT TO BE SET 50MM IN FROM

EXISTING FACADE CLADDING TO PROVIDE

-MAXIMUM SPACE INTERNALLY.

1 SURVEY - RCP SCALE: 1:50

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EXISTING SUSPENDED CEILING TO BE DISMANTLED TO ALLOW FOR INSTALLATION OF NEW FULL HEIGHT PARTITIONS. PC TO ALLOW FOR REINSTATEMENT OF NEW MF CEILING TO HEIGHT OF EXISTING TO MINIMISE WORKS TO EXISTING SPRINKLER SYSTEM. PC TO ALLOW FOR ALL ATTENDQNT WORKS NECESSARY BY SPRINKLER CONTRACTOES. LANDLORDS APPROVED/RETAINED SPRINKLER CONTRACTORS TO BE ADVISED. SUBJECT TO CONDITION OF SLAB AND SERVICES WITHIN CEILING VOID AN OPEN CEILING TO BE FRONT OF HOUSE MAY BE DESIRED BUT

-CONTRACTOR TO ALLOW FOR NEW MF CEILING IN TENDER RETURN.

DRAWING Nº: BSC.718 101 Rev:

GENERAL BUILDING CONTROL NOTES:

Black Sheep, Fleet Street

Standards

Internal covers ground floor:	0
Internal covers mezzanine level:	N/a
Internal covers total:	0
External covers:	0

Shop Areas

	Unit shell size ground floor:	40.5m ²		
	Unit shell size ground mezzanine:	0m ²		EXISTING WC
	Unit shell size total:	40.5m ²		EXISTING HAND WASH BASIN
	Retail area (incl.counter):	24.5m ²		EXISTING HAND WASH BASIN
(Ground floor internal seating area:	0m ²		WATER CYLINDER UPRIGHT FRIDGES AND FREEZER
	Mezzanine level seating area:	N/a		HIGH LEVEL BAKE OFF OVEN WITH CONDE
	Ground floor back of house area:	16m ²		
	Mezzanine back of house area:	N/a		STAINLESS STEE
	Fallow undeveloped areas:	N/a		
	Shopfront length:	9.0 m (3.7, 1.8 and 3.5)	
	External seating area:	None		
	Ge	neral	ELECTRICAL CUPBOARD	
		norai		
	Planning authority:	City of Westminster		
	Building Listing:	None		
	Conservation area:	No		
	Structural works:	No	STAFF LOCKERS-	
	Shopfront replacement:	No		
	Shophont replacement.	140		
			REAR COUNTER WITH DISPLAY SHELVES OVER	
			COFFEE AND DISPLAY COUNTER-	
			NEW SHOPFRONT WITH 180 DEGREE OPENING DOUBLE DOOR	
			SET	
				CONDIMENTS UNIT ON CASTERS
			GENERAL ARRA	NGEMENT PLAN - PROPOSED
			1 SCALE: 1:50	
			\smile	



CLIENT CONILON LTD



PROJECT 423 STRAND, LONDON WC2R 0QE

DRAWING TITLE PROPOSED GA AND BUILD PLAN

PROJECT ID.	DRAWN BY
BSC.718	JMO
SCALE @ A1	DATE
1:50 @ A1	08/22
DRAWING NO.	REVISION
101	

REV DESCRIPTION DATE

BY

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PROPOSED NEW ELECTRICS CUPBOARD TO BE LINED WITH 2NO.-LAYERS OF 12.5MM PLASTERBOARD TO ACHIEVE MINIMUM 30 MINUTE FIRE PROTECTED ENCLOSURE. JOINTS AND PENETRATIONS SEALED WITH ROOKWOOL FIREPRO HIGH EXPANSION INTUMESCENT SEALANT OR SIMILAR SUITABLE ALTERNATIVE. NO PROPOSED CEILING OR WALL OR FLOOR FINISHES. PRINCIPAL CONTRACTOR TO LIAISE WITH ELECTRICAL CONTRACTOR TO ENSURE ADEQUATELY SIZED TO PROVIDE CLEARANCE/ACCESS TO CONSUMER BOARD AND ANCILLARY NDENSATE HOOD OVER ITEMS 3635 STEEL PREP TABLE 1000MM FR30 DOUBLE DOOR SET TO ELECTRICAL CUPBOARD-SET 150MM FROM FLOOR LEVEL TO ALLOW FOR COVED SKIRTING NEW 727 X 2040 SOLID PANEL BLANK DOOR WITH STAINLESS-PULL HANDLE, FINGER PLATE, DOOR CLOSER AND KICK PLATES DRAINER. SPACE BELOW TO ACCOMODATE DISHWASH - HOBART ECOMAX NEW FULL HEIGHT PARTITIONS TO STANDARD BRITISH GYSPUM-ECO+F5155W-10C WHITE BOOK DETAIL DETAIL. IN PREPAREA FIX ADDITIONAL LYER 4550 800 OF 12MM PLY TO C-STUD PRIOR TO OVERBOARDING WITH 12.5MM PLASTERBOARD TO ALLOW FOR FIXING OF WALL SHELVES AND THE LIKE CH3295 ------LOW LEVEL JOINERY CUPBOARDS IN BLACK LAMINATE OVER WP HDF CARCASSES. PATINATED ZINC TOP. BACK FULLY FINISHED AS VISIBLE FORM EXTERIOR COFFEE PASS UNIT ON CASTERS 879 1652 879 NEW ALUMNIUM FRAMED SHOPFRONT WITH 180 DEGREE HINGED DOUBLE DOOR SET. CLEAR GLAZING TO FLANKING WINDOWS. FINISH IN RAL 7016 ANTHRACITE GREY SATIN POWDERCOAT. 2 BUILDERS WORKS PLAN SCALE: 1:50 PRINCIPAL CONTRACTOR TO PROVIDE DETAIL JOININGS FOR CLIENT APPROVAL PRIOR TO FABRICATION. DOORS TO BE FITTED -WITH DEADLOCKS AND HOLD BACKS FOR OPEN POSITIONS

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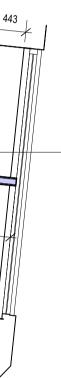
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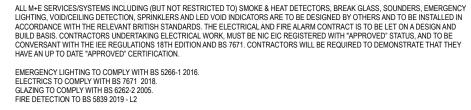


ANY WORKS REQUIRED TO EXISTING SPRINKLER SYSTEM TO BE -ADVISED BY SPECIALIST CONTRACTOR

NEW ALUMNIUM FRAMED SHOPFRONT WITH CLEAR GLAZING. FINISH IN RAL 7016 ANTHRACITE GREY SATIN POWDERCOAT. NEW SHOPFRONT TO BE RECESSED 50MM APPROX TO REVEAL SUBJECT TO STRIP OUT OF EXISTING TO MAIXIMISE INTERNAL -SPACE



DRAWING N°: BSC.718 102 Rev:



GENERAL BUILDING CONTROL NOTES:

Power Legend

Small Power

	Main electrical distribution board. Board located within standard metal enclosure with hinged door. Electric meter positioned in accessible location
	Incoming electric mains head. 100amp TP-N supply by landlord
0	Electrical meter.
D	Single switched socket outlet, number indicates height in mm above FFL to centre of outlet (13amp unless otherwise stated)
ß	Double switched socket outlet, number indicates height in mm above FFL to centre of outlet (13amp unless otherwise stated)
USB	Double switched socket outlet with integrated USB ports, number indicates height in mm above FFL to centre of outlet (13amp unless otherwise stated).
D+ FS	Fused spur outlet, number indicates height in mm above FFL to centre of socket (13amp unless otherwise stated)
D+ WPFS	Water proof fused spur outlet, number indicates height in mm above FFL to centre of socket (13amp unless otherwise stated)
P	IP65 Isolator switch, surface mounted. Number indicates height in mm above FFL to centre of socket
$\frac{32}{3}$	Commando socket with isloator switch adjacent, number indicates power over number of phases and height in mm above FFL to centre of socket respectively
•	5amp power supply for signage and feature lighting
	AC Controls
	Last Person Out switch, located adjacent to final exit

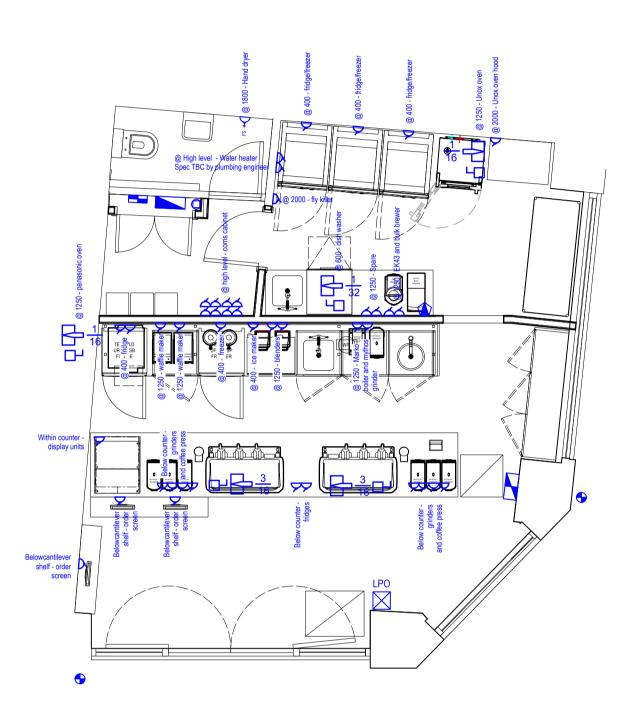
PLEASE NOTE:

equipment schedule.

Additional power required for Specialist HVAC Contractors installation. Refer to HVAC Designers details and drawings for requirements. Power to equipment assumes standard Black Sheep Coffee appliances - to be checked against site's

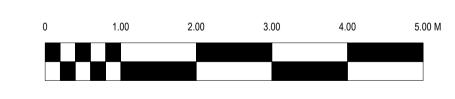
PROJECT NOTE:

EXISTING POWER SUPPLY IS 100A SINGLE PHASE AND UPGRADE IS REQUIRED TO 100A THREE PHASE.



1 PLAN VIEW - SMALL POWER SCALE: 1:50





CLIENT CONILON LTD



PROJECT 423 STRAND, LONDON WC2R 0QE

DRAWING TITLE SMALL POWER AND DATA, CCTV AND MUSIC PLANS

PROJECT ID.	DRAWN BY
BSC.718	JMO
SCALE @ A1	DATE
1:50 @ A1	08/22
DRAWING NO.	REVISION
102	

REV DESCRIPTION DATE

ALL PIPEWORK TO COMPLY WITH CURRENT LU, BUILDING REGS AND APPLICABLE BRITISH STANDARDS KITCHEN WASTES: 38MM DIAMETER BASIN WASTES: 32 MM DIA. UP TO 1.7 M WC WASTES: 110 MM DIA. UP TO 6 M MAX SINK WASTES: 40MM DIA. UP TO 3 M

DRAINAGE NOTES:

ELECTRICAL NOTES: ELECTRICAL FIXTURES

OUTLETS AND CONTROLS OF ELECTRICAL FIXTURES AND SYSTEMS SHOULD BE POSITIONED AT LEAST 350MM FROM ANY INTERNAL CORNER, PROJECTING WALL OR SIMILAR OBSTRUCTION AND, UNLESS THE NEED FOR A HIGHER LOCATION CAN BE DEMONSTRATED, NOT MORE THAN 1.2M ABOVE FLOOR LEVEL. THIS WOULD INCLUDE FIXTURES SUCH AS SOCKETS, SWITCHES, FIRE ALARM CALL POINTS AND TIMER CONTROLS OR PROGRAMMERS.

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FIRE NOTES:

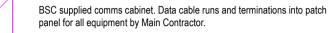
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Data, CCTV and Music

Data

- RJ 45 data socket, number indicates socket no. /D\
- RJ 45 data socket. Wifi repeater ceiling mounted
- RJ 45 data socket. Telephone socket ΔT

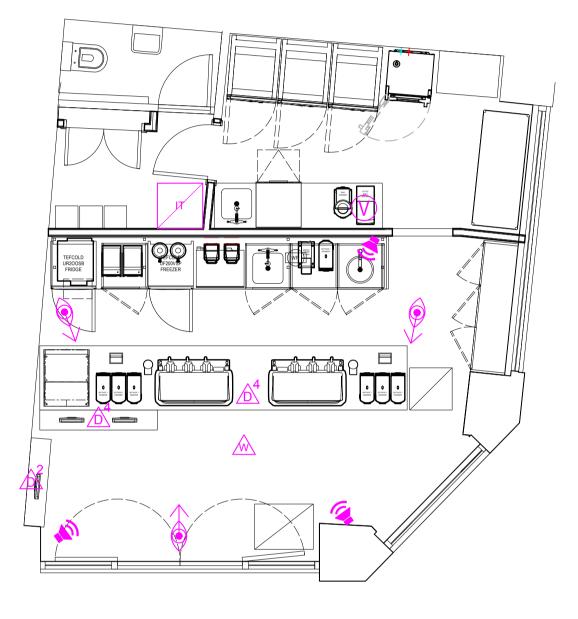




RJ 45 data socket. CCTV camera. BSC supplied CCTV Camera. HIK Vision 8MP dome camera, black finish. Ref: DS-2CD2186G2-ISU.

BSC supplied Cafe Speakers. Ref: APart OVO8 speakers in black finish mounted at high level to walls. Cables to be free issued and run from high level to data cabinet with 1m slack at each end by main contractor. No termination required.

- Volume Control RJ 45 data socket. BSC supplied volume control. 1no. data cable to be run by Main Contractor. Termination by Specialist Contractor
- (CH) Chargit wireless phone charges set in to counter surface



2 PLAN VIEW - DATA, MUSIC AND CCTV SCALE: 1:50

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DRAWING N°: BSC.718 103 Rev:

ALL M+E SERVICES/SYSTEMS INCLUDING (BUT NOT RESTRICTED TO) SMOKE & HEAT DETECTORS, BREAK GLASS, SOUNDERS, EMERGENCY

GENERAL BUILDING CONTROL NOTES:

Plumbing and Drainage Legend

Plumbing and drainage routes

	Hot water feed from wall mounted water heater
	Cold water feed from incoming water supply
	Drainage route
•	Hot water feed connection point

Cold water feed connection point

Drainage connection point

Note:

All supplies are to be run in soldered copper. Final routes of all pipework to be agreed on site with contractor. Waste pipework to be run in rigid PVC. Allow for copper tundish and section of copper waste to serve oven waste connection due to high temperature output on cleaning cycle

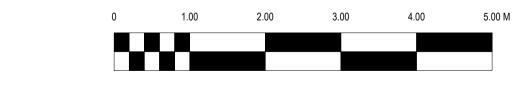
- 1 Hand wash: Hot and cold water feed and drainage connection to sink basin
- 2 WC: Cold wa Cold water feed and drainage connection
- (3) Wash sink: Hot and cold water feed and drainage connection to sink basin
- 4 Ice machine cube: Cold water feed required. Installed to manufacturers specifications
- 5 Britta Water Filter:
- Cold water feed
- Coffee machine: (6) Cold water feed and drainage connection required. Installed to manufacturers specification. Connection via Britta water filter.
- Filter Coffee machine: (7) Cold water feed required. Installed to manufacturers specifications. Connection via Britta water filter.
- Water boiler:
- (8) Cold water feed required. Installed to manufacturers specifications Connection via Britta water filter.
- Jet Rinser & Drip Tray: 9 Jet Rinser & Drip Tray: Hot water feed and drainage connection required. Installed to manufacturers specifications
- (10) Water heater: Cold water feed and over pressure tundish drainage connection required.
- Installed to manufacturers specification Dish washer: Cold water feed required. Installed to manufacturers specifications Dish washer:
- Bake off oven:
- (12) Cold water feed and tundish drainage connection. Installed to manufacturers specification

V

- Coffee Grounds Trap: (13) In line grounds trap - Coffee Guardian ST2
- 14 Existing SVP: Height from floor to be verified

CYLINDER MOUNTED ON GALLOWS 2 (1)(3) BRACKETS AT HIGH LEVEL. PLUMBING CONTRACTOR TO SIZE TANK AND ADVISE ON LOCATION. (10)(11)14— Ē 55 (6) (6)





CLIENT CONILON LTD



PROJECT 423 STRAND, LONDON WC2R 0QE

DRAWING TITLE PLUMBING AND DRAINAGE PLAN

drawn JM	PROJECT ID. BSC.718
DA	SCALE @ A1
08/2	1:50 @ A1
REVISI	DRAWING NO.
	103

REV DESCRIPTION DATE DRAINAGE NOTES: ALL PIPEWORK TO COMPLY WITH CURRENT LU, BUILDING REGS AND APPLICABLE BRITISH STANDARDS

KITCHEN WASTES: 38MM DIAMETER BASIN WASTES: 32 MM DIA. UP TO 1.7 M WC WASTES: 110 MM DIA. UP TO 6 M MAX SINK WASTES: 40MM DIA. UP TO 3 M

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BY

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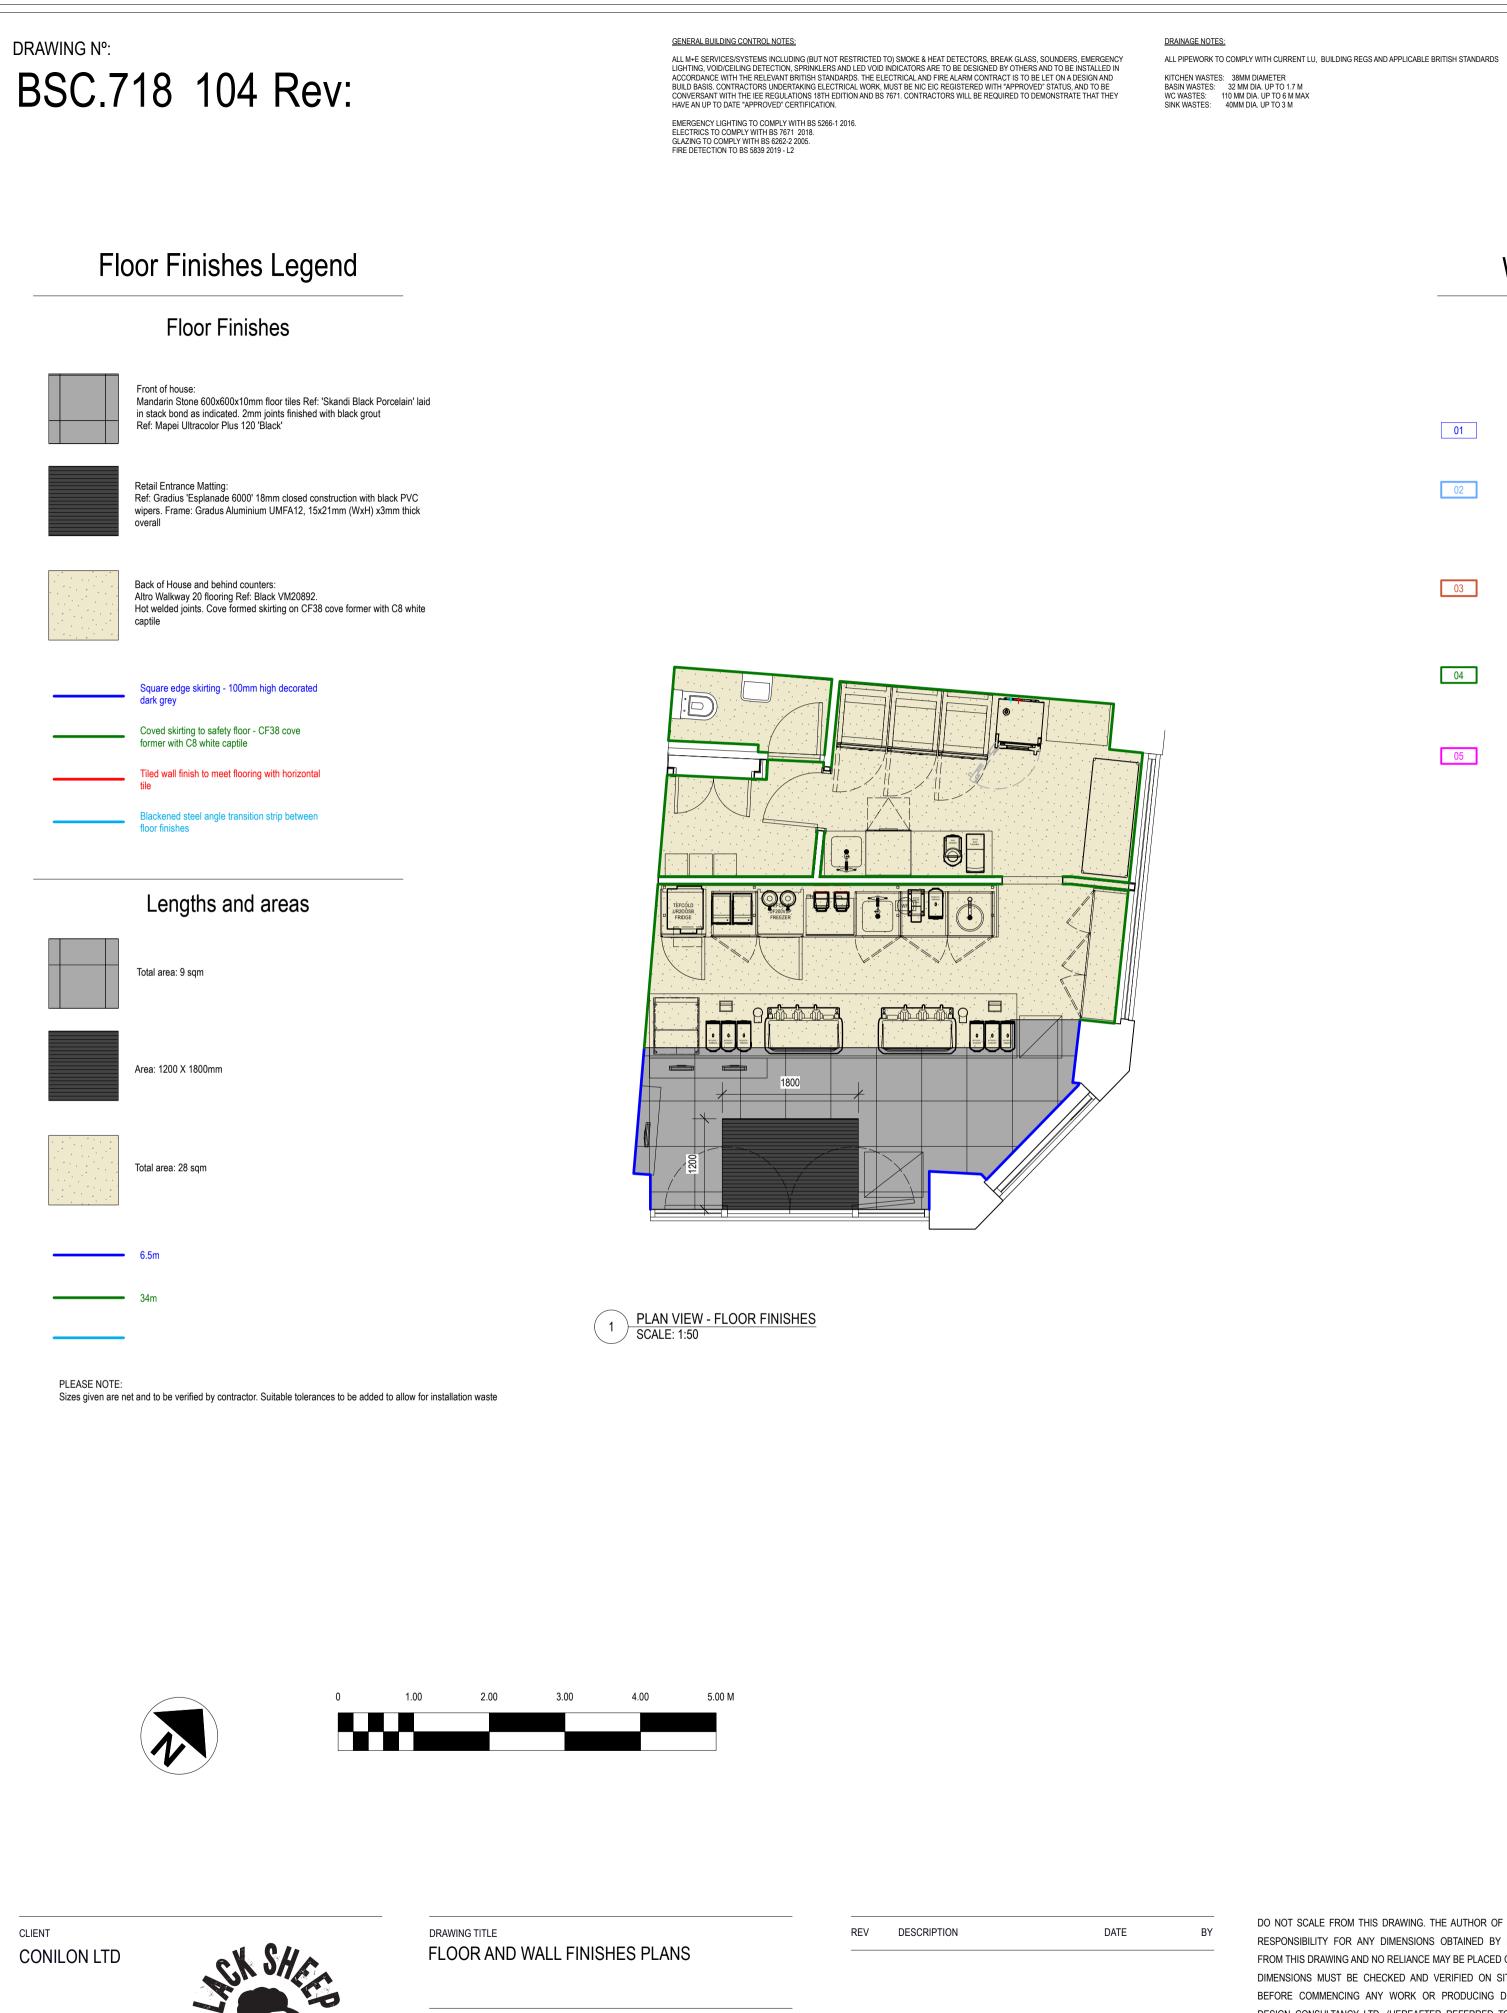
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PROJECT ID. BSC.718 SCALE @ A1 1:50 @ A1 DRAWING NO. 104

PROJECT 423 STRAND, LONDON WC2R 0QE DRAWN BY

JMO

DATE

08/22

REVISION

ELECTRICAL NOTES: ELECTRICAL FIXTURES

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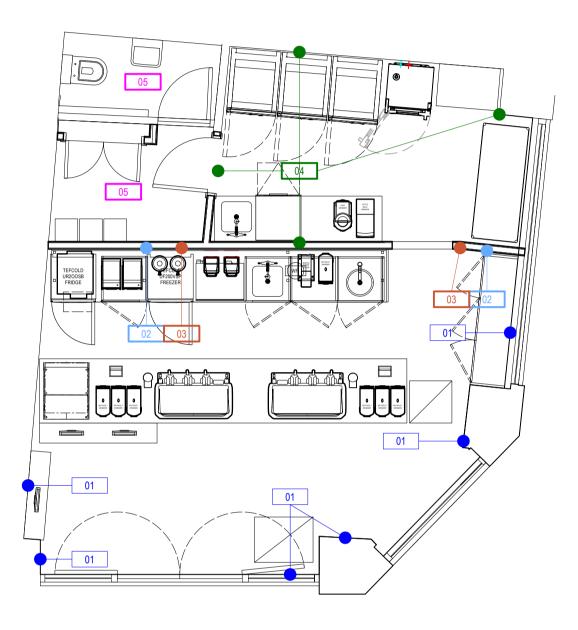
Wall Finishes Legend

Wall Finishes

- Decorate existing walls/new partitions Dulux 'Night Jewels 4' 00NN 37/000 01 diamond matt. Durafinish plaster with clear matt sealer - Ronseal Quick Dry Interior Varnish 02

or similar.

- Matt white wall tiles laid in stack bond from counter splashback to circa 1500mm above FFL (5 no. full tiles above counter splashback) Ref. 14916 'Matt White 100x100 Wall Tiles' by Walls and Floors. 97x97x6mm. 03 Antibacterial grout Ref: Anthracite Grey. Tiles to be installed roughly with over-grout not fully cleaned to provide DIY effect. Finish 02 above.
- Hygienic wall cladding in white finish, full board height with finish 05 to ceiling 04 above. 150mm cove formed Altro skirting.
- Decorate existing blockwork/new partitions Dulux 'Pure Brilliant White' 05 durable silk or similar approved.



FIRE NOTES:

SMALL ROOMS UNDER 30M2: D-S3,D2 OTHER ROOMS: C-S3,D2 CIRCULATION SPACES: B-S3,D2

1 PLAN VIEW - WALL FINISHES SCALE: 1:50

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AIR CONDITIONING AND AUDIO SYSTEMS TO SHUT DOWN UPON ACTIVATION OF FIRE ALARM

SURFACE FINISHES TO WALLS AND CEILINGS TO MEET BUILDING CONTROL OFFICERS MINIMUM SURFACE SPREAD OF FLAME REQUIREMENTS, TYPICALLY:

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drawing №: BSC.718 105 Rev	7 • •	LIGHTING, VOID/CEILING DETECTION, SPRINKLERS ACCORDANCE WITH THE RELEVANT BRITISH STAN BUILD BASIS. CONTRACTORS UNDERTAKING ELEC		DRAINAGE NOTES: ALL PIPEWORK TO COM KITCHEN WASTES: 380 BASIN WASTES: 32 M WC WASTES: 110 MM SINK WASTES: 40MM
Fire Safety Legend Fire Legend Manual call point - height TBC on site. To have fire action assembly point drawing provided in close proximity Image: Colspan="2">Fire alarm panel with red key switched fused spur to BS 5 Image: Colspan="2">Garbon dioxide fire extinguisher Image: FE FOAM Foam fire extinguisher				
PROJECT NOTE: Final position of fire extinguishers to be determined on site in conjunction with Spe of house extinguishers to be finished in chrome.	cialist Contractor. Front			
Sounder base Sounder base <td></td> <td>I PLAN VIEW - FIRE</td> <td></td> <td></td>		I PLAN VIEW - FIRE		
CLIENT CONILON LTD	0 1.00 2.00 3.00		REV DESCRIPTION DATE	BY
COLLER COLLER	PROJECT ID. BSC.718 SCALE @ A1	DRAWN BY		
PROJECT 423 STRAND, LONDON WC2R 0QE	SCALE @ A1 1:50 @ A1 DRAWING NO. 105	DATE 08/22 REVISION		

105 _____

ALL PIPEWORK TO COMPLY WITH CURRENT LU, BUILDING REGS AND APPLICABLE BRITISH STANDARDS KITCHEN WASTES: 38MM DIAMETER BASIN WASTES: 32 MM DIA. UP TO 1.7 M WC WASTES: 110 MM DIA. UP TO 6 M MAX SINK WASTES: 40MM DIA. UP TO 3 M

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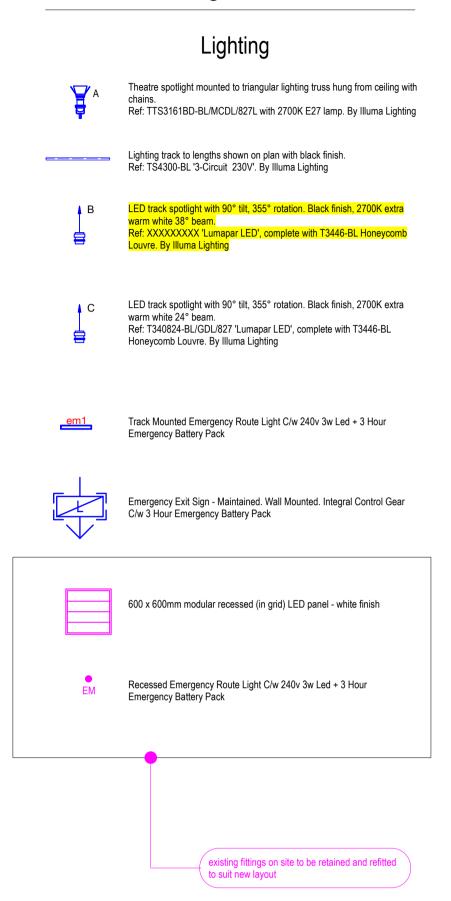
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SURFACE FINISHES TO WALLS AND CEILINGS TO MEET BUILDING CONTROL OFFICERS MINIMUM SURFACE SPREAD OF FLAME REQUIREMENTS, TYPICALLY: SMALL ROOMS UNDER 30M2: D-S3,D2 OTHER ROOMS: C-S3,D2 CIRCULATION SPACES: B-S3,D2

Ceiling Services





2 RCP - CEILING SERVICES SCALE: 1:50

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FIRE DETECTION TO BE INSTALLED AND TESTED TO THE LATEST VERSION OF TO BS5839 PART 1 'FIRE DETECTION AND ALARM SYSTEMS IN BUILDINGS'. FINAL DESIGN BY SPECIALIST CONTRACTOR TO CATEGORY L2.

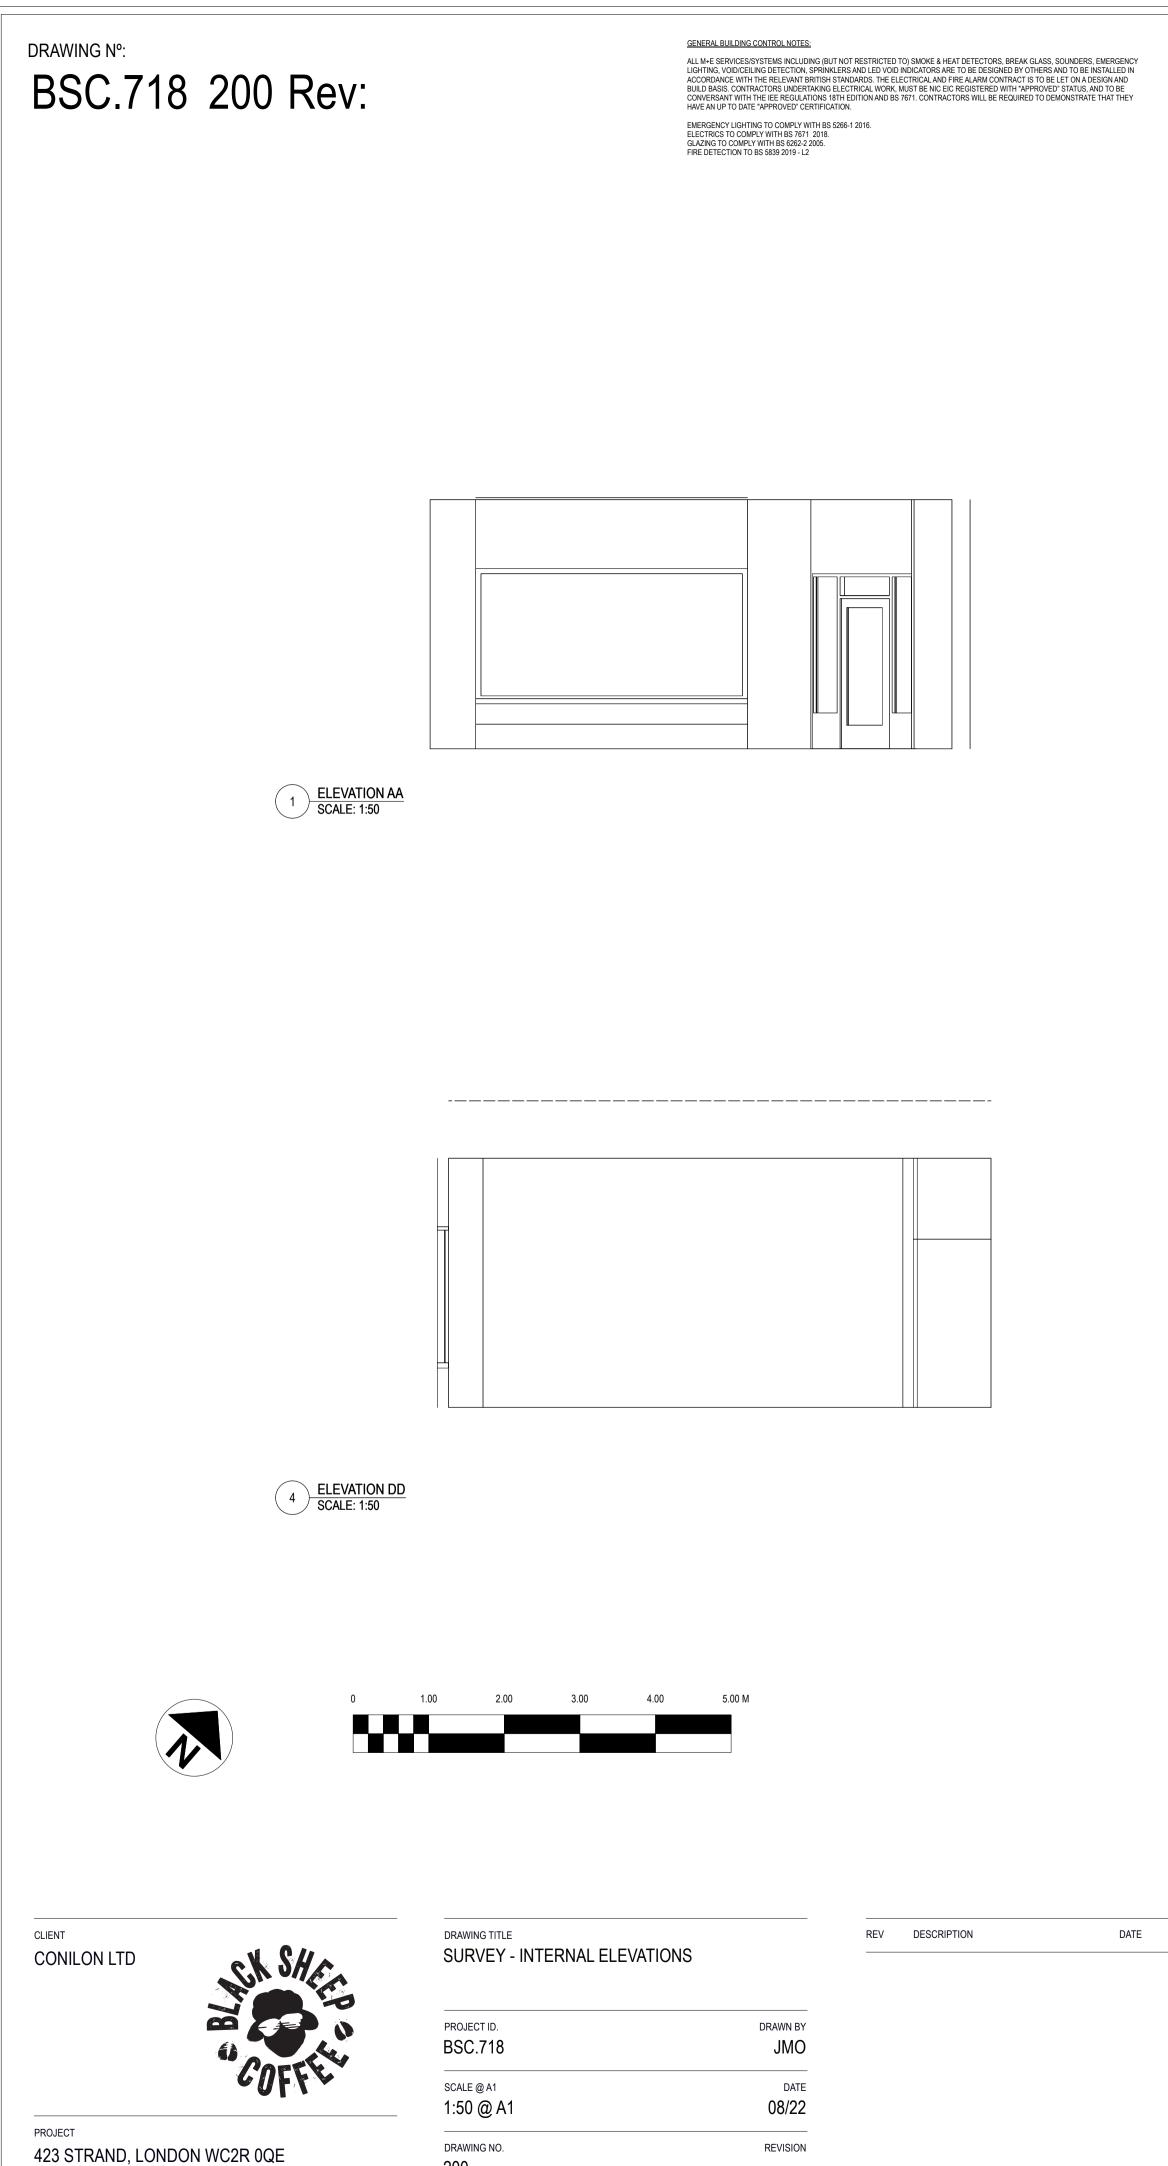
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200

DRAINAGE NOTES:

KITCHEN WASTES: 38MM DIAMETER BASIN WASTES: 32 MM DIA. UP TO 1.7 M WC WASTES: 110 MM DIA. UP TO 6 M MAX SINK WASTES: 40MM DIA. UP TO 3 M

ELECTRICAL NOTES: ELECTRICAL FIXTURES

OUTLETS AND CONTROLS OF ELECTRICAL FIXTURES AND SYSTEMS SHOULD BE POSITIONED AT LEAST 350MM FROM ANY INTERNAL CORNER, PROJECTING WALL OR SIMILAR OBSTRUCTION AND, UNLESS THE NEED FOR A HIGHER LOCATION CAN BE DEMONSTRATED, NOT MORE THAN 1.2M ABOVE FLOOR LEVEL. THIS WOULD INCLUDE FIXTURES SUCH AS SOCKETS, SWITCHES, FIRE ALARM CALL POINTS AND TIMER CONTROLS OR PROGRAMMERS.

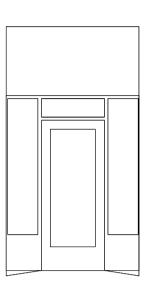
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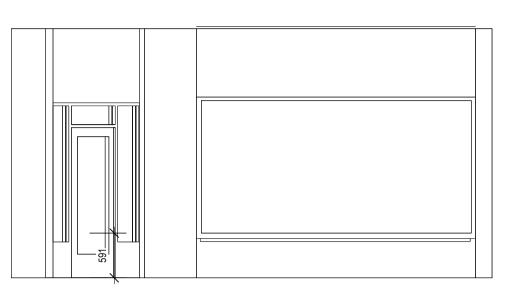
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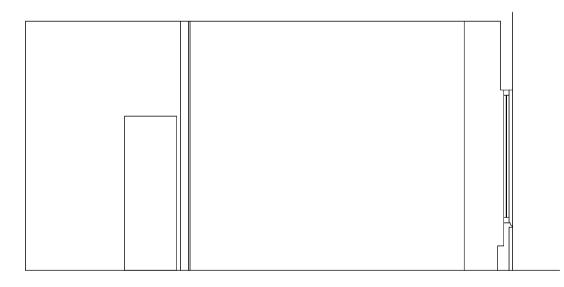
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2 ELEVATION BB SCALE: 1:50

3 ELEVATION CC SCALE: 1:50

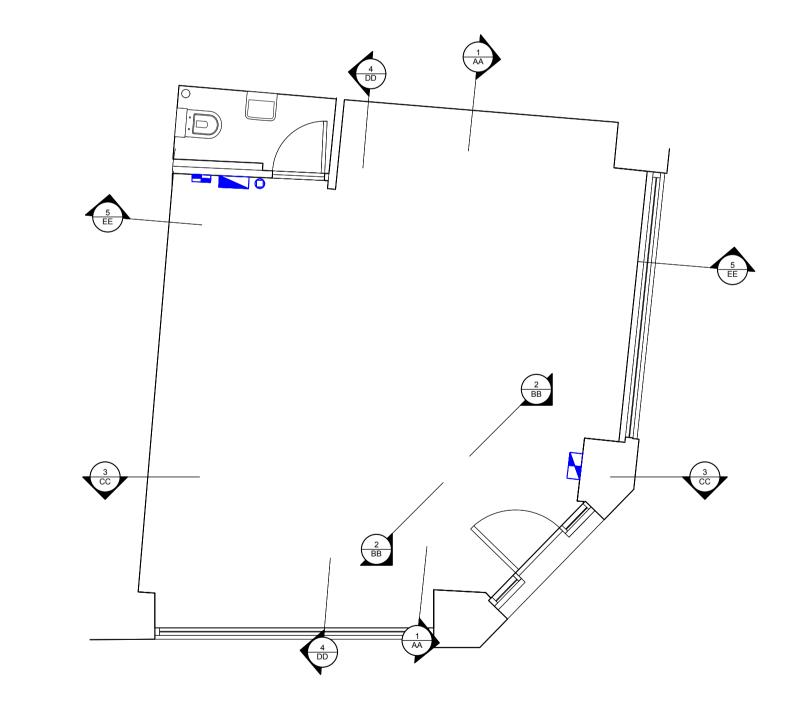


5 ELEVATION EE SCALE: 1:50



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DRAWING N°: BSC.718 201 Rev:

EMERGENCY LIGHTING TO COMPLY WITH BS 5266-1 2016. ELECTRICS TO COMPLY WITH BS 7671 2018. GLAZING TO COMPLY WITH BS 6262-2 2005. FIRE DETECTION TO BS 5839 2019 - L2

ALL M+E SERVICES/SYSTEMS INCLUDING (BUT NOT RESTRICTED TO) SMOKE & HEAT DETECTORS, BREAK GLASS, SOUNDERS, EMERGENCY LIGHTING, VOID/CEILING DETECTION, SPRINKLERS AND LED VOID INDICATORS ARE TO BE DESIGNED BY OTHERS AND TO BE INSTALLED IN ACCORDANCE WITH THE RELEVANT BRITISH STANDARDS. THE ELECTRICAL AND FIRE ALARM CONTRACT IS TO BE LET ON A DESIGN AND BUILD BASIS. CONTRACTORS UNDERTAKING ELECTRICAL WORK, MUST BE NIC EIC REGISTERED WITH "APPROVED" STATUS, AND TO BE CONVERSANT WITH THE REGULATIONS 18TH EDITION AND BS 7671. CONTRACTORS WILL BE REQUIRED TO DEMONSTRATE THAT THEY HAVE AN UP TO DATE "APPROVED" CERTIFICATION.

GENERAL BUILDING CONTROL NOTES:

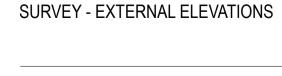
SLOPE DOWN 50MM

1 SURVEY - PLAN VIEW SCALE: 1:50

CLIENT CONILON LTD



PROJECT 423 STRAND, LONDON WC2R 0QE



DRAWING TITLE

PROJECT ID.	DRAWN BY
BSC.718	JMO
SCALE @ A1	DATE
1:50 @ A1	08/22
DRAWING NO.	REVISION
201	

REV DESCRIPTION DATE ALL PIPEWORK TO COMPLY WITH CURRENT LU, BUILDING REGS AND APPLICABLE BRITISH STANDARDS

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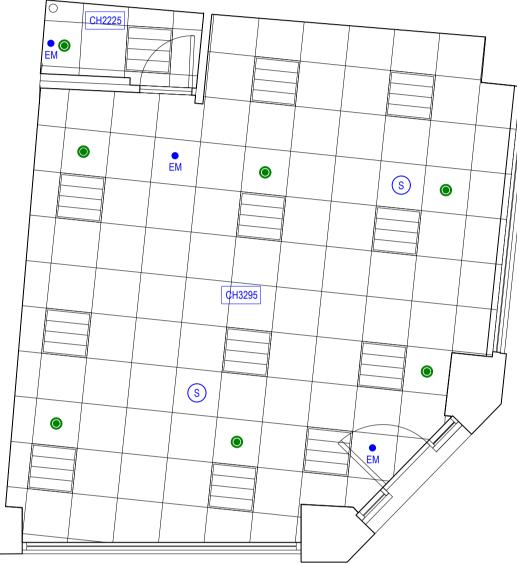
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1 SURVEY - RCP SCALE: 1:50

BY

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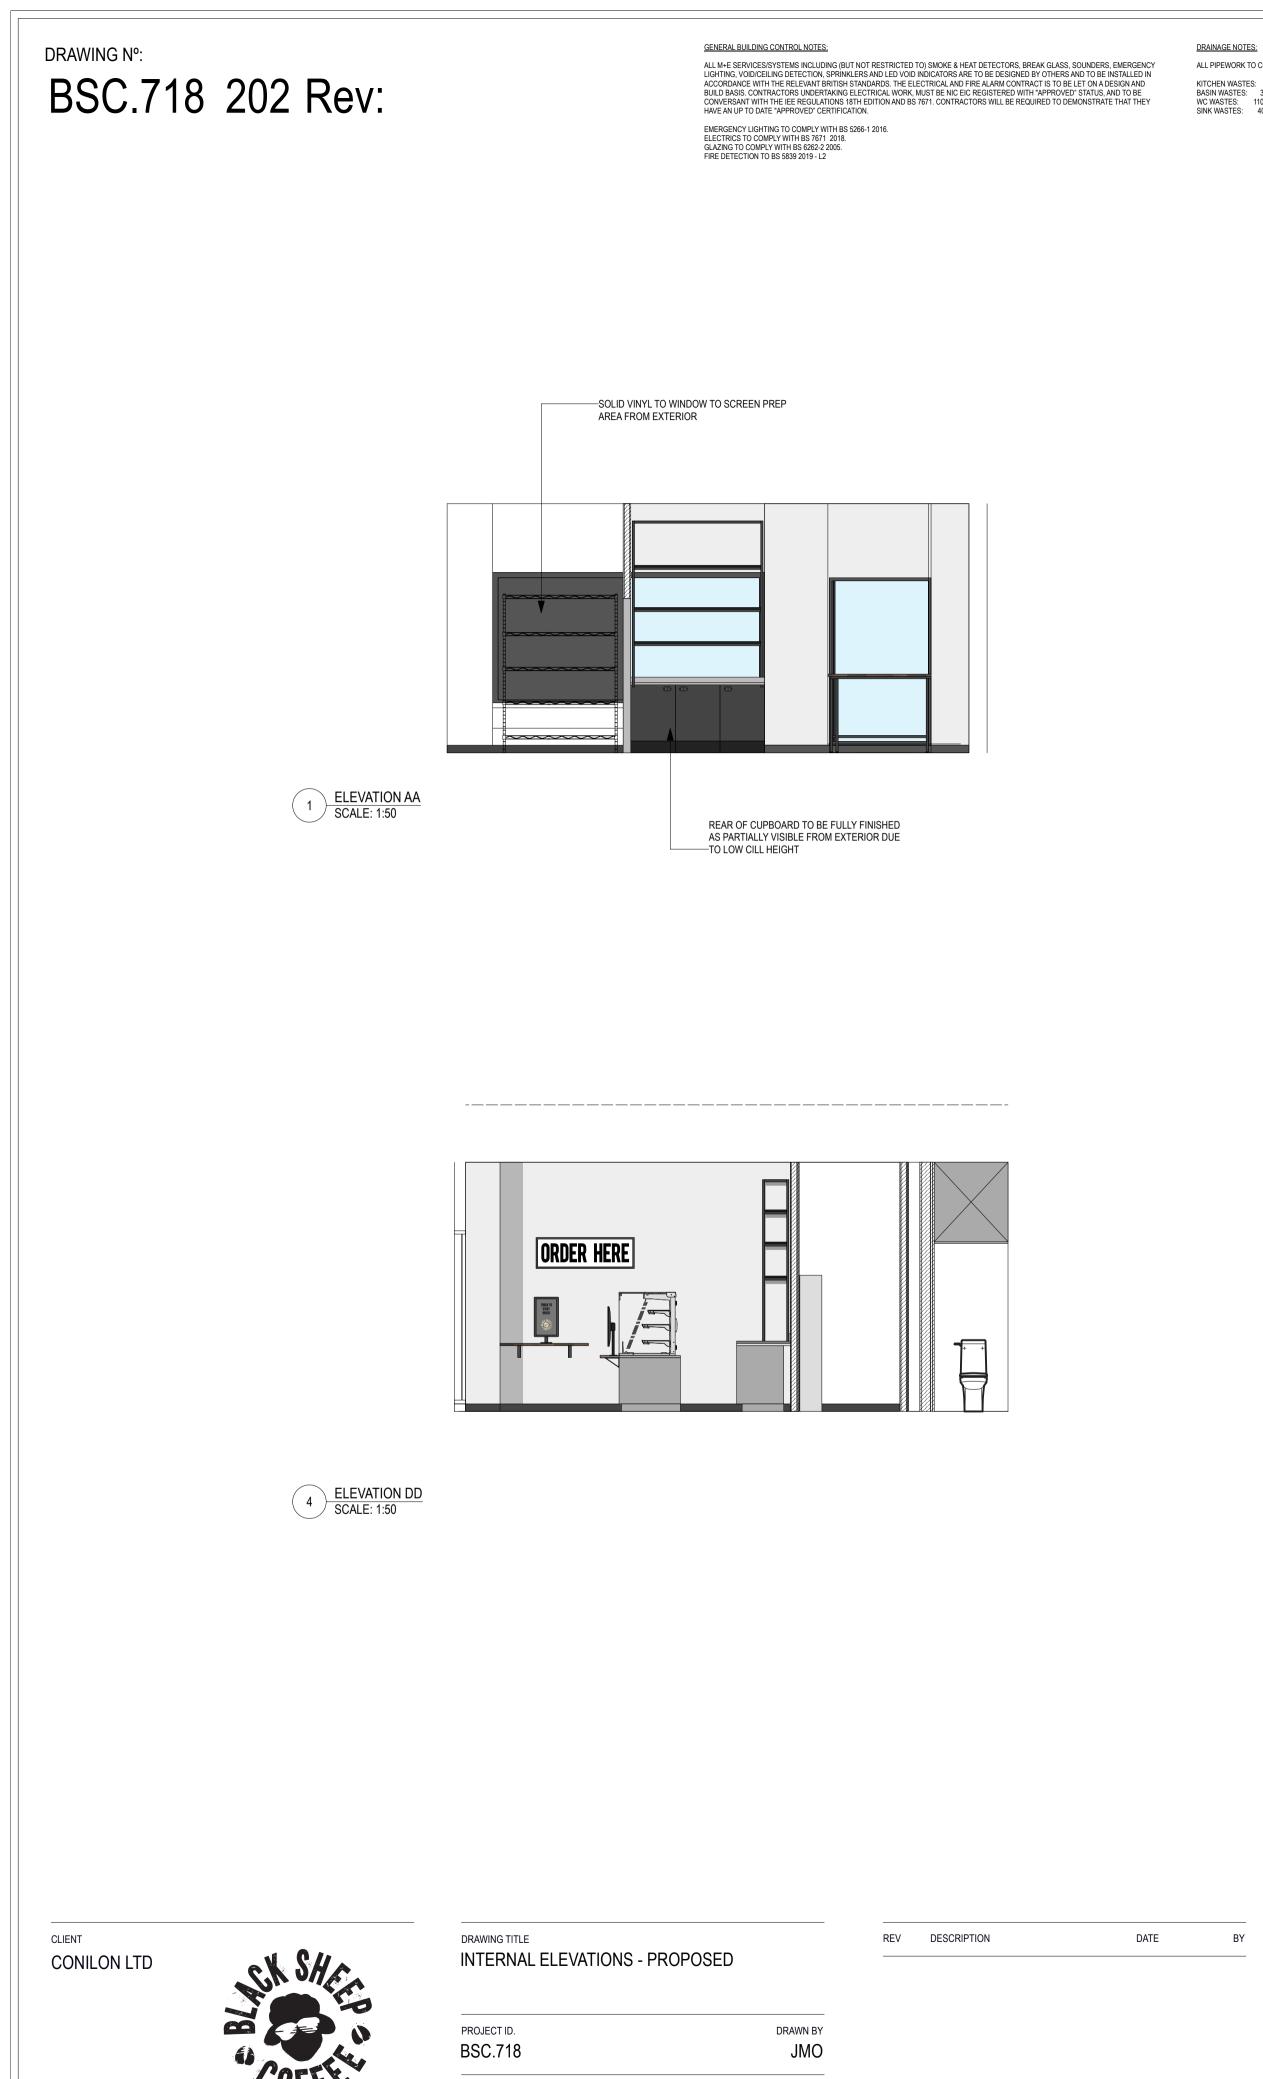
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SCALE @ A1 1:50 @ A1

202 ____

DRAWING NO.

REVISION

DATE

08/22

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NARROW BAR SURFACE ON BLACKENED STEEL FRAME IF SPACE ALLOWS. TO BE CONFIRMED FOLLOWING STRIP OUT AND DETAILING OF REPLACEMENT SHOPFRONT -TO REVEAL



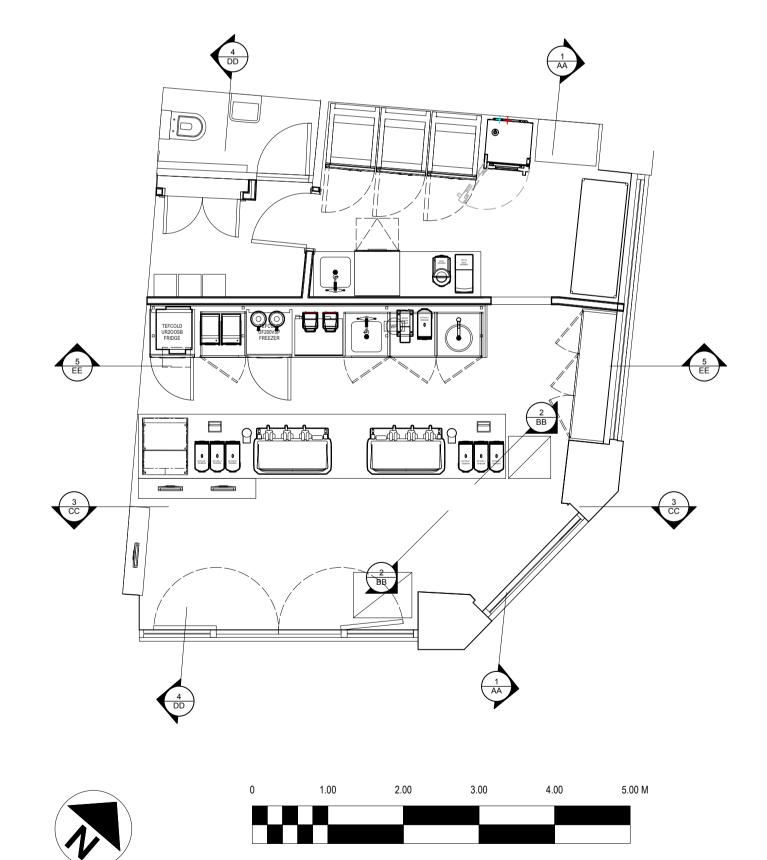
2 ELEVATION BB SCALE: 1:50

5 ELEVATION EE SCALE: 1:50

B١

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The Fruitful Design Consultancy Ltd. Chiltern House, Waterside, Chesham HP5 1PS T. +44 01494 771512 www.befruitful.co.uk

CONDIMENTS UNIT ON CASTERS TO ALLOW -FOR OPENING OF 180 DEGREE DOOR SET

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DRAWING N°: BSC.718 203 Rev:



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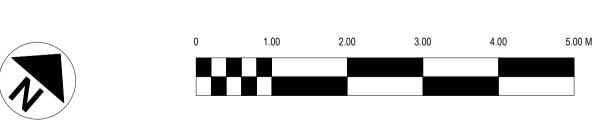
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GENERAL BUILDING CONTROL NOTES:

HAVE AN UP TO DATE "APPROVED" CERTIFICATION.



Proposed Strand Elevation



CLIENT CONILON LTD



PROJECT 423 STRAND, LONDON WC2R 0QE

DRAWING TITLE EXTERNAL ELEVATIONS - PROPOSED

PROJECT ID.	DRAWN BY
BSC.718	JMO
SCALE @ A1	DATE
1:50 @ A1	08/22
DRAWING NO.	REVISION
203	

REV DESCRIPTION DATE

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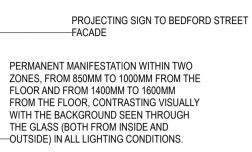
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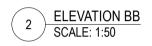
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Proposed Corner Elevation

BY

DO NOT SCALE FROM THIS DRAWING. THE AUTHOR OF THIS DRAWING TAKES NO RESPONSIBILITY FOR ANY DIMENSIONS OBTAINED BY MEASURING OR SCALING FROM THIS DRAWING AND NO RELIANCE MAY BE PLACED ON SUCH DIMENSIONS. ALL DIMENSIONS MUST BE CHECKED AND VERIFIED ON SITE BY THE CONTRACTOR BEFORE COMMENCING ANY WORK OR PRODUCING DRAWINGS. THE FRUITFUL DESIGN CONSULTANCY LTD. (HEREAFTER REFERRED TO AS FRUITFUL) MUST BE NOTIFIED IMMEDIATELY OF ANY ERRORS OR DISCREPANCIES PRIOR TO THE COMMENCEMENT OF WORK.

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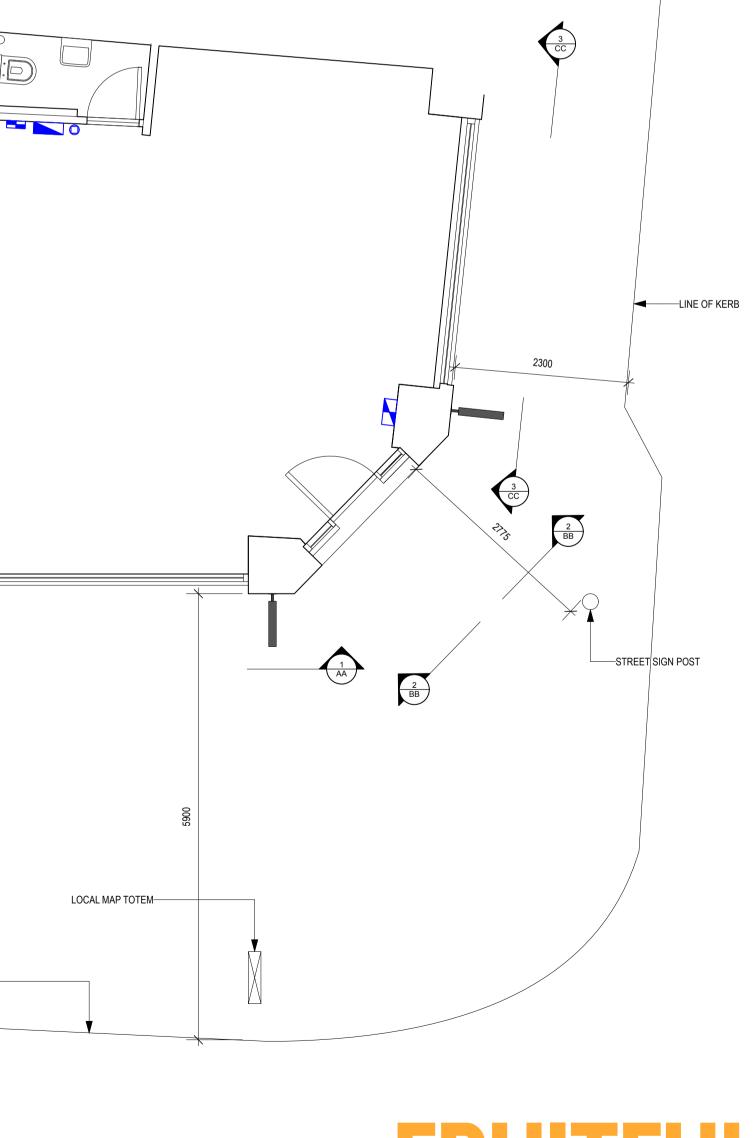
LINE OF KERB-

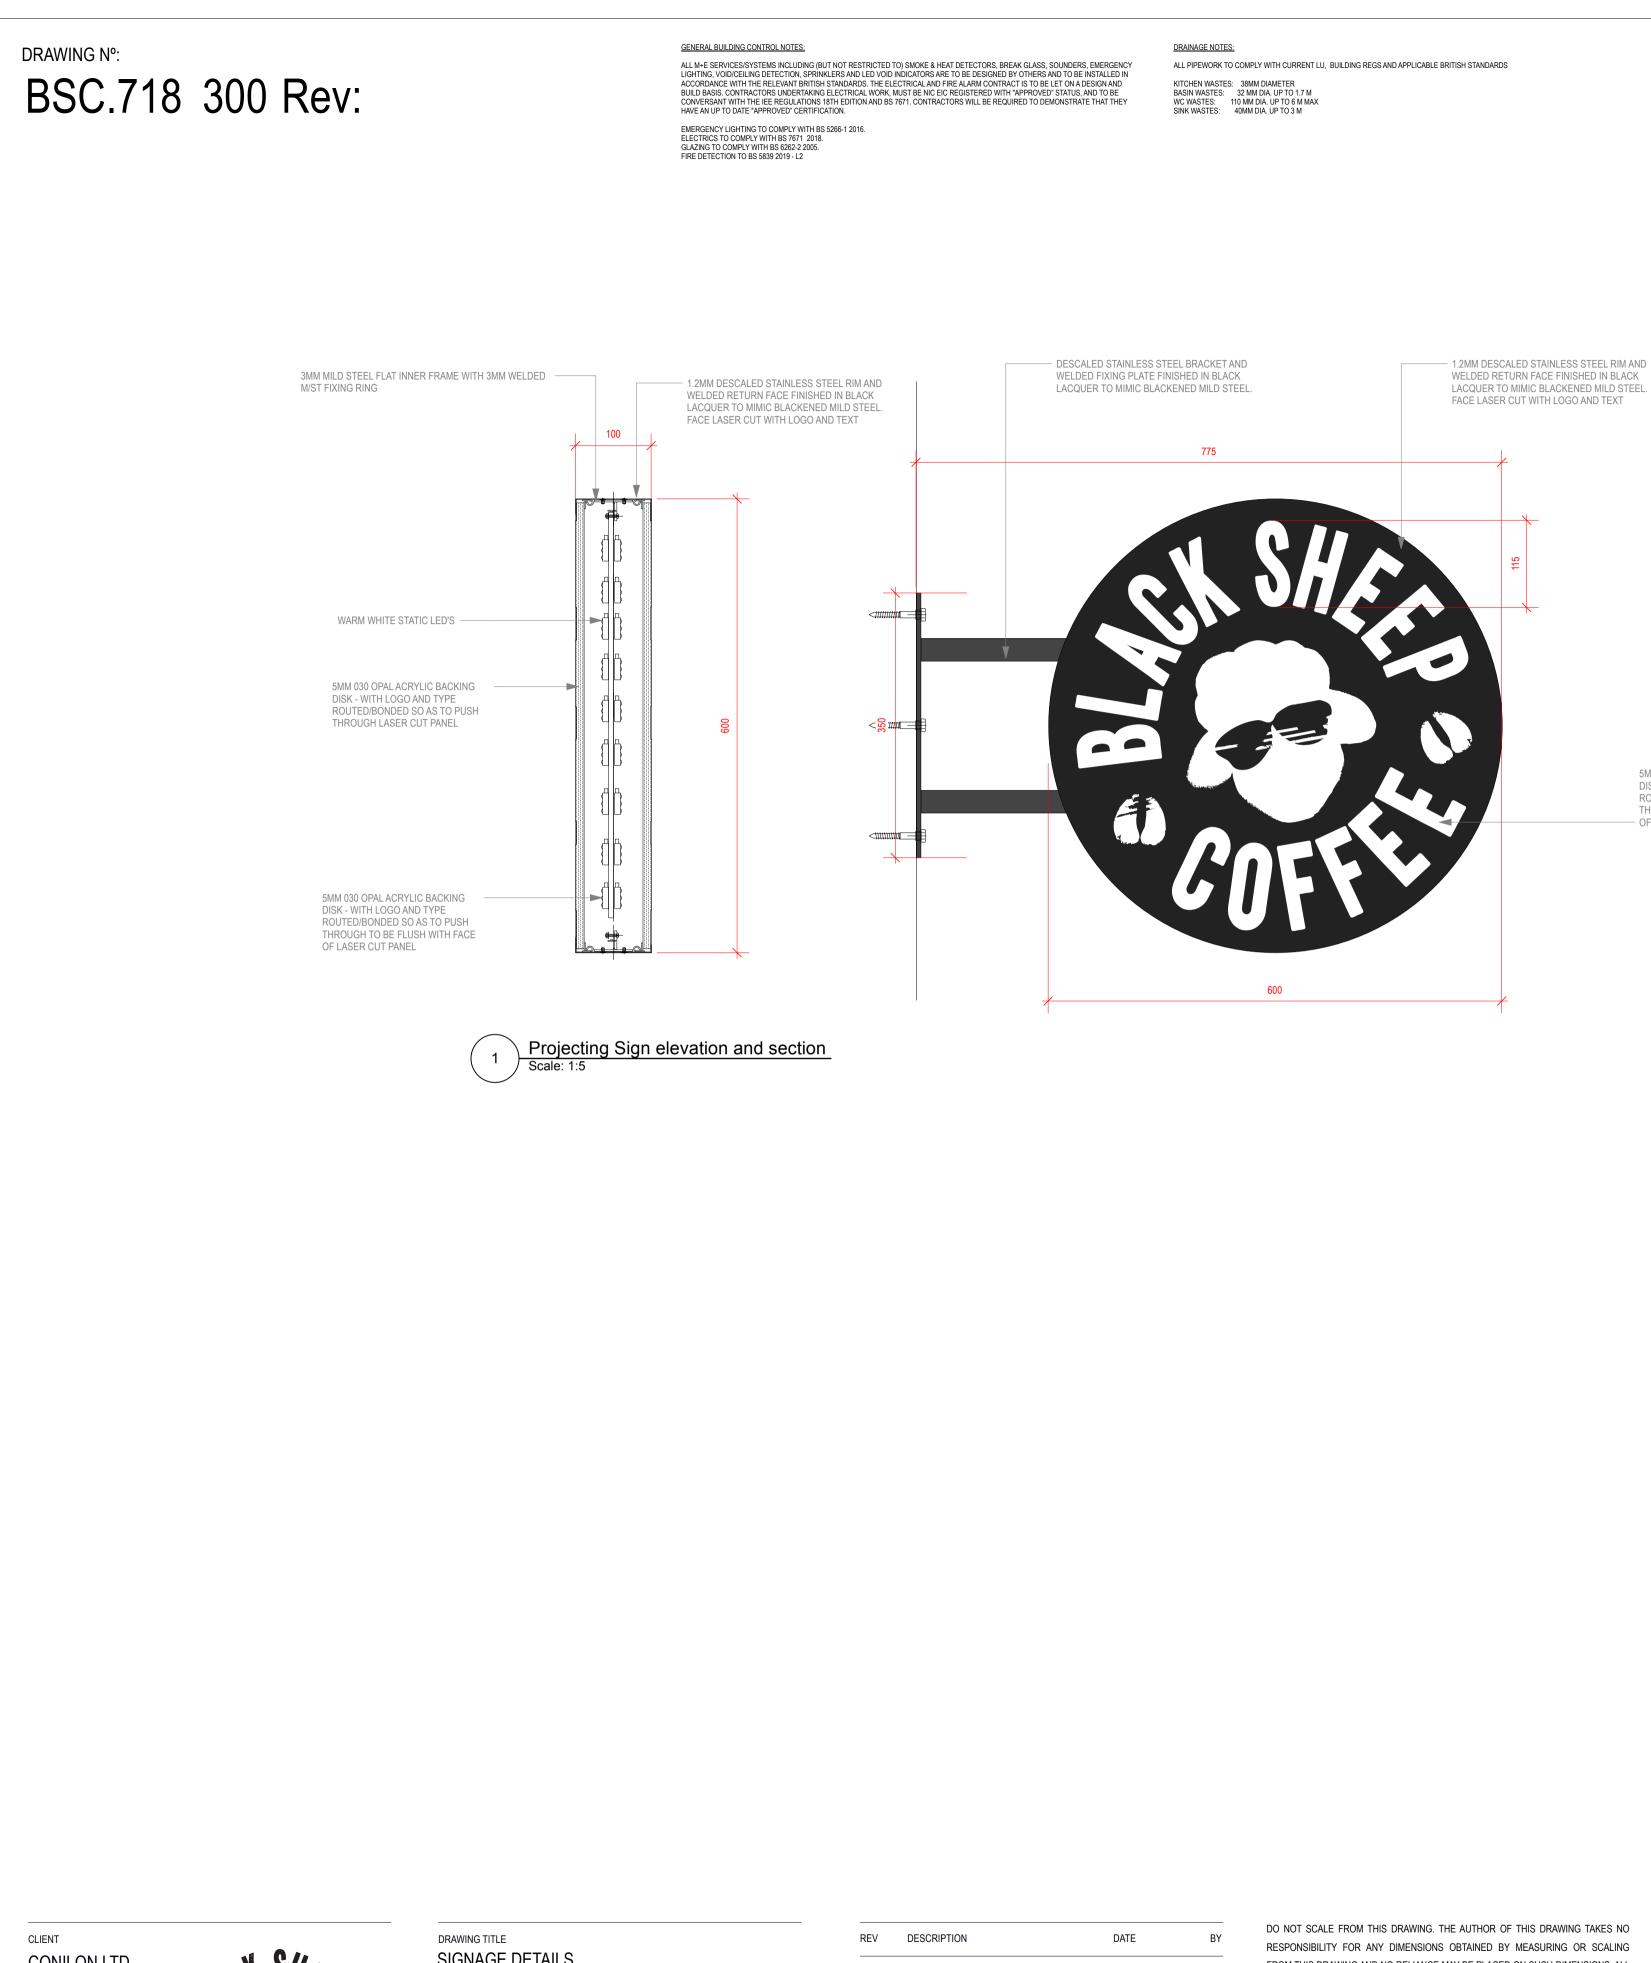
FIRE NOTES:

ALL EXIT DOORS SHOULD BE MAINTAINED SO AS TO BE CAPABLE OF BEING OPENED EASILY AND IMMEDIATELY FROM THE INSIDE WHEN REQUIRED, ANY DOORS ON THE ESCAPE ROUTES SHOULD NOT REQUIRE THE USE OF A KEY, CARD, SCANNER, CODE OR SIMILAR SYSTEM, FOR PERSONS TO EXIT THE PREMISES IN THE EVENT OF A FIRE.

FALLOW SPACES TO HAVE LIMITED FIRE LOAD AND BE CLEARED OUT AND LEFT STERILE. FALLOW SPACES ARE MANAGED SPACES WHERE IGNITION SOURCES ARE SEPARATED FROM FIRE LOAD. FALLOW SPACES CANNOT UNDER ANY CIRCUMSTANCE BE USED FOR STORAGE OR ANY OTHER USE, INCLUDING DRY GOODS STORAGE FOR CHAIRS ETC. ABSOLUTELY NOTHING. FALLOW AREAS TO BE ACCESSED FOR MAINTENANCE ONLY BY TRAINED PERSONAL.

INSTALLATION TO BE FULLY TESTED AND COMMISSIONED PRIOR TO HANDOVER. FULL EMERGENCY LIGHTING, FIRE ALARM SYSTEM AND SPRINKLER INSTALLATION COMMISSIONING AND TESTING CERTIFICATION TO BE PROVIDED TO THE BLACK SHEEP COFFEE DESIGN TEAM ON COMPLETION. ON COMPLETION OF THE SCHEME AND ON OCCUPATION, THE CLIENT SHOULD BE AWARE OF THE NEED TO COMPLETE/REVIEW THEIR FIRE RISK ASSESSMENT (FRA) IN ACCORDANCE WITH THE REGULATORY REFORM (FIRE SAFETY) ORDER 2005.





CONILON LTD



PROJECT 423 STRAND, LONDON WC2R 0QE SIGNAGE DETAILS

PROJECT ID.	DRAWN BY
BSC.718	JMC
SCALE @ A1	DATE
1:5 @ A1	08/22
DRAWING NO.	REVISION
300	

ELECTRICAL NOTES: ELECTRICAL FIXTURES

OUTLETS AND CONTROLS OF ELECTRICAL FIXTURES AND SYSTEMS SHOULD BE POSITIONED AT LEAST 350MM FROM ANY INTERNAL CORNER, PROJECTING WALL OR SIMILAR OBSTRUCTION AND, UNLESS THE NEED FOR A HIGHER LOCATION CAN BE DEMONSTRATED, NOT MORE THAN 1.2M ABOVE FLOOR LEVEL. THIS WOULD INCLUDE FIXTURES SUCH AS SOCKETS, SWITCHES, FIRE ALARM CALL POINTS AND TIMER CONTROLS OR PROGRAMMERS.

WITHIN THIS HEIGHT RANGE: WITHIN THIS HEIGHT RANGE: • LIGHT SWITCHES SHOULD BE POSITIONED AT A HEIGHT OF BETWEEN 900MM AND 1.1M ABOVE FLOOR LEVEL • STANDARD SWITCHED OR UNSWITCHED SOCKET OUTLETS AND OUTLETS FOR OTHER SERVICES SUCH AS TELEPHONE OR TELEVISION SHOULD BE POSITIONED AT LEAST 400MM ABOVE FLOOR LEVEL. ABOVE AN OBSTRUCTION, SUCH AS A WORKTOP, FIXTURES SHOULD BE AT LEAST 150MM ABOVE THE PROJECTING SURFACE

EMERGENCY LIGHTING ELECTRICAL ENGINEER TO ENSURE EMERGENCY LIGHTING IS FULLY FUNCTIONAL AT ALL TIMES. ESCAPE LIGHTING IS REQUIRED NOT ONLY ON TOTAL FAILURE OF SUPPLY TO THE SYSTEMS LIGHTING BUT ALSO ON A LOCALISED CIRCUIT FAILURE.

FIRE NOTES: FIRE DETECTION TO BE INSTALLED AND TESTED TO THE LATEST VERSION OF TO BS5839 PART 1 'FIRE DETECTION AND ALARM SYSTEMS IN BUILDINGS'. FINAL DESIGN BY SPECIALIST CONTRACTOR TO CATEGORY L2.

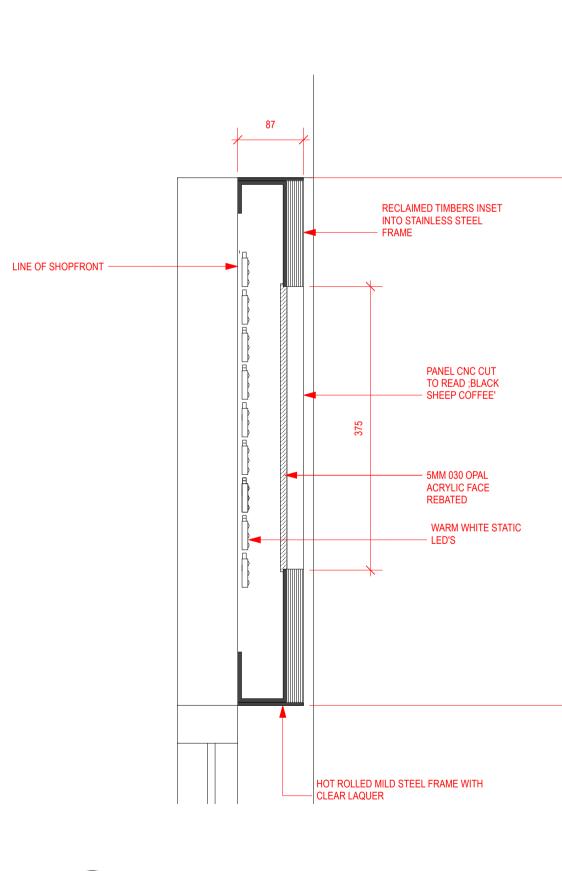
AIR CONDITIONING AND AUDIO SYSTEMS TO SHUT DOWN UPON ACTIVATION OF FIRE ALARM SURFACE FINISHES TO WALLS AND CEILINGS TO MEET BUILDING CONTROL OFFICERS MINIMUM SURFACE SPREAD OF FLAME REQUIREMENTS, TYPICALLY:

SMALL ROOMS UNDER 30M2: D-S3,D2 OTHER ROOMS: C-S3,D2 CIRCULATION SPACES: B-S3,D2

5MM 030 OPAL ACRYLIC BACKING DISK - WITH LOGO AND TYPE ROUTED/BONDED SO AS TO PUSH THROUGH TO BE FLUSH WITH FACE - OF LASER CUT PANEL

PROJECTING SIGN TO COMPLY WITH CITY OF LONDON LIGHTING VISION REQUIREMENTS:

- HIGH CRI WHITE LIGHT MUST BE USED, WITH COLOUR TEMPERATURES BETWEEN 2700K AND 4000K (PROPOSED 2700K) • DIRECT SPILL-LIGHT TO THE GROUND PLANE FROM THE SIGNAGE LIGHTING MUST NOT EXCEED 2 LUX • •
- •



2

Fascia sign - section through and part elevation Scale: 1:5

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EMERGENCY LIGHTING TO BE INSTALLED AND TESTED TO BS 5266-1 EMERGENCY LIGHTING PART 1: 'CODE OF PRACTICE FOR THE EMERGENCY ESCAPE LIGHTING OF PREMISES', BS EN 1838 'LIGHTING APPLICATIONS - EMERGENCY LIGHTING' AND BS EN 50172 'EMERGENCY ESCAPE LIGHTING SYSTEMS'. DIRECTIONAL FIRE EXIT SIGNAGE TO BS5499 AND BS ISO 7010.

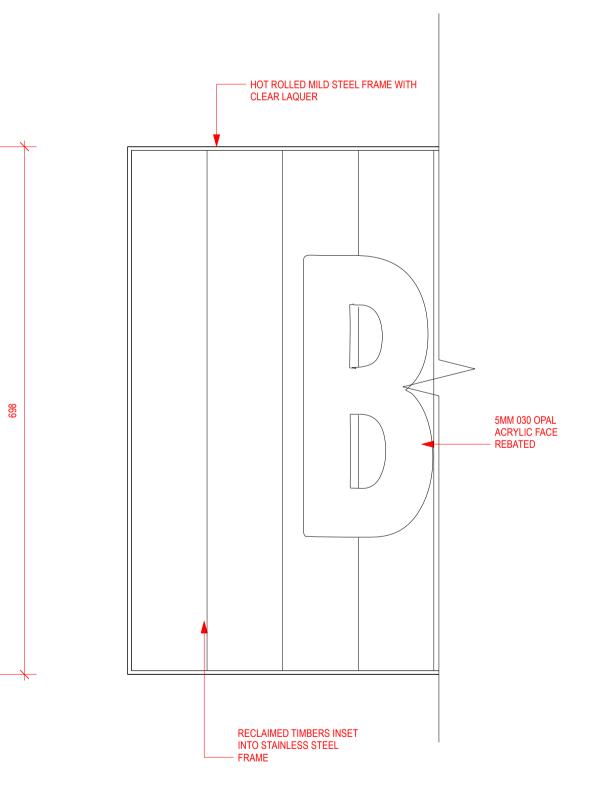
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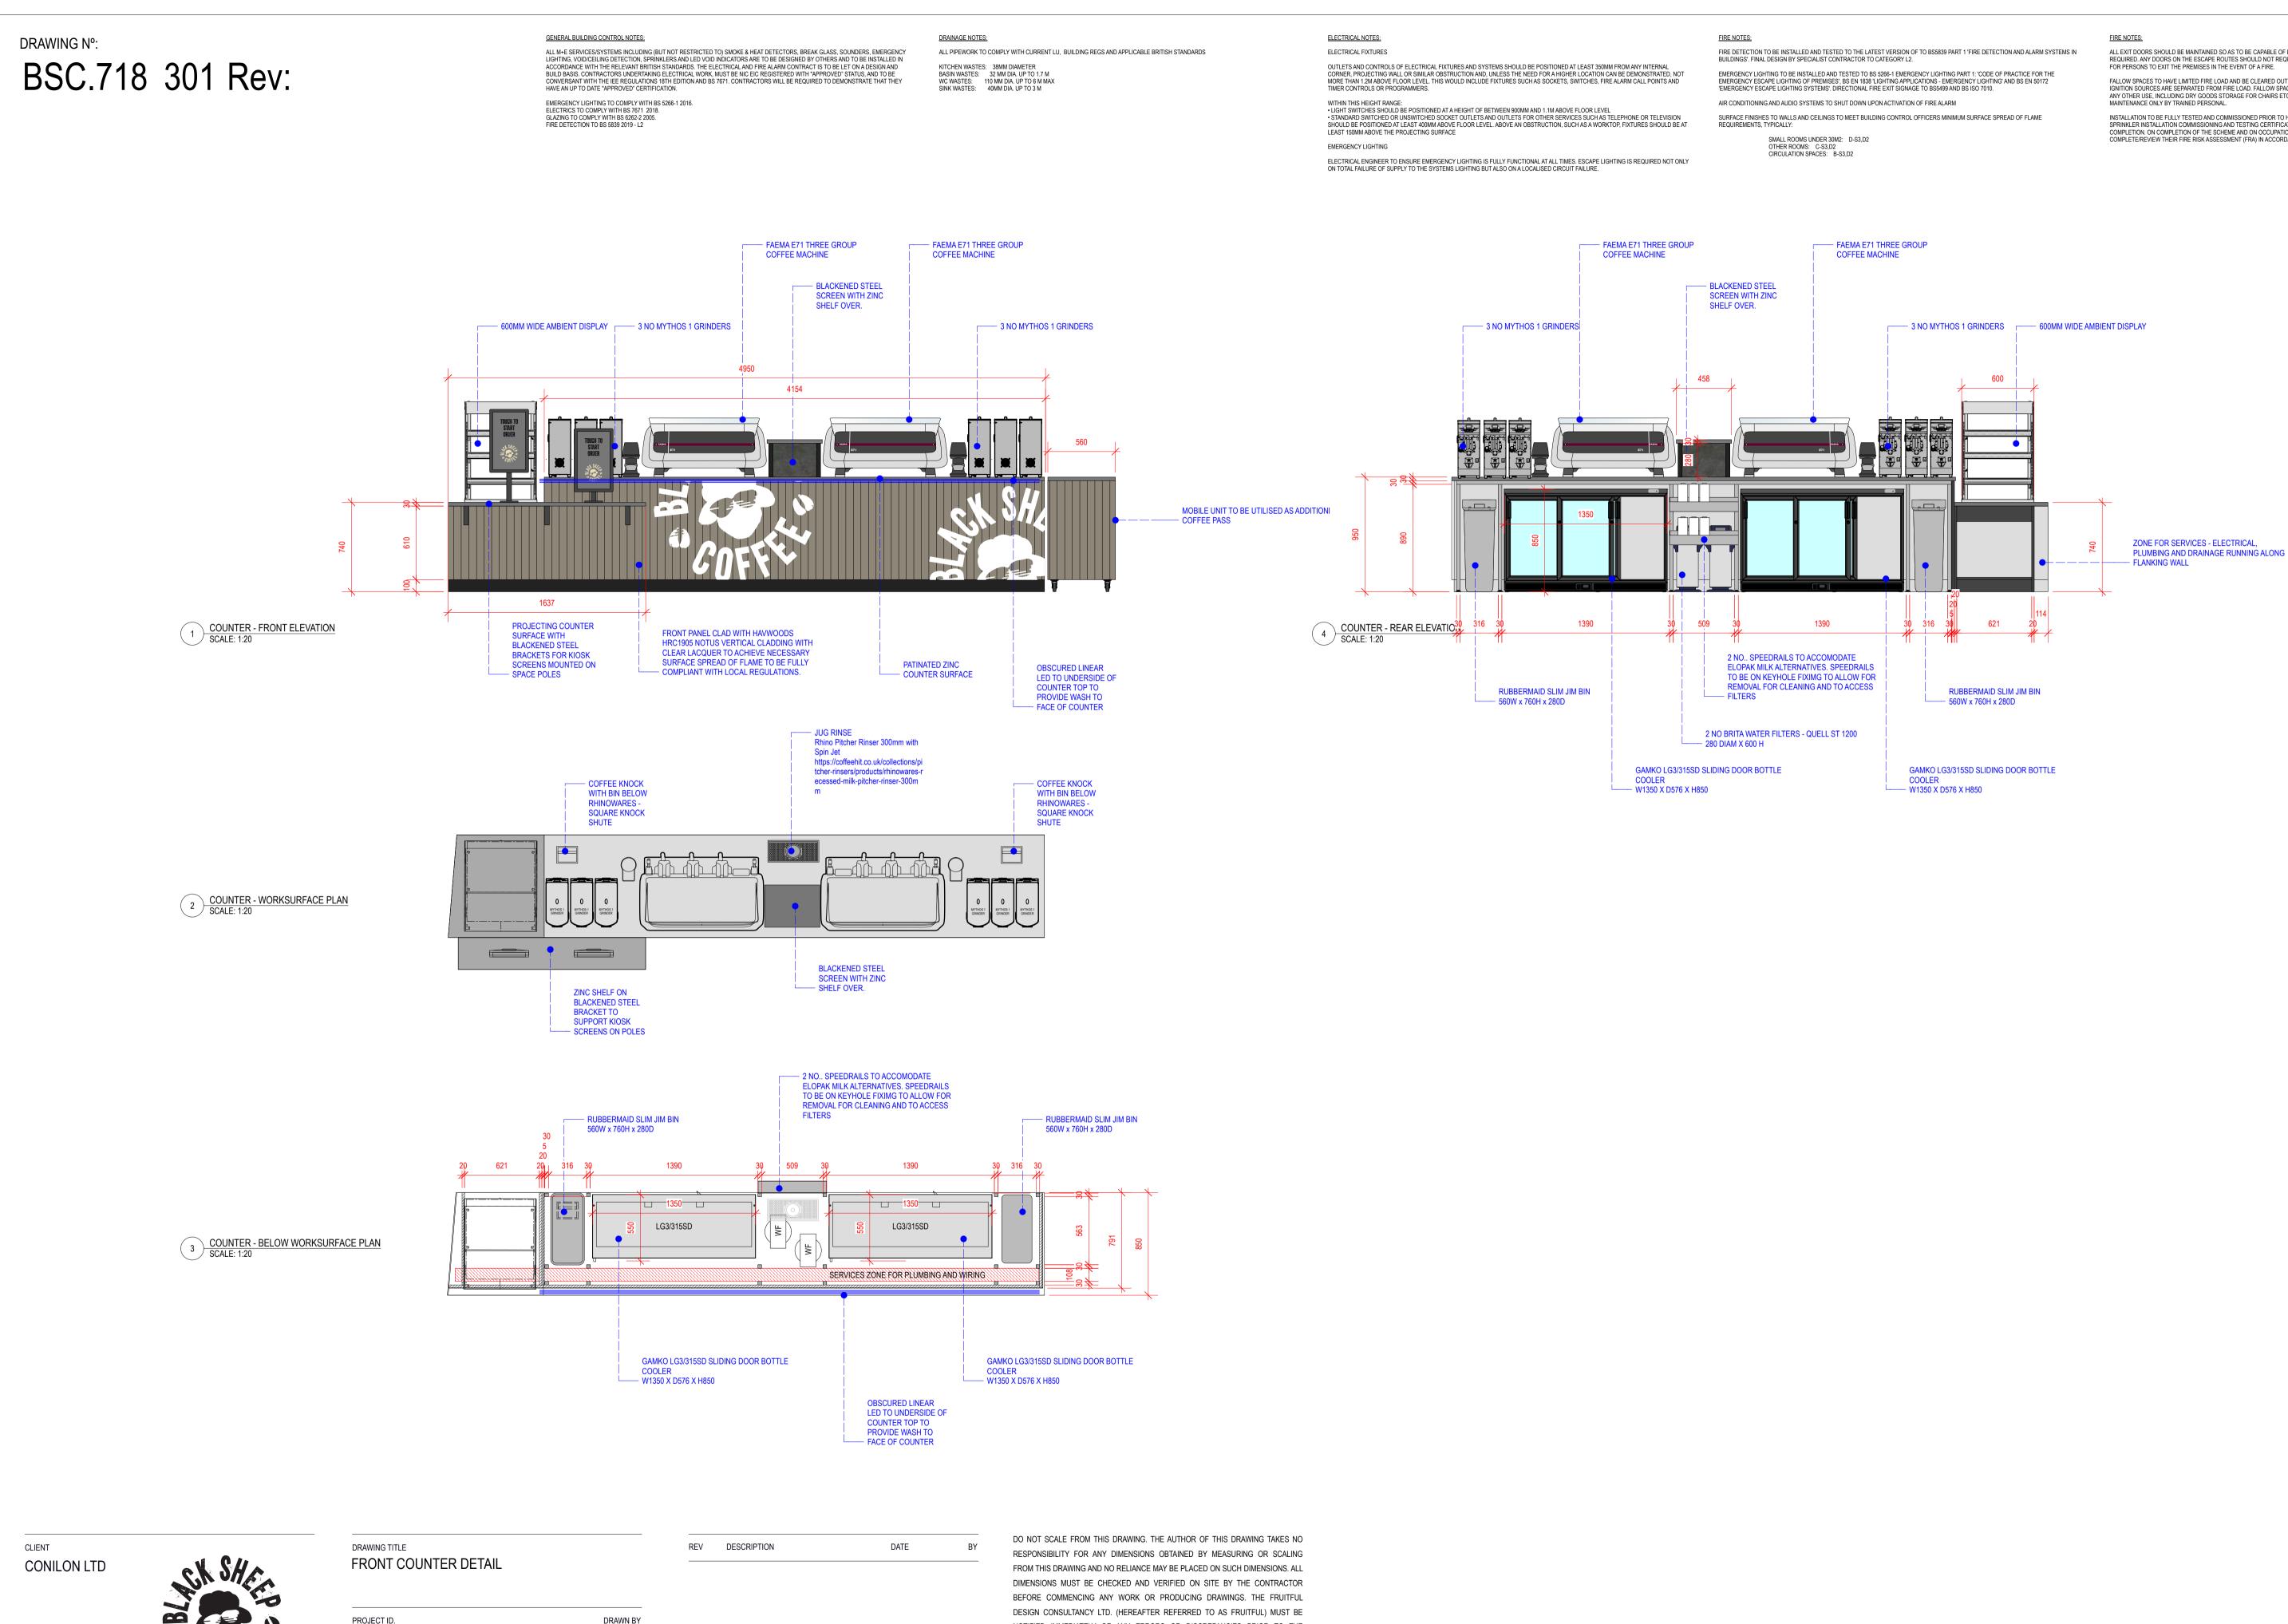
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THE MAXIMUM LUMINANCE ON THE FACE OF THE HANGING SIGN MUST NOT EXCEED 300CD/M2 COLOURED AND ANIMATED LIGHTING EFFECTS (INCLUDING COLOUR-CHANGING) SHOULD NOT BE EMPLOYED







PROJECT ID.	DRAWN BY
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301	

NOTIFIED IMMEDIATELY OF ANY ERRORS OR DISCREPANCIES PRIOR TO THE COMMENCEMENT OF WORK.

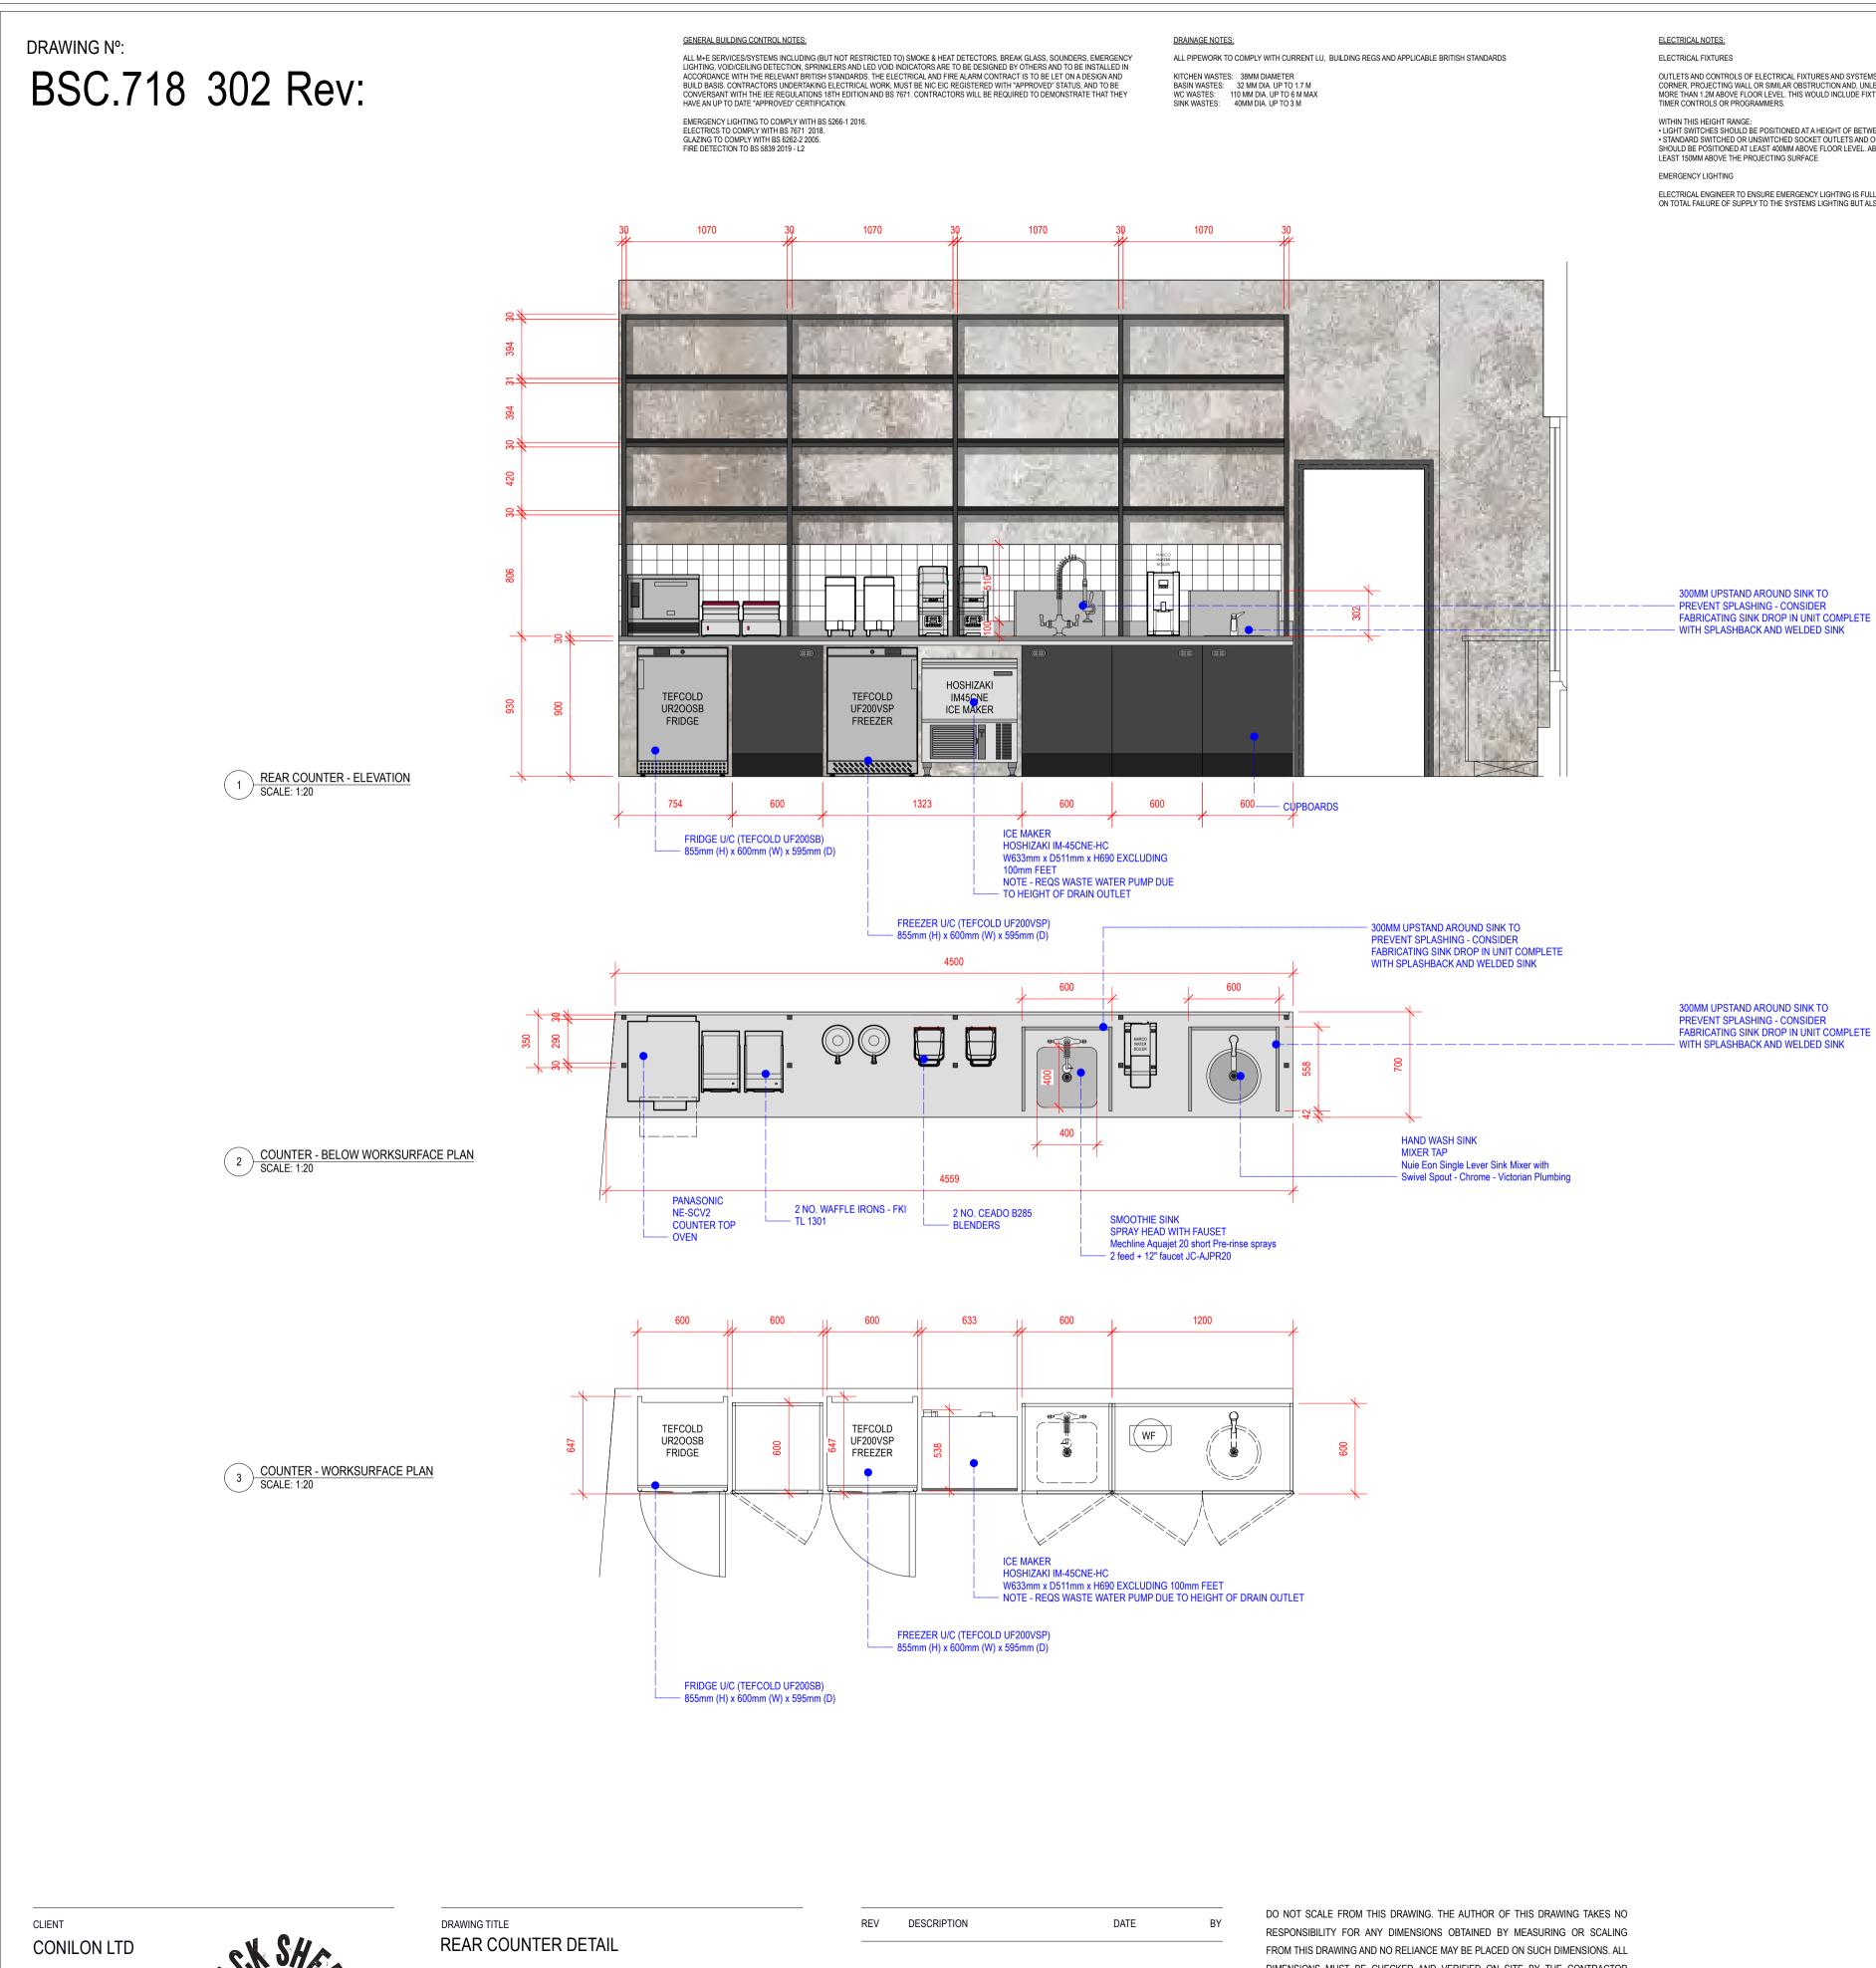
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PROJECT ID.	DRAWN BY
BSC.718	JMO
SCALE @ A1	DATE
1:25 @ A1	08/22
drawing no. 302	REVISION

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FABRICATING SINK DROP IN UNIT COMPLETE

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