
Proposed Elevations

Scale 1:100




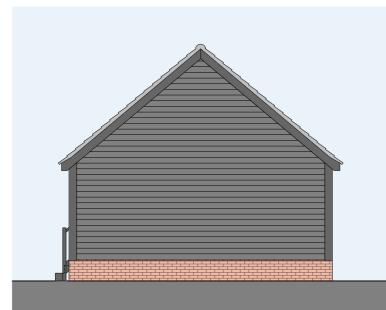


Side Elevation (South)



Rear Elevation (West)

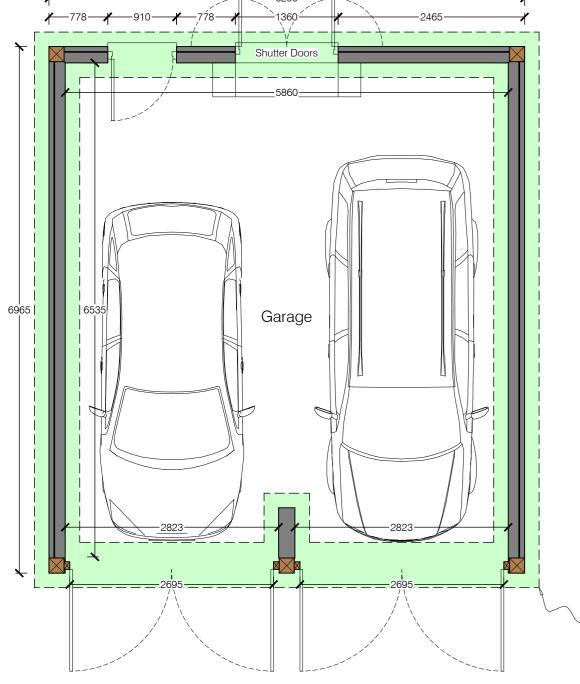

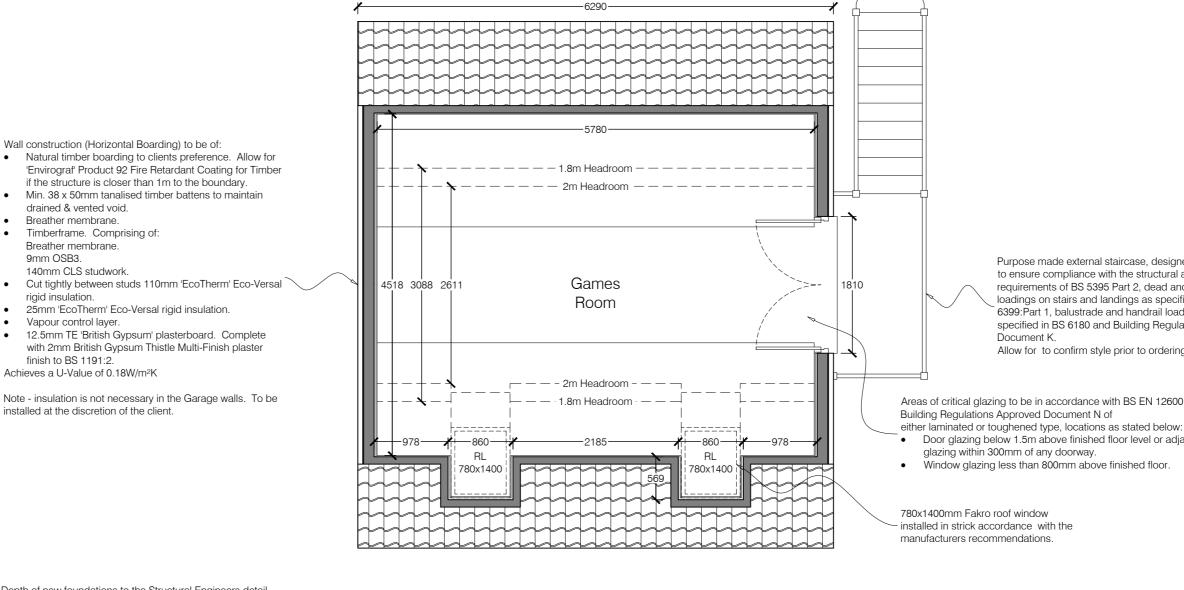

Depth of new foundations to the Structural Engineers detail and to the approval of the Building Control Inspector.

Proposed Ground Floor Layout Scale 1:50

Proposed First Floor Layout Scale 1:50



Principle Elevation (North)

Elevation Notes

- 1. Elevations are intended as an aid to planning only. Before any detailed design is undertaken all measurements need to be confirmed.
- 2. No dimensions are to not scaled from this drawing. The Contractor/ Manufacturer is responsible for checking all dimensions and querying any discrepancies.
- 3. Any discrepancies must be highlighted before proceeding with works.
- 4. The elevations are intended to show the main building outlines only.

Notes

- 1. All dimensions are in millimetres, unless stated otherwise.
- 2. This survey has been merged with mapping from the Ordnance Survey National Geographic Database. This was Supplied by copla ltd trading as UKPlanningMaps.com a licensed Ordnance Survey partner (100054135). Data licence for this mapping expires January 2023. Surveyed data is merged with Ordnance Survey data for completeness.
- Should the background information for the survey area be 3. based on an Ordnance Survey tile we are not liable for any loss that may arise due to a lack of accuracy in that digital data.
- The information presented in this survey is a recording of 4. what was present and accessible at the time of survey.
- 5. This drawing is not to be used in whole or part other than for the intended purpose and project as defined on this drawing.
- 6. Not all overhead services have been identified.

Purpose made external staircase, designed and detailed to ensure compliance with the structural and safety requirements of BS 5395 Part 2, dead and imposed loadings on stairs and landings as specified in BS 6399:Part 1, balustrade and handrail loadings as specified in BS 6180 and Building Regulations Approved Document K. Allow for to confirm style prior to ordering.

Areas of critical glazing to be in accordance with BS EN 12600:2002 and Building Regulations Approved Document N of

- Door glazing below 1.5m above finished floor level or adjacent side glazing within 300mm of any doorway
- Window glazing less than 800mm above finished floor.

installed in strick accordance with the

NOT TO BE USED FOR CONSTRUCTION FOR PLANNING Rev Date Chkd Description NURFOLK SURVEYING & DESIGN norfolksurveying@gmail.com - 07595 470367 Client Mr Neil Moore Project Barn Cottage Holverston, Norfolk NR14 7PH Drawing Title Proposed Elevations & Layout Scale U.N.O. Date As Indicated (A2) January 2023 Drawn MG

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Drawing No.