



**Existing Ground Floor Plan**  
Scale 1:100

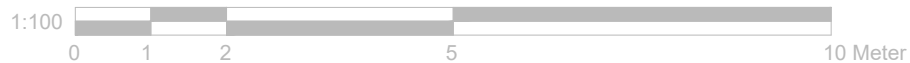


<p><b>Notes</b></p> <p>All plans, sections &amp; elevations are based on measured readings and scaled dimension.</p> <p>Any discrepancies be reported immediately.</p> <p>To be read in conjunction with Structural Engineers' drawings and Mechanical and Electrical drawings</p> <p>All Materials To Match Existing</p>	<p><b>Revisions</b></p>	<p>Drawing name <b>Existing - Ground Floor Plan</b></p>		<p>Drawing no <b>95 FP 01</b></p>	<p>Rev</p>
		<p>Project <b>95 Vera Avenue London N21 1RN</b></p>		<p><b>Detail Design</b></p> <p>T 07410377527 E smic@dd2d.co.uk</p>	
		<p>Scale <b>1:100 @ A3</b></p>	<p>Status <b>Planning</b></p>		

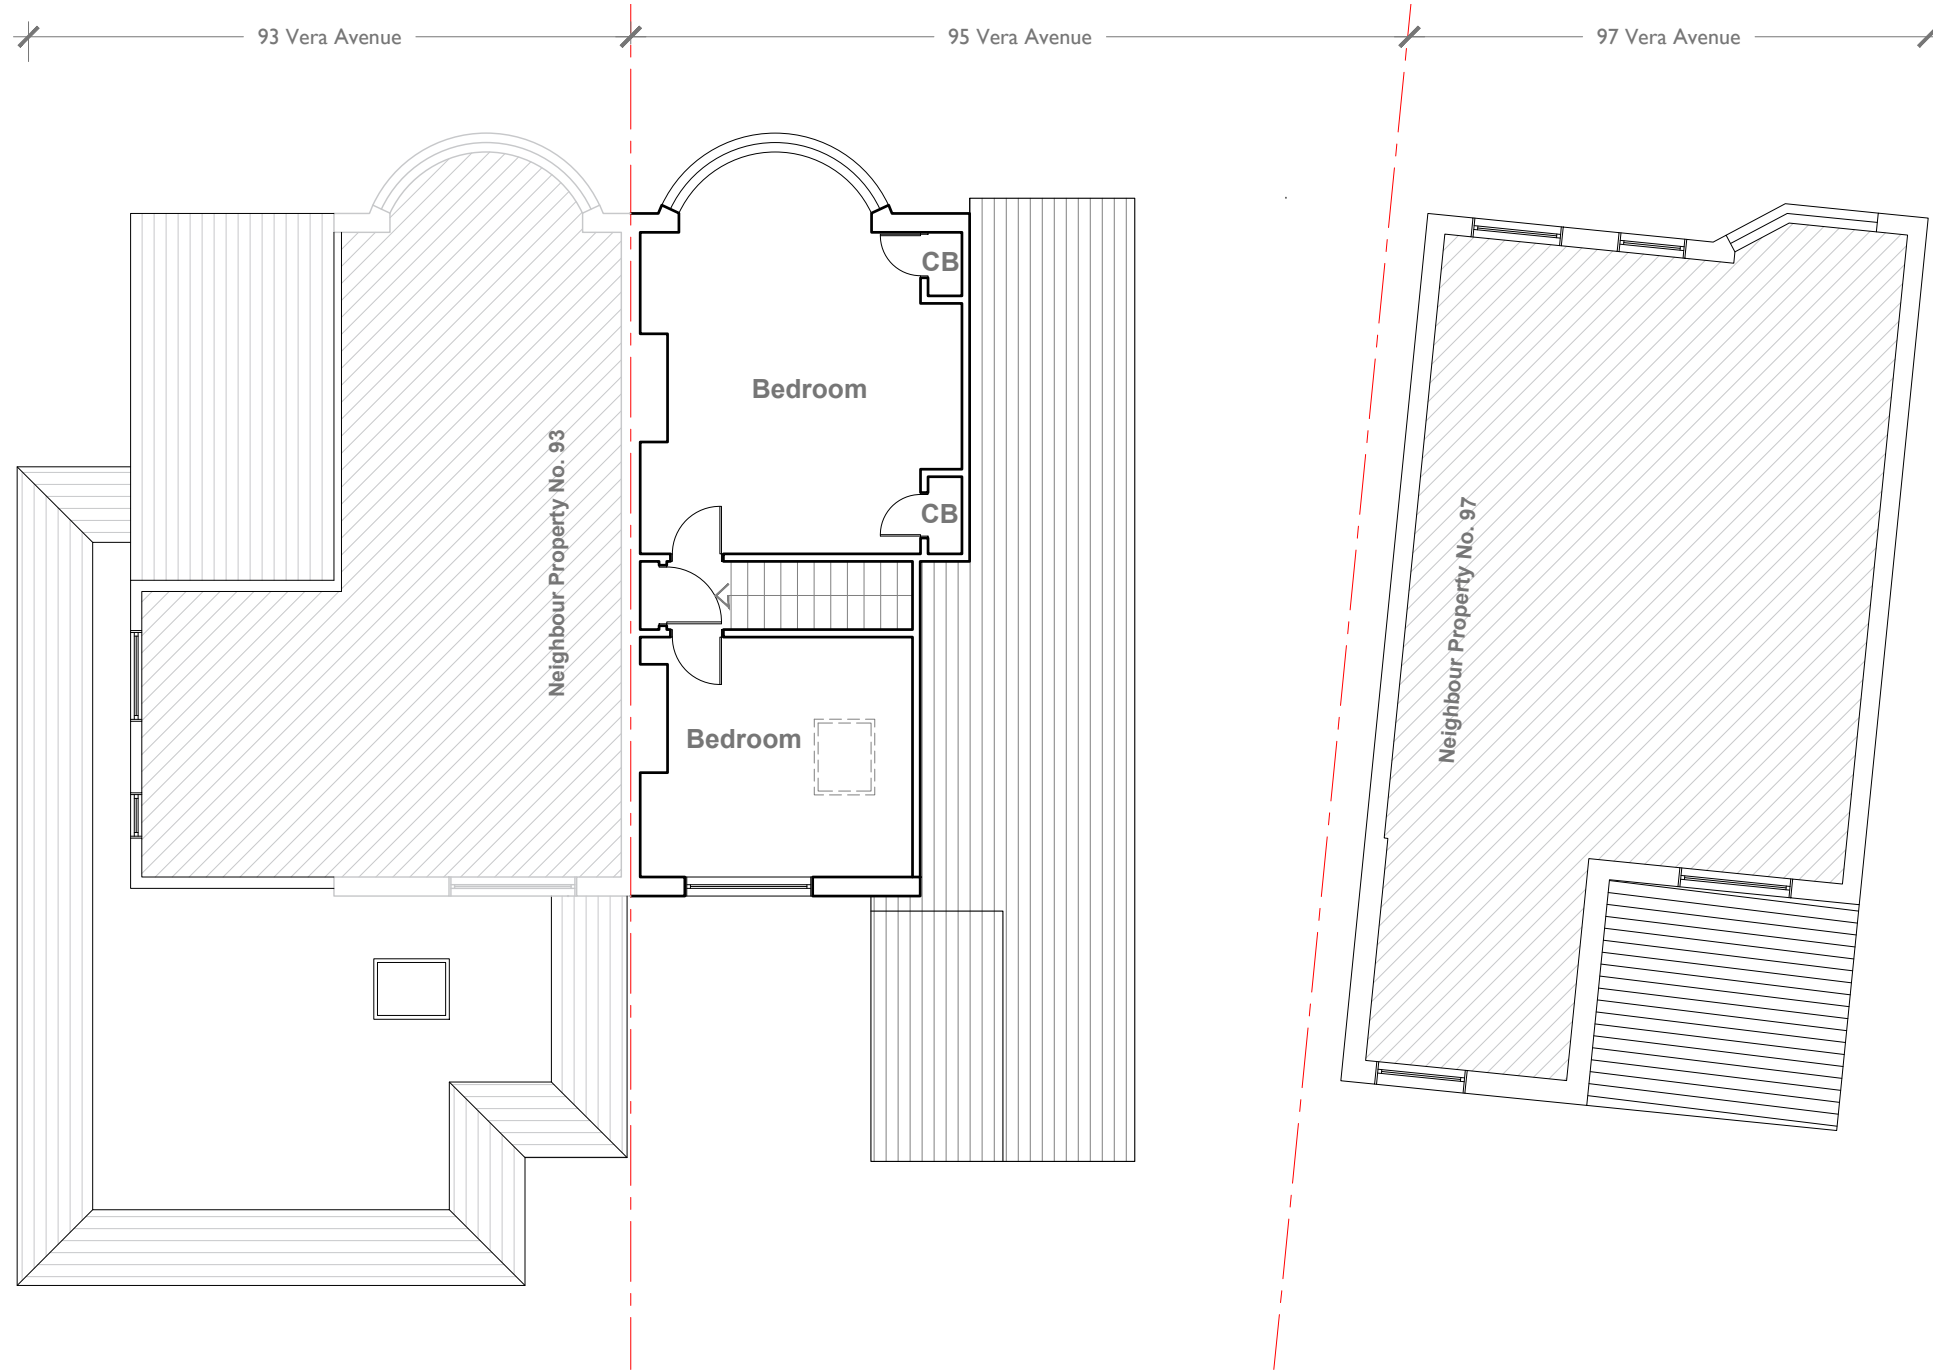

**Existing First Floor Plan**  
Scale 1:100



<p><b>Notes</b></p> <p>All plans, sections &amp; elevations are based on measured readings and scaled dimension.</p> <p>Any discrepancies be reported immediately.</p> <p>To be read in conjunction with Structural Engineers' drawings and Mechanical and Electrical drawings</p> <p>All Materials To Match Existing</p>	<p><b>Revisions</b></p>	<p>Drawing name <b>Existing - First Floor Plan</b></p>		<p>Drawing no <b>95 FP 02</b></p>	<p>Rev</p>
		<p>Project <b>95 Vera Avenue London N21 1RN</b></p>		<p><b>Detail Design</b></p> <p>T 07410377527 E smic@dd2d.co.uk</p>	
		<p>Scale <b>1:100 @ A3</b></p>	<p>Status <b>Planning</b></p>		

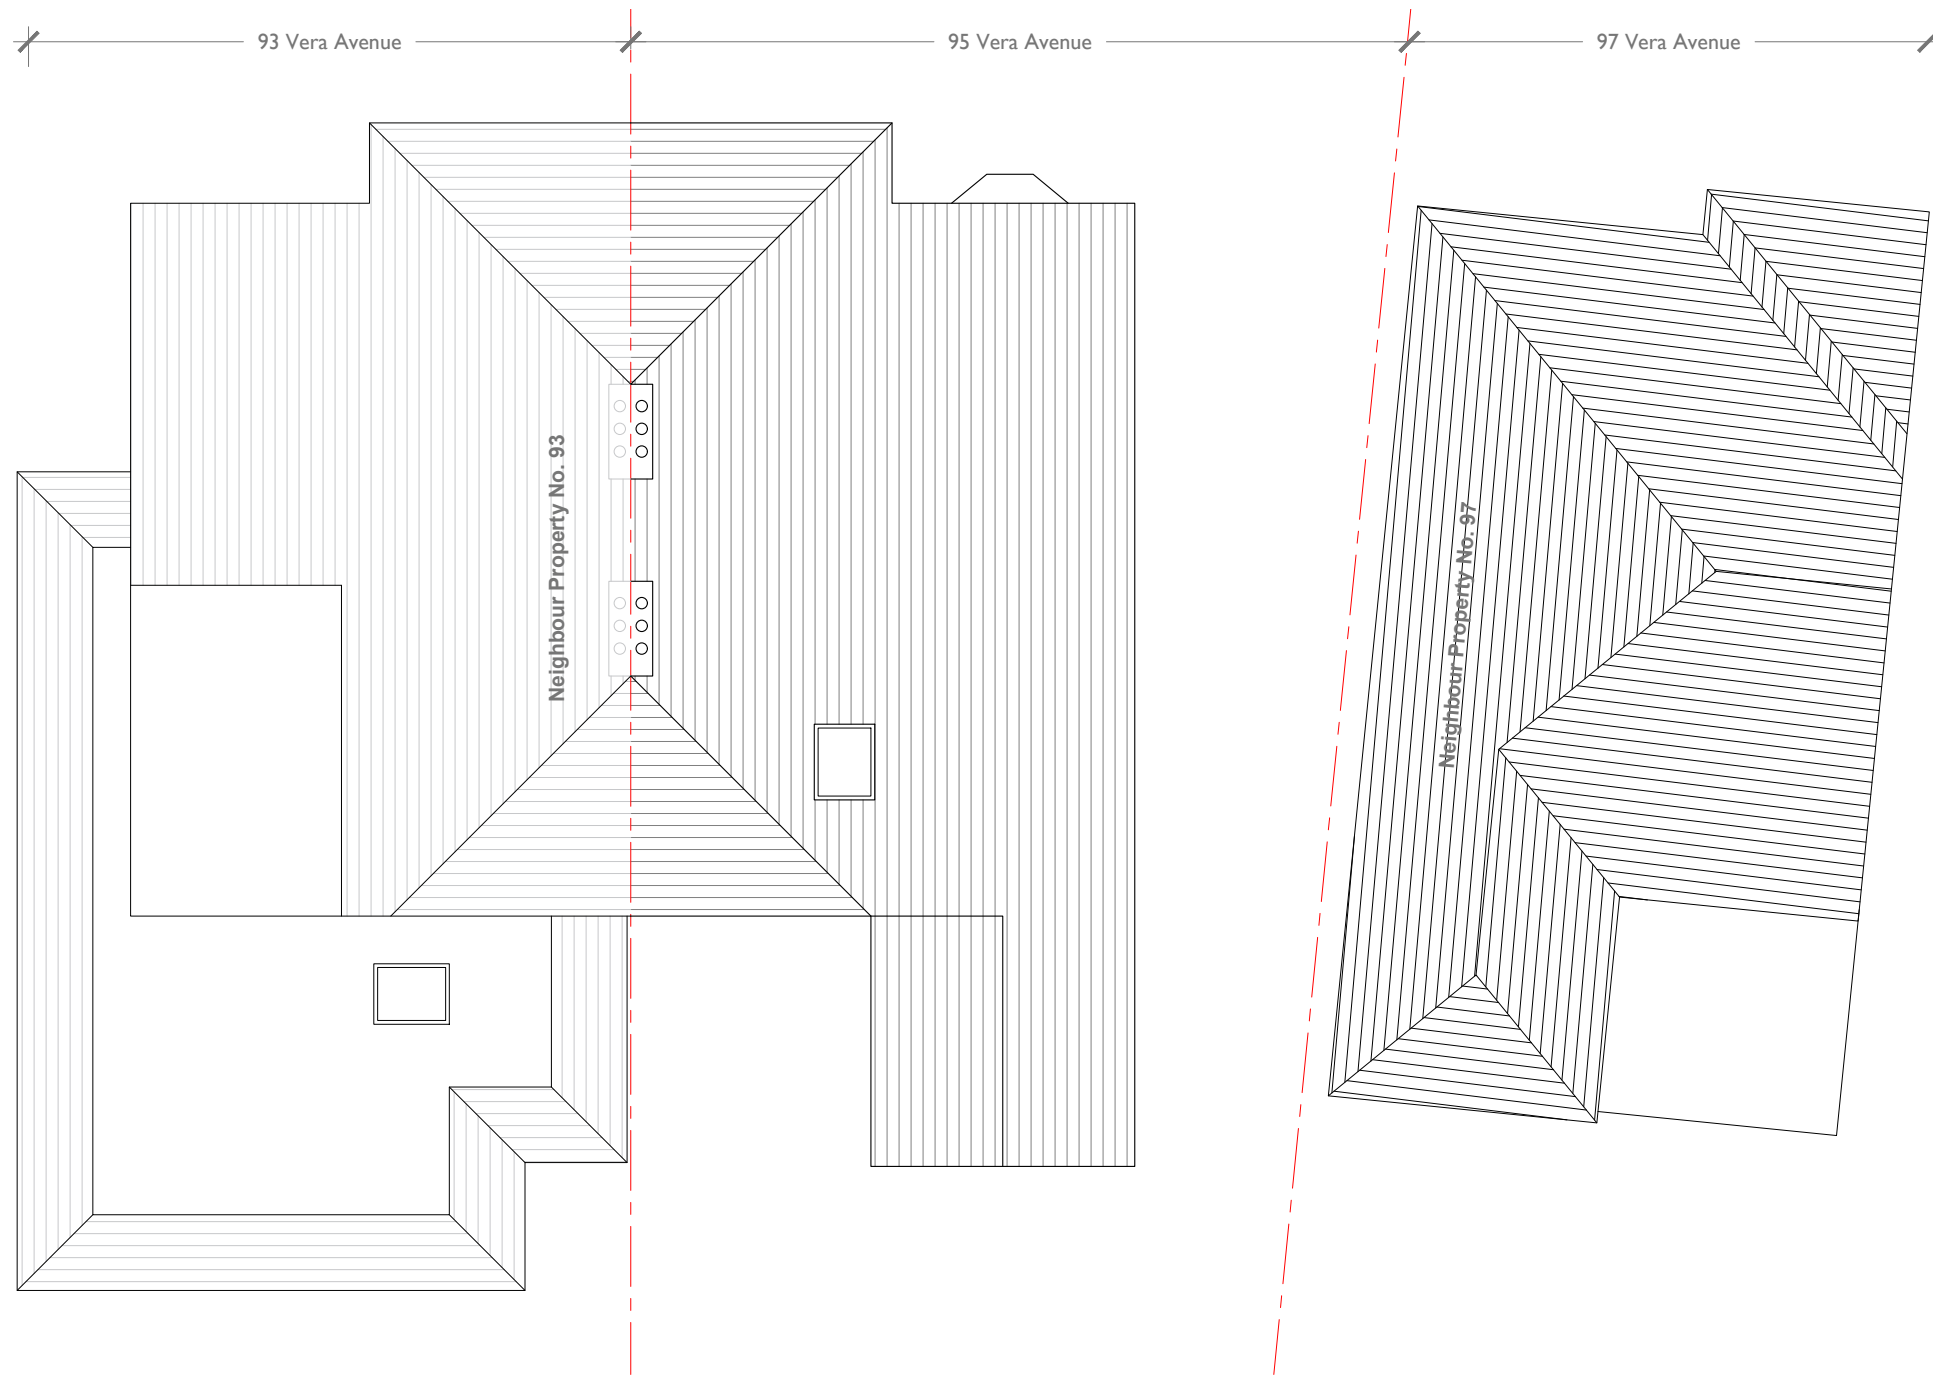

**Existing First Floor Plan**  
Scale 1:100



<p><b>Notes</b></p> <p>All plans, sections &amp; elevations are based on measured readings and scaled dimension.</p> <p>Any discrepancies be reported immediately.</p> <p>To be read in conjunction with Structural Engineers' drawings and Mechanical and Electrical drawings</p> <p>All Materials To Match Existing</p>	<p><b>Revisions</b></p>	<p>Drawing name <b>Existing - Roof Plan</b></p>		<p>Drawing no <b>95 FP 03</b></p>	<p>Rev</p>
		<p>Project <b>95 Vera Avenue London N21 1RN</b></p>		<p><b>Detail Design</b></p> <p>T 07410377527 E smic@dd2d.co.uk</p>	
		<p>Scale <b>1:100 @ A3</b></p>	<p>Status <b>Planning</b></p>		




**Existing Front Elevation**  
Scale 1:100



**Existing Side Elevation**  
Scale 1:100




**Existing Rear Elevation**  
Scale 1:100

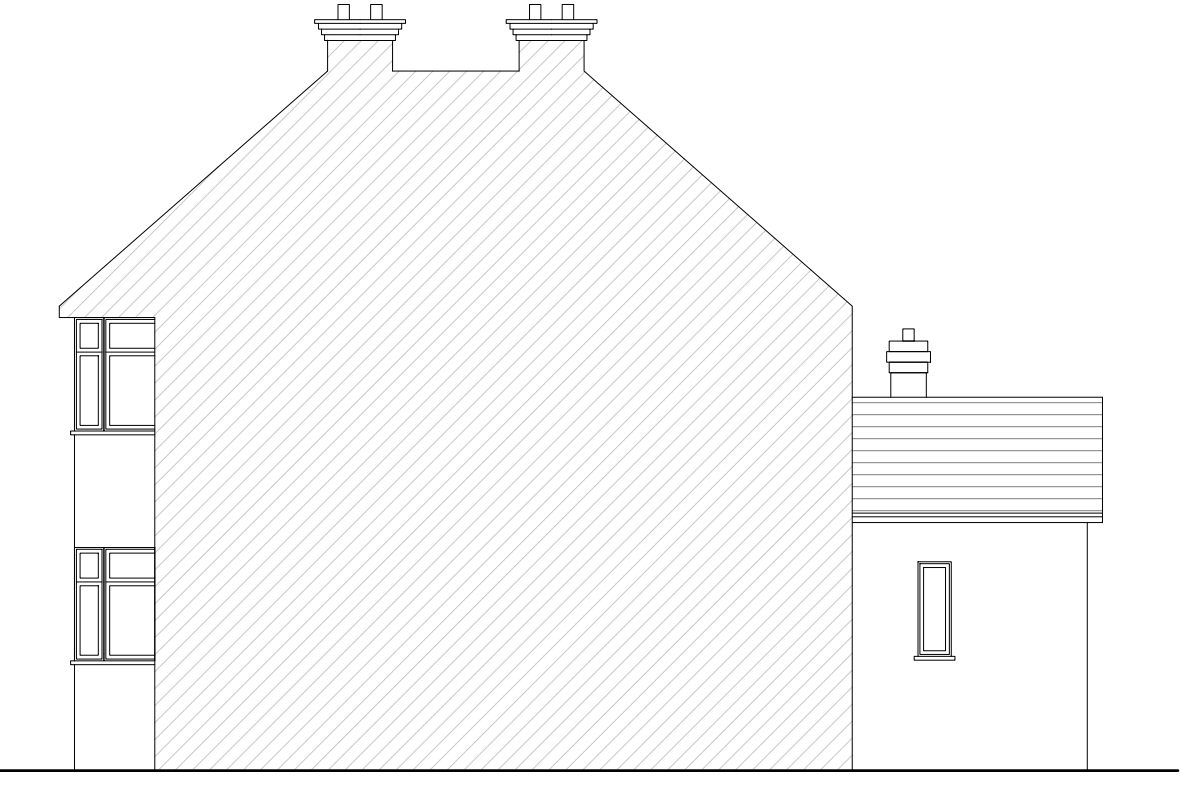

**Existing Side Elevation**  
Scale 1:100




<p><b>Notes</b></p> <p>All plans, sections &amp; elevations are based on measured readings and scaled dimension.</p> <p>Any discrepancies be reported immediately.</p> <p>To be read in conjunction with Structural Engineers' drawings and Mechanical and Electrical drawings</p> <p>All Materials To Match Existing</p>	<p><b>Revisions</b></p>	<p>Drawing name <b>Existing - Elevations</b></p>		<p>Drawing no <b>95 FP 04</b></p>	<p>Rev</p>
		<p>Project <b>95 Vera Avenue London N21 1RN</b></p>		<p><b>Detail Design</b></p> <p>T 07410377527 E smic@dd2d.co.uk</p>	
		<p>Scale <b>1:100 @ A3</b></p>	<p>Status <b>Planning</b></p>		

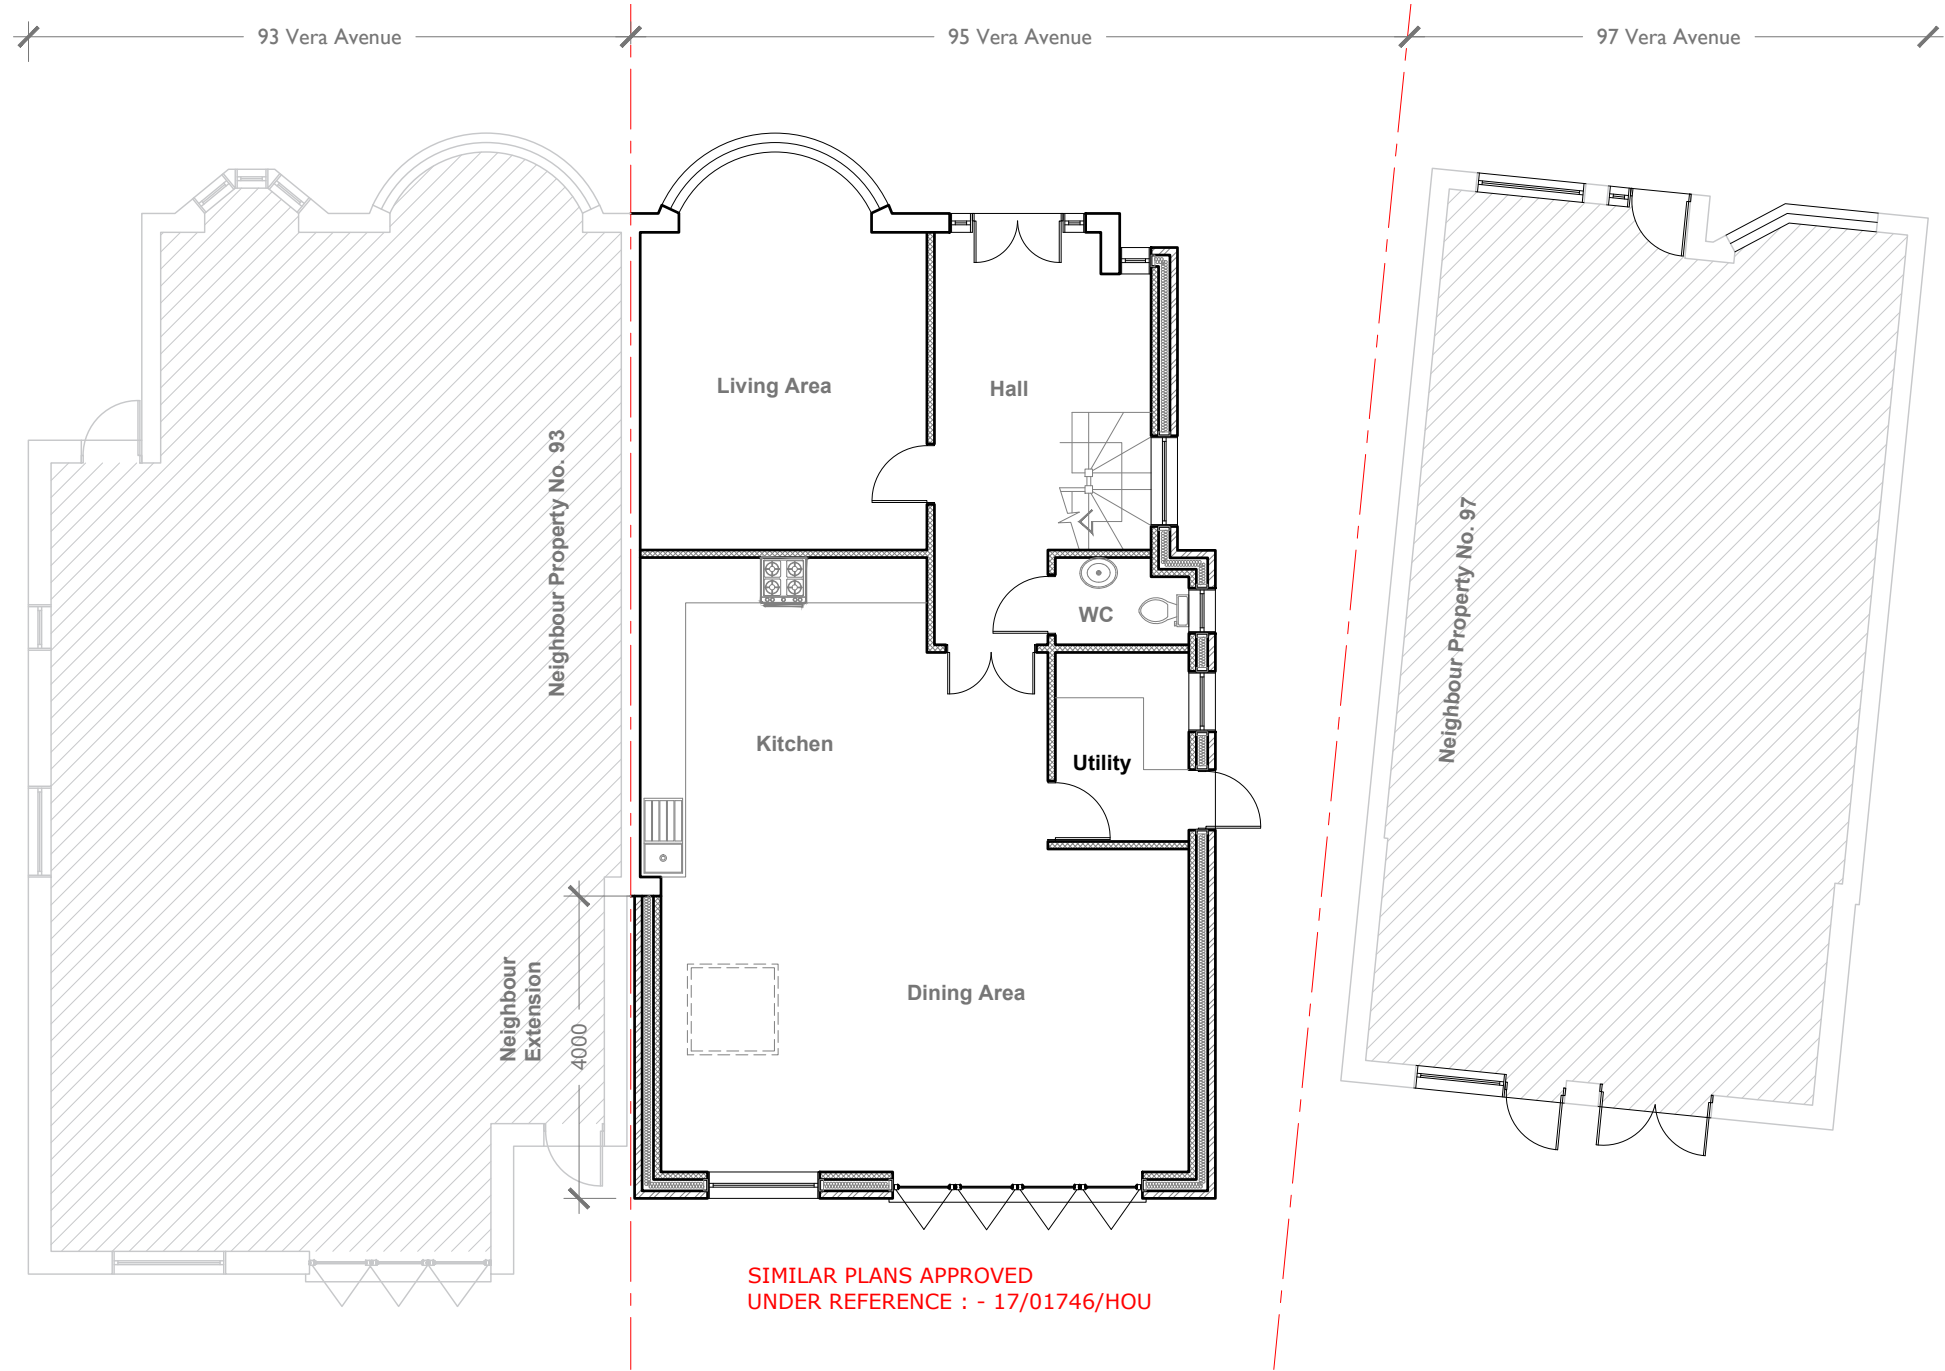


**Proposed Ground Floor Plan**  
Scale 1:100




<b>Notes</b> All plans, sections & elevations are based on measured readings and scaled dimension.  Any discrepancies be reported immediately.  To be read in conjunction with Structural Engineers' drawings and Mechanical and Electrical drawings  All Materials To Match Existing	<b>Revisions</b>	Drawing name <b>Proposed - Ground Floor Plan</b>		Drawing no <b>95 FP 05</b>	Rev
		Project <b>95 Vera Avenue London N21 1RN</b>		<h1>Detail Design</h1> <p>T 07410377527 E smic@dd2d.co.uk</p>	
		Scale <b>1:100 @ A3</b>	Status <b>Planning</b>		

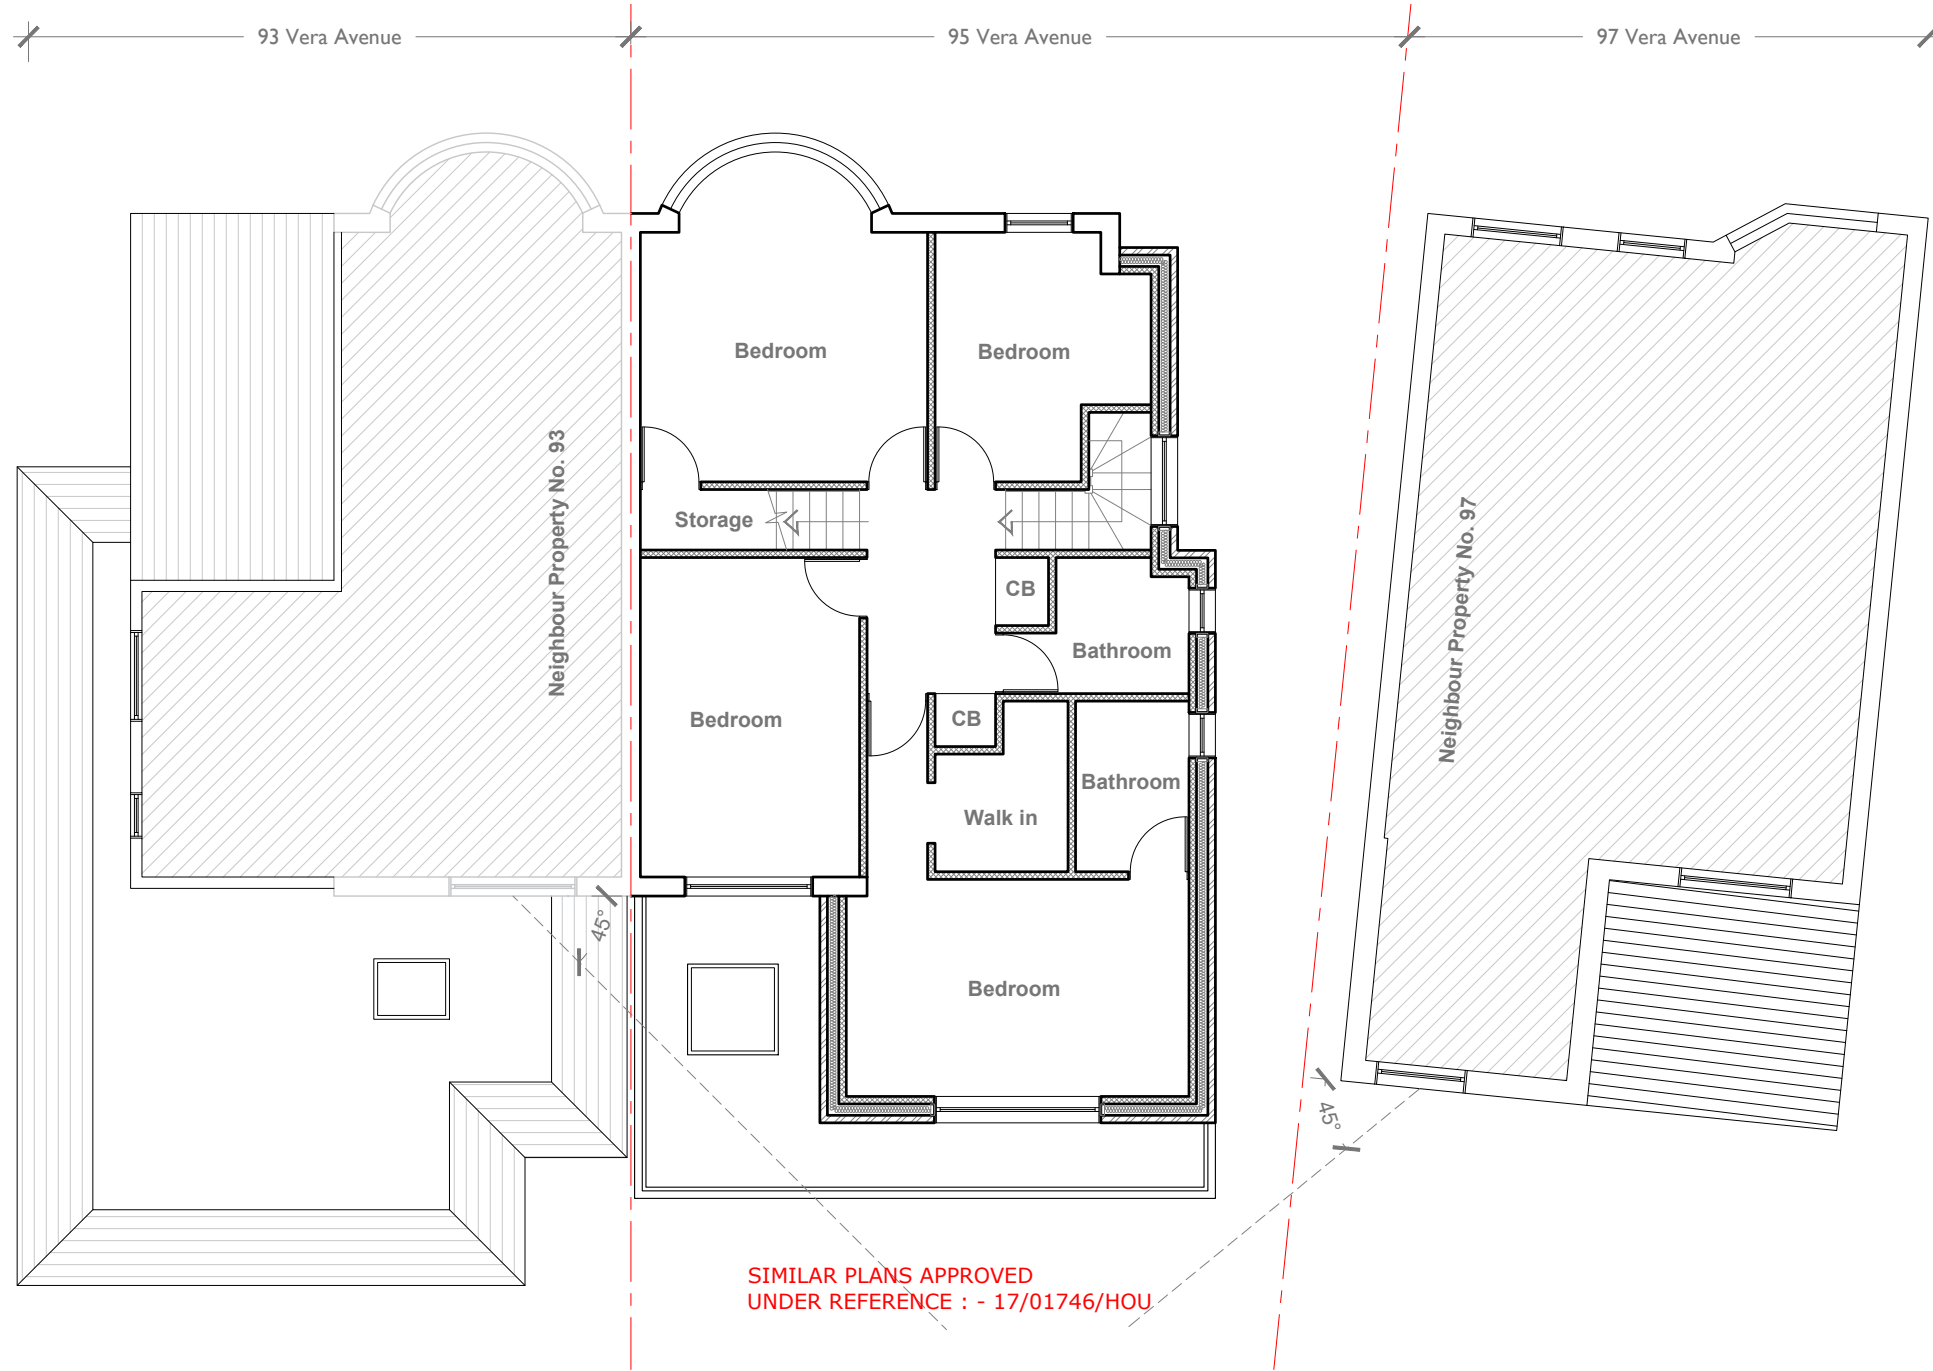


**Proposed First Floor Plan**  
Scale 1:100

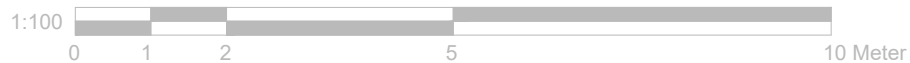


<b>Notes</b> All plans, sections & elevations are based on measured readings and scaled dimension.  Any discrepancies be reported immediately.  To be read in conjunction with Structural Engineers' drawings and Mechanical and Electrical drawings  All Materials To Match Existing	<b>Revisions</b>	Drawing name <b>Proposed - First Floor Plan</b>		Drawing no <b>95 FP 06</b>	Rev
		Project <b>95 Vera Avenue London N21 1RN</b>		<h1>Detail Design</h1> <p>T 07410377527 E smic@dd2d.co.uk</p>	
		Scale <b>1:100 @ A3</b>	Status <b>Planning</b>		

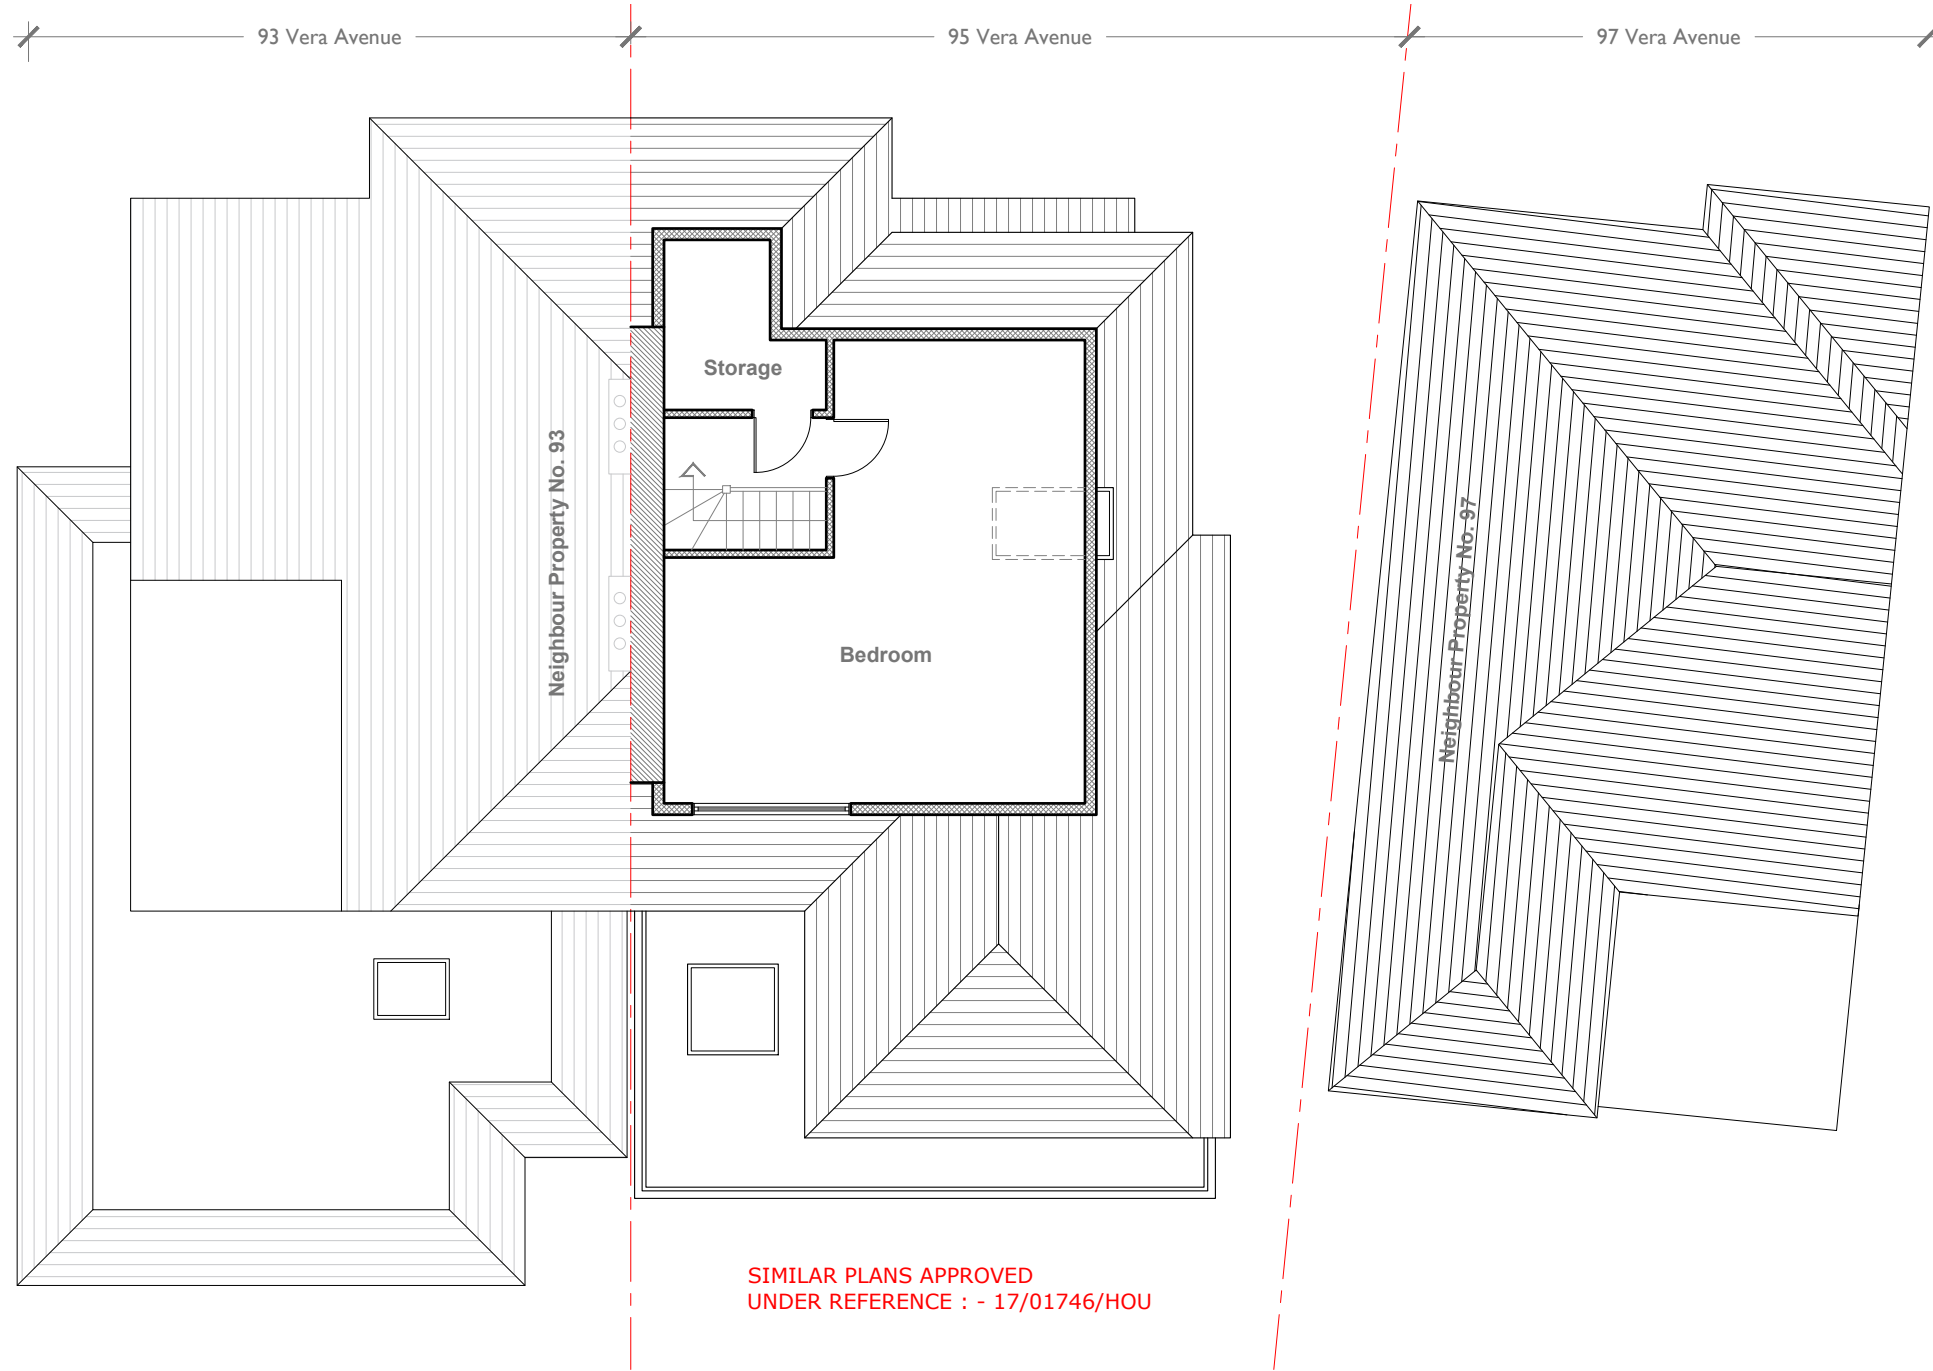


**Proposed Loft Floor Plan**  
Scale 1:100

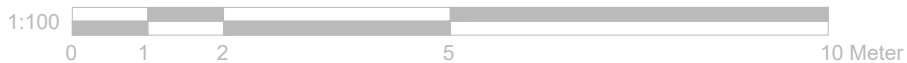

<b>Notes</b> All plans, sections & elevations are based on measured readings and scaled dimension.  Any discrepancies be reported immediately.  To be read in conjunction with Structural Engineers' drawings and Mechanical and Electrical drawings  All Materials To Match Existing	<b>Revisions</b>	Drawing name <b>Proposed - Loft Floor Plan</b>		Drawing no <b>95 FP 07</b>	Rev
		Project <b>95 Vera Avenue London N21 1RN</b>		<h1>Detail Design</h1> <p>T 07410377527 E smic@dd2d.co.uk</p>	
		Scale <b>1:100 @ A3</b>	Status <b>Planning</b>		

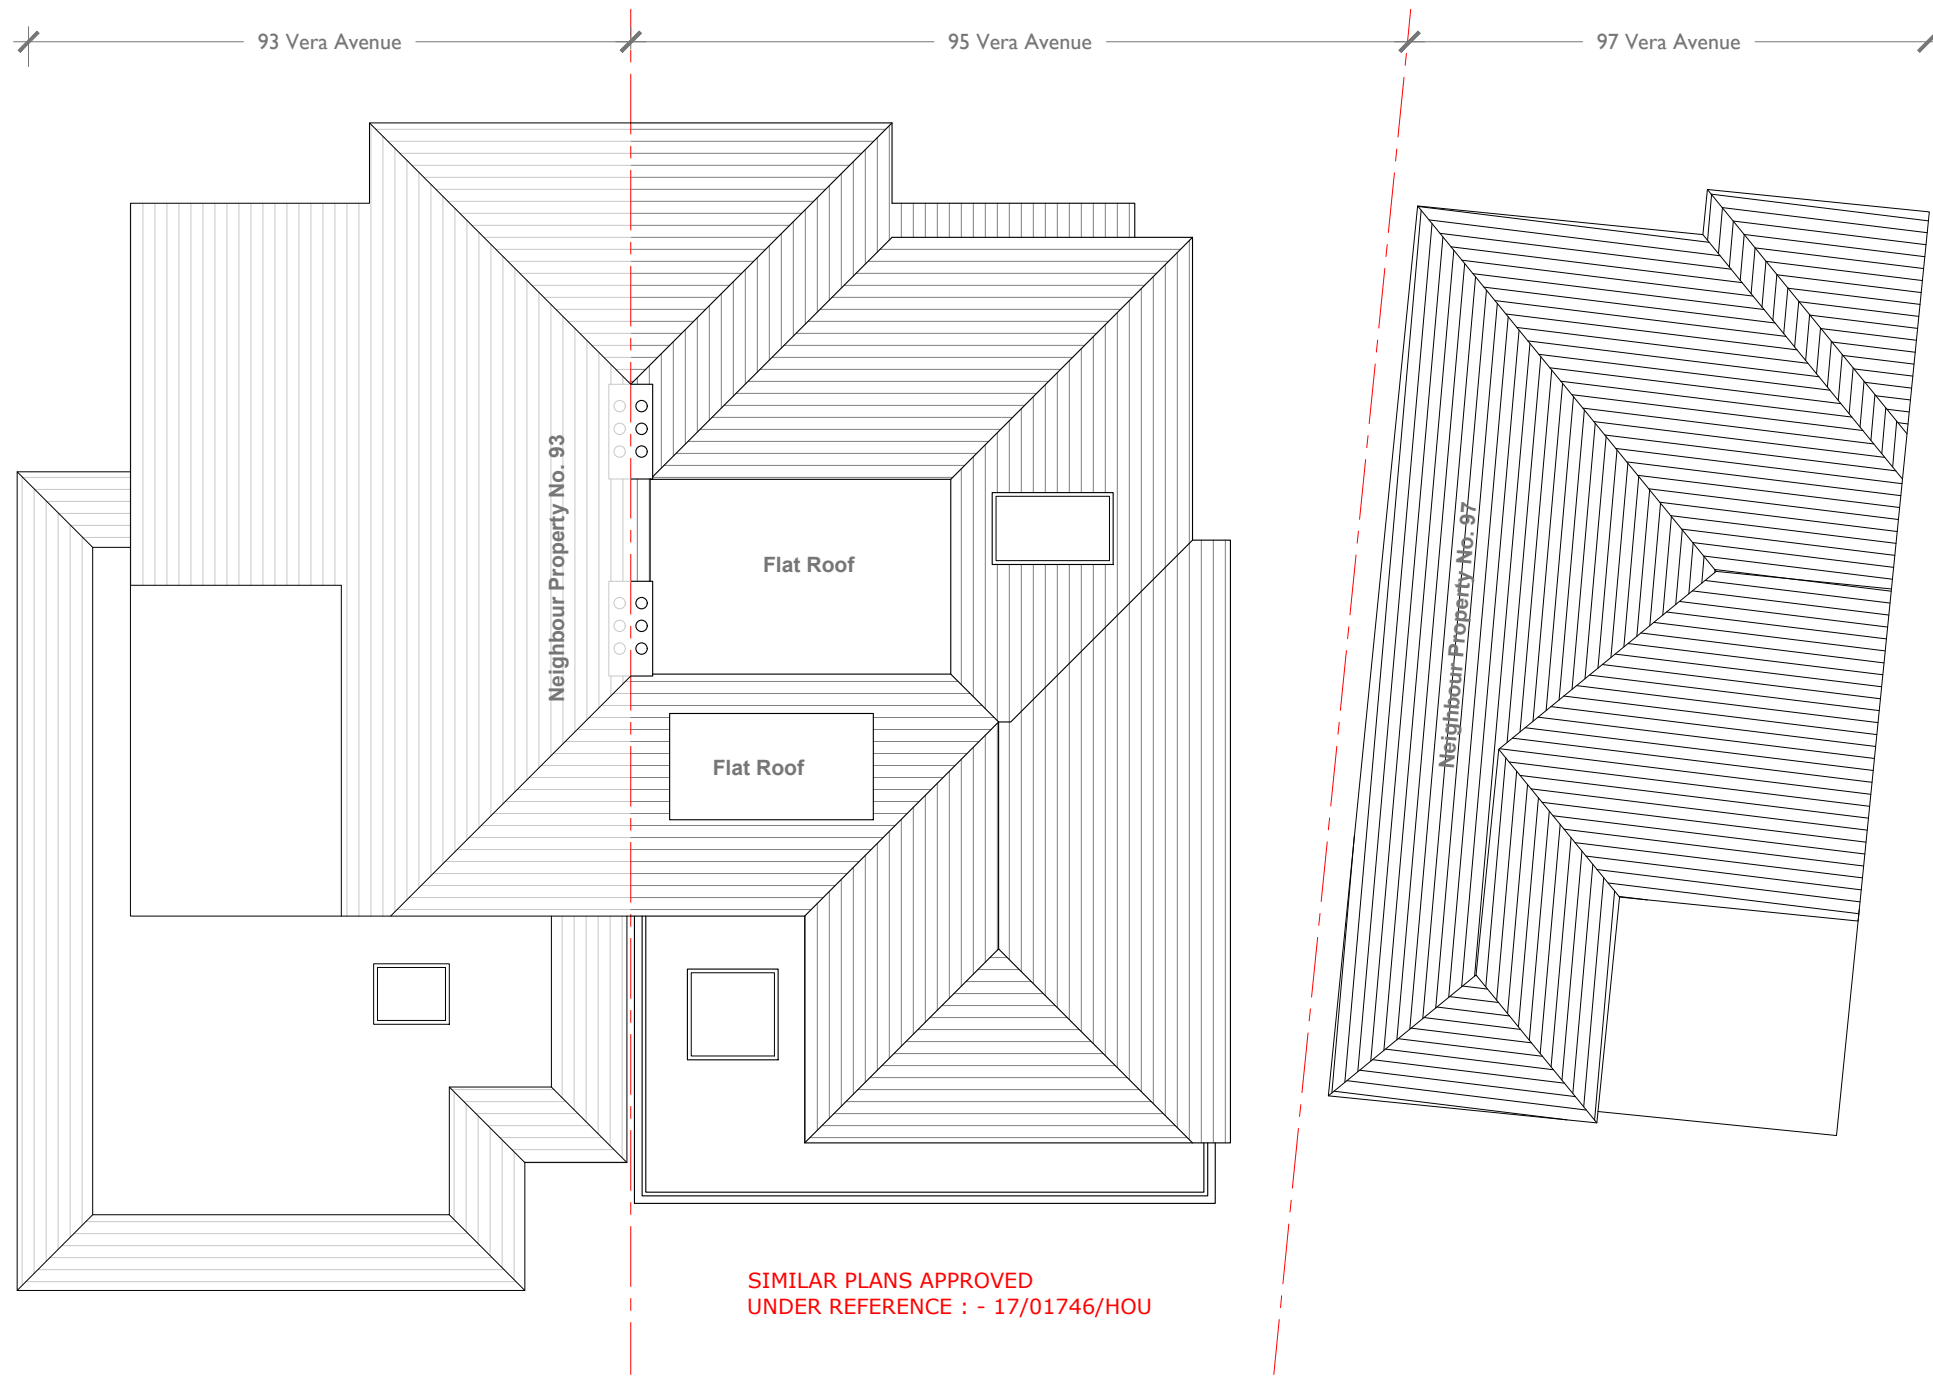

**Proposed Roof Plan**  
Scale 1:100

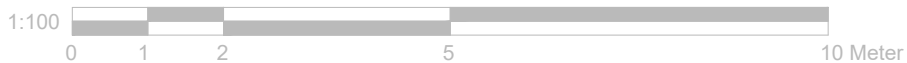

<b>Notes</b> All plans, sections & elevations are based on measured readings and scaled dimension.  Any discrepancies be reported immediately.  To be read in conjunction with Structural Engineers' drawings and Mechanical and Electrical drawings  All Materials To Match Existing	<b>Revisions</b>	Drawing name <b>Proposed - Roof Plan</b>		Drawing no <b>95 FP 08</b>	Rev
		Project <b>95 Vera Avenue London N21 1RN</b>		<h1>Detail Design</h1> <p>T 07410377527 E smic@dd2d.co.uk</p>	
		Scale <b>1:100 @ A3</b>	Status <b>Planning</b>		