




FLOW CONTROL MANHOLE

ELEVATION ON HYDRO-BRAKE

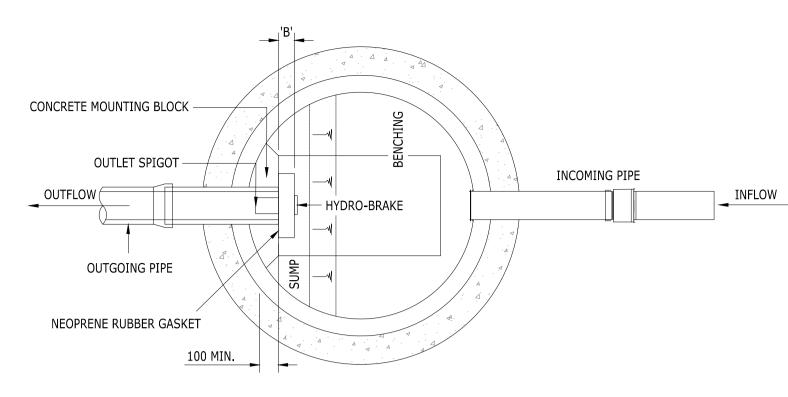


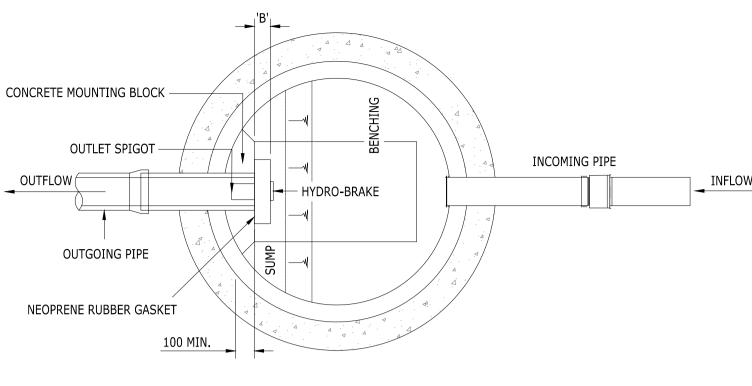

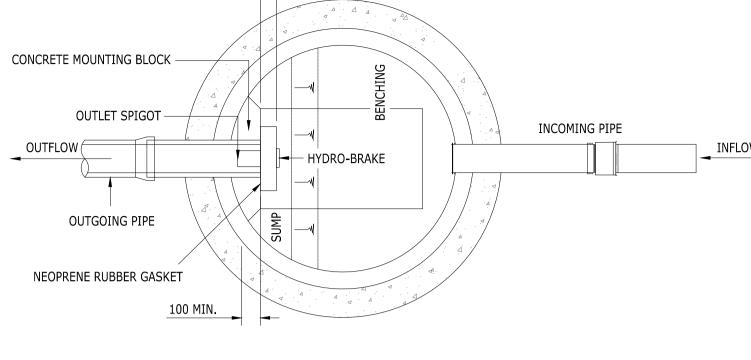

PLAN ON FLOW CONTROL MANHOLE SCALE 1:20

ADOPTED HYDRO-BRAKE DIMENSION TABLE - (ALL DIMENSIONS IN mm)									
MANHOLE REFERENCE	HYDRO INTERNATIONAL HYDRO-BRAKE REFERENCE	'A' (HYDRO-BRAKE WIDTH)	'B' (HYDRO-BRAKE DEPTH)	'C' (SUMP DEPTH)	'D' (SUMP WIDTH)	'E' (MOUNTING BLOCK WIDTH)	'F' (MOUNTING BLOCK HEIGHT)		
SW6	MD-SHE-0067-3000-2461-3000	410	75	310	150	615	755		
SW7	MD-SHE-0074-3000-1619-3000	450	80	325	160	655	800		

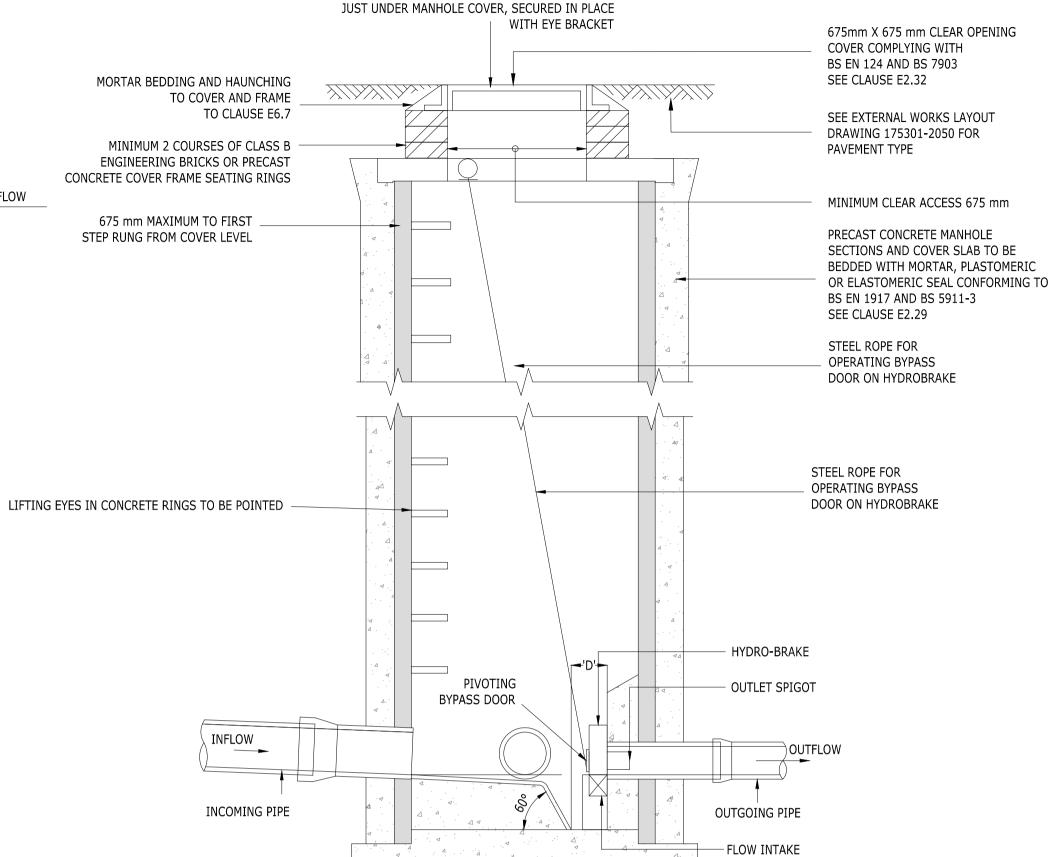

ACCESS COVER TO BE LOCATED ABOVE BYPASS DOOR.

PULL HANDLE ON END OF STEEL ROPE TO BE LOCATED

TYPICAL DETAIL FLOW CONTROL MANHOLE

GENERAL NOTES:

- THIS DRAWING SHOULD BE REVIEWED TOGETHER WITH ALL OTHER DRAWINGS, ENGINEERING DETAILS, SPECIFICATIONS, AND ANY RELEVANT SPECIALIST DOCUMENTS. ANY INCONSISTENCIES OR DISCREPANCIES SHOULD BE REPORTED TO ARDENT CONSULTING ENGINEERS.
- DO NOT SCALE FROM THIS DRAWING. WORK FROM FIGURED DIMENSIONS ONLY. ALL DIMENSIONS SHOWN ON THIS DRAWING ARE IN MILLIMETRES UNLESS
- OTHERWISE STATED. PRIOR TO COMMENCING WORK ON THE SITE, THE CONTRACTOR IS RESPONSIBLE FOR VERIFYING AND CONFIRMING ALL BUILDING AND SITE DIMENSIONS AND LEVELS, INCLUDING EXISTING SEWER INVERT LEVELS. THE CONTRACTOR MUST COMPLY WITH
- CURRENT BUILDING LEGISLATION, BRITISH STANDARDS, BUILDING REGULATIONS, AND OTHER RELEVANT REQUIREMENTS. NO DEVIATION FROM THE DETAILS SHOWN ON THIS DRAWING IS PERMITTED
- WITHOUT PRIOR PERMISSION FROM THE ENGINEER.
 ALL MATERIALS AND WORKMANSHIP SHALL COMPLY FULLY WITH THE MANUAL OF CONTRACT DOCUMENTS FOR HIGHWAY WORKS, VOLUME ONE, (MCHW1)
- SPECIFICATION FOR HIGHWAY WORKS. THE CONTRACTOR SHALL UNDERTAKE SUCH MATERIALS TESTING AS INDICATED IN
- THE SPECIFICATIONS AND SHALL INCLUDE THE COST OF TESTING IN THE TENDER. THE CONTRACTOR MUST SURVEY AND VERIFY THE LOCATION OF EXISTING SERVICES
- AND STATUTORY UNDERTAKERS APPARATUS THAT INTERSECT PROPOSED EXCAVATIONS BEFORE BEGINNING ANY WORK. . WHERE NECESSARY, ALL EXCAVATED MATERIAL SHALL BE DISPOSED OF AT AN APPROVED TIP OFF-SITE.
- THE PUBLIC HIGHWAY AND WORKS WILL BE KEPT CLEAN AND FREE OF DEBRIS BY USE OF WHEEL WASHING FACILITIES AND ROAD SWEEPERS TO THE COUNCIL'S
- 10. ALL SETTING OUT, COVERS AND BOX COVERS SHALL BE AGREED ON-SITE WITH THE ENGINEER, PRIOR TO THE COMMENCEMENT OF THE WORKS. .. THIS DRAWING IS PRESENTED IN SCHEMATIC FORM TO PROVIDE CLARITY ONLY. DUE TO SITE CONDITIONS, PIPE RUNS AND MANHOLE LOCATIONS MAY DIFFER ON-SITE.

CONSTRUCTION NOTES:

- ALL SOFT SPOTS AND VOIDS SHALL BE REMOVED BEFORE CONSTRUCTION AND REPLACED WITH SUITABLE FILL MATERIAL.
- ROAD FORMATION TO BE IN ACCORDANCE WITH CLAUSE 616 AND COMPACTED IN ACCORDANCE WITH TABLE THE REQUIREMENTS OF 6/4 OF THE SPECIFICATION FOR HIGHWAY WORKS - SERIES 600 EARTHWORKS.
- A RESIDUAL TRANSLOCATED TOTAL HERBICIDE WITH SOME CONTACT EFFECT, BUT NON-POISONOUS TO HUMAN BEINGS, ANIMALS AND INSECTS SHALL BE SPRAY APPLIED TO ALL FORMATIONS. THE PROPOSED HERBICIDE TO BE USED BY THE CONTRACTOR MUST FIRST OBTAIN ITS APPROVAL BY THE HIGHWAY AUTHORITY.
- 4. ALL CONCRETE AND CEMENT MORTAR MUST BE SULPHATE RESISTING TO BS 4021. . MINIMUM DEPTH OF 450mm CONSTRUCTION IS REQUIRED FOR NON-FROST SUSCEPTIBLE MATERIAL.
- . FOR ALL BITUMINOUS MATERIALS, TRANSPORTATION, LAYING, COMPACTION AND TYPE TESTING PROTOCOLS SHALL CONFORM TO BS 594987: 2010. BOND COATS SHALL BE APPLIED BETWEEN BOUND LAYERS OF BITUMINOUS MATERIALS BY METERED MECHANICAL SPRAYING EQUIPMENT, SPRAY TANKER OR SPRAYING DEVICE INTEGRAL WITH THE PAVING MACHINE. BOND COATS SHALL HAVE BBA CERTIFICATION AND COMPLY WITH CLAUSE 920 OF MCHW1.

THE ATTENTION OF THE CLIENT AND THE PRINCIPAL CONTRACTOR IS DRAWN TO THE FOLLOWING POTENTIAL RISKS IN CONJUNCTION WITH THE PROPOSED ON-SITE AND OFF-SITE WORKS AS DESIGNED FOR THIS PROJECT:

- WORKS IN THE VICINITY OF LIVE SERVICES WILL BE NECESSARY AND THE ADVICE OF ALL STATUTORY SERVICE COMPANIES MUST BE SOUGHT BEFORE ANY WORKS
 - WORKS WITHIN AND ABUTTING THE EXISTING HIGHWAY WILL ENTAIL TRAFFIC HAZARDS AND ALL APPROPRIATE SAFETY MEASURES INCLUDING BARRIERS, SIGNS AND LIGHTING MUST BE UNDERTAKEN TO THE APPROVAL OF THE LOCAL AUTHORITY, THE HIGHWAY AUTHORITY AND THE POLICE. HAZARDOUS MATERIALS INCLUDING CEMENT AND BITUMINOUS MATERIALS ARE
- SPECIFIED AND THE MANUFACTURER'S ADVICE ON SAFE HANDLING PROCEDURES MUST BE OBTAINED AND MADE CLEAR TO ALL OPERATIVES. THE CONTRACTOR WILL BE RESPONSIBLE FOR LOCATING ALL EXISTING SERVICES WITHIN THE VICINITY OF THE WORKS AND ENSURE THESE ARE PROTECTED THROUGHOUT THE DURATION OF THE WORKS. ALL UTILITY PLANT SHOULD BE CLEARLY
- MARKED ON THE GROUND PRIOR TO COMMENCEMENT OF THE WORKS. . THE CONTRACTOR MUST ENSURE ALL WORKING AREAS ARE FULLY SECURE. 6. REFER TO DESIGNER'S RISK ASSESSMENT DOCUMENT WITH REFERENCE XXXX

1. THE WORKS THAT ARE INTENDED TO BE ADOPTED THROUGH A SECTION 104 AGREEMENT MUST COMPLY WITH THE SEWER SECTOR GUIDANCE (JUNE 2022), RELEVANT APPENDICES AND MEET THE REQUIREMENTS OF THE DRAINAGE AUTHORITY.

- ANY WORKS CARRIED OUT ON-SITE BEFORE RECEIVING TECHNICAL APPROVAL FOR SECTION 104 AND SECTION 38 AGREEMENTS (INCLUDING STREET LIGHTING APPROVAL) WILL BE ENTIRELY AT THE DEVELOPER'S RISK.
- PRIOR TO THE COMMENCEMENT OF STREETLIGHT ERECTION, THE LOCAL AUTHORITY MUST APPROVE AND AGREE ON THE ON-SITE PEGGING OF STREETLIGHT POSITIONS.

FOR APPROVAL

Rev	Description	Drn	Chk	Арр	Date
ΡΊ	FIRST ISSUE	MAC	AC	AD	03.03.
P2	SECTION 104 SUBMISSION	AMC	AMC	AD	10.08.
Dζ	SECTION 104 SUBMISSION - UPDATED MANHOLE CLEAR OPENINGS FROM 600x600 TO 675x675	АМС	AMC	AD	25.08.
DΔ	SECTION 104 SUBMISSION - UPDATED MANHOLE CLEAR OPENINGS FROM 600x600 TO 675x675		AMC	AD	18.09.23

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Third Floor

COTSWOLD HOMES LTD

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SECTION 104 ADOPTABLE **CONSTRUCTION DETAILS - SHEET 3**

A1 Scale		Date	Designed by			
	NTS	MARCH 2023	MAC			
Drawn by		Checked by	Approved by			
	MAC	MAC	AD			
Drawing Number 2105140-132						

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