

Do not scale from this drawing.

SAFETY HEALTH AND ENVIRONMENTAL INFORMATION

IN ADDITION TO THE HAZARD/RISKS NORMALLY ASSOCIATED WITH THE TYPES OF WORK DETAILED ON THIS DRAWING, NOTE THE FOLLOWING RISKS AND INFORMATION.

RISKS LISTED HERE ARE NOT EXHAUSTIVE. REFER TO DESIGN ASSESSMENT FORM NO. DAF01

CONSTRUCTION:
LIVE PRIMARY ROUTE TRAFFIC (B9039).
UTILITIES TO BE DIVERTED/PROTECTED


DEMOLITION:
NONE THAT WOULD NOT BE APPARENT TO A COMPETENT CONTRACTOR

FOR INFORMATION RELATING TO USE, CLEANING AND MAINTENANCE SEE THE HEALTH AND SAFETY FILE.


IT IS ASSUMED THAT ALL WORKS WILL BE CARRIED OUT BY A COMPETENT CONTRACTOR WORKING, WHERE APPROPRIATE, TO AN APPROVED METHOD STATEMENT.

Notes:


- All dimensions on this drawing are in metres unless noted otherwise. Do not scale from this drawing, only written dimensions are to be used.
- This drawing is to be read in conjunction with all architectural and engineering drawings, details and specifications.
- All work to comply with Highland Council's Roads and Transport Guidelines for New Developments.
- Prior to roads construction works, the appointed Contractor is to submit laboratory CBR & PSD test results and details of any capping requirements to the roads officer at Highland Council who is processing the Road Construction Consent application.
- Road signs and markings to be in accordance with the Traffic Signs Regulations And General Directions 2016.
- The contractor is responsible for checking the line and level of existing services prior to the commencement of works. Any discrepancies from design information must be reported to the Site Manager and Site Engineer in writing.
- Any discrepancies should be reported to the engineer immediately so clarification can be sought.
- All existing services to be located prior to any construction work being carried out. The locating of any mains and services must be undertaken by hand dug trial holes. The approval of the appropriate utility must be sought before any mechanical plant is used.
- Underground services must be located in accordance with Health and Safety Executive Guidance note HSG 47.
- Overhead services stand off and safe working areas must be implemented per the guidance in Health and Safety Executive Guidance Note GS6.
- The information provided on this drawing about the existing utility services is based on plans provided by the statutory utilities (July 2023). The actual position and status of any mains and services must be verified and established on site. This drawing is provided for information only.
- For clarity existing plant is represented by single continuous lines. Please note, this does not indicate the number of cables, ducts and pipes that may exist in the location indicated.
- For additional clarity this drawing should only be printed and read in colour.
- Utility stand-offs are to be confirmed with the relevant utility providers for all underground and overhead utilities, prior to construction work commencing.

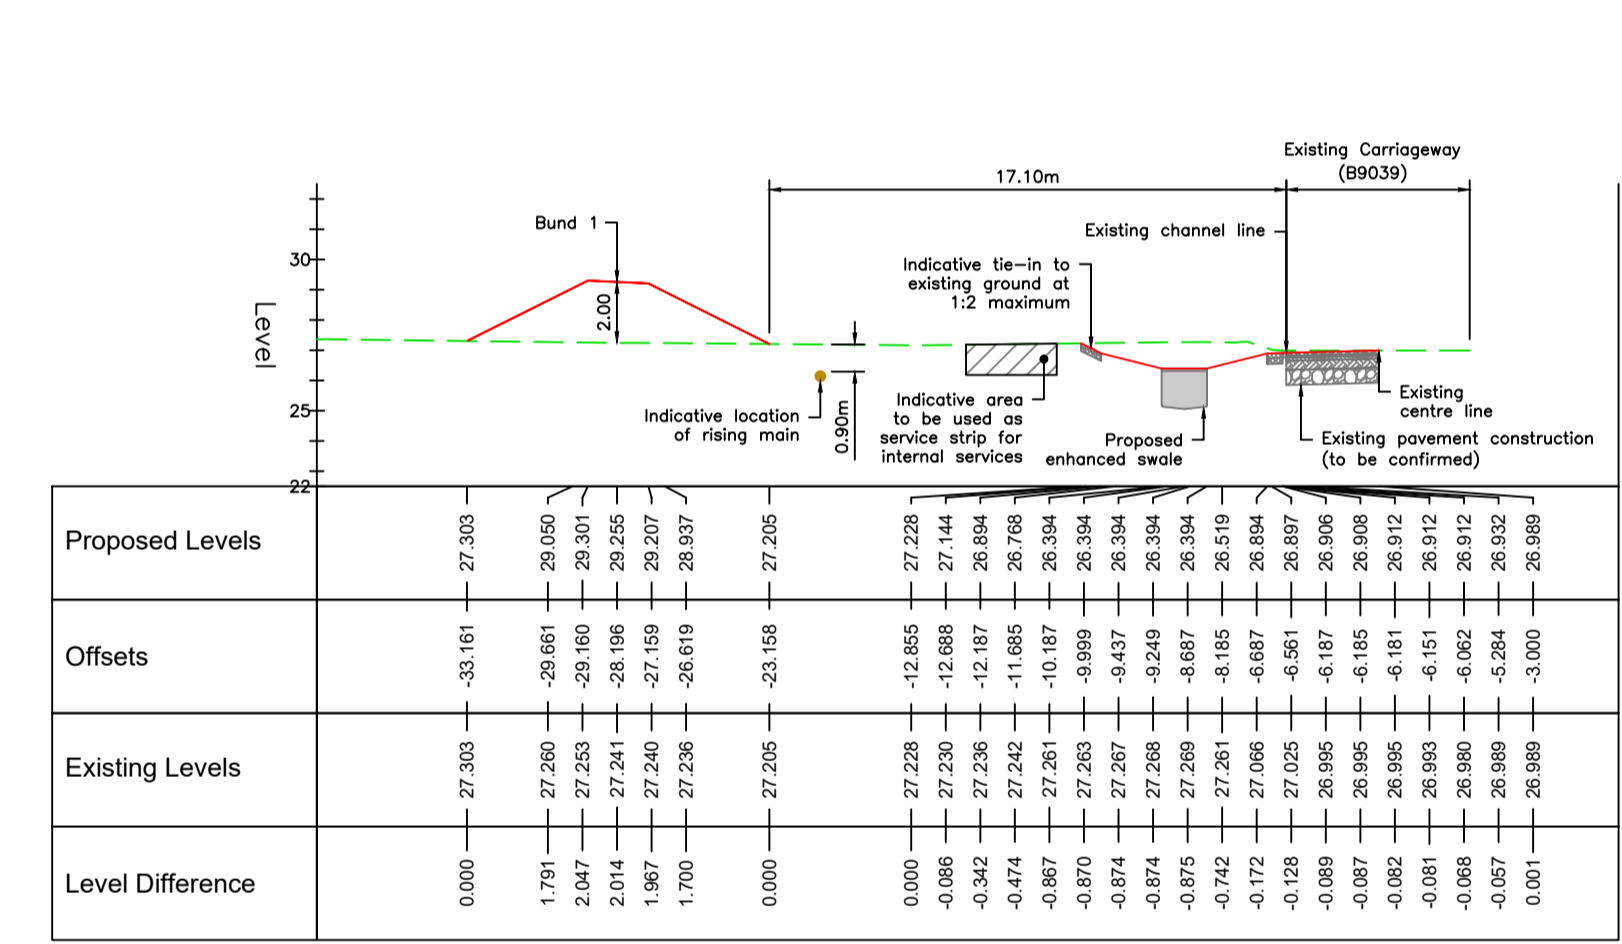


Section A
Scale 1:250

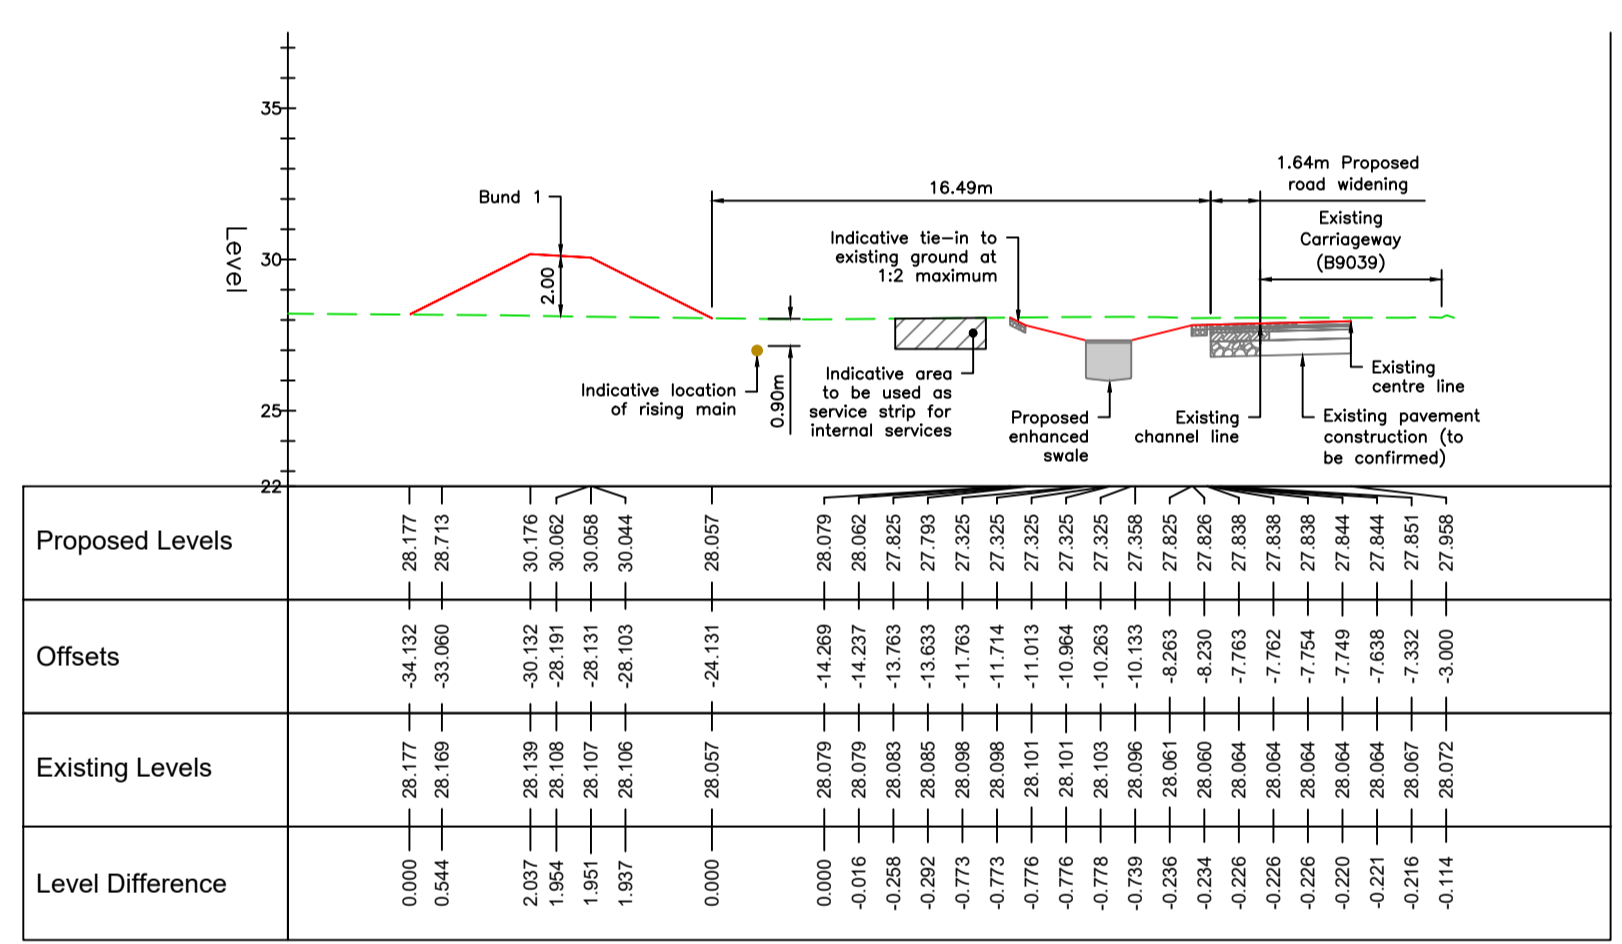


Section B
Scale 1:250

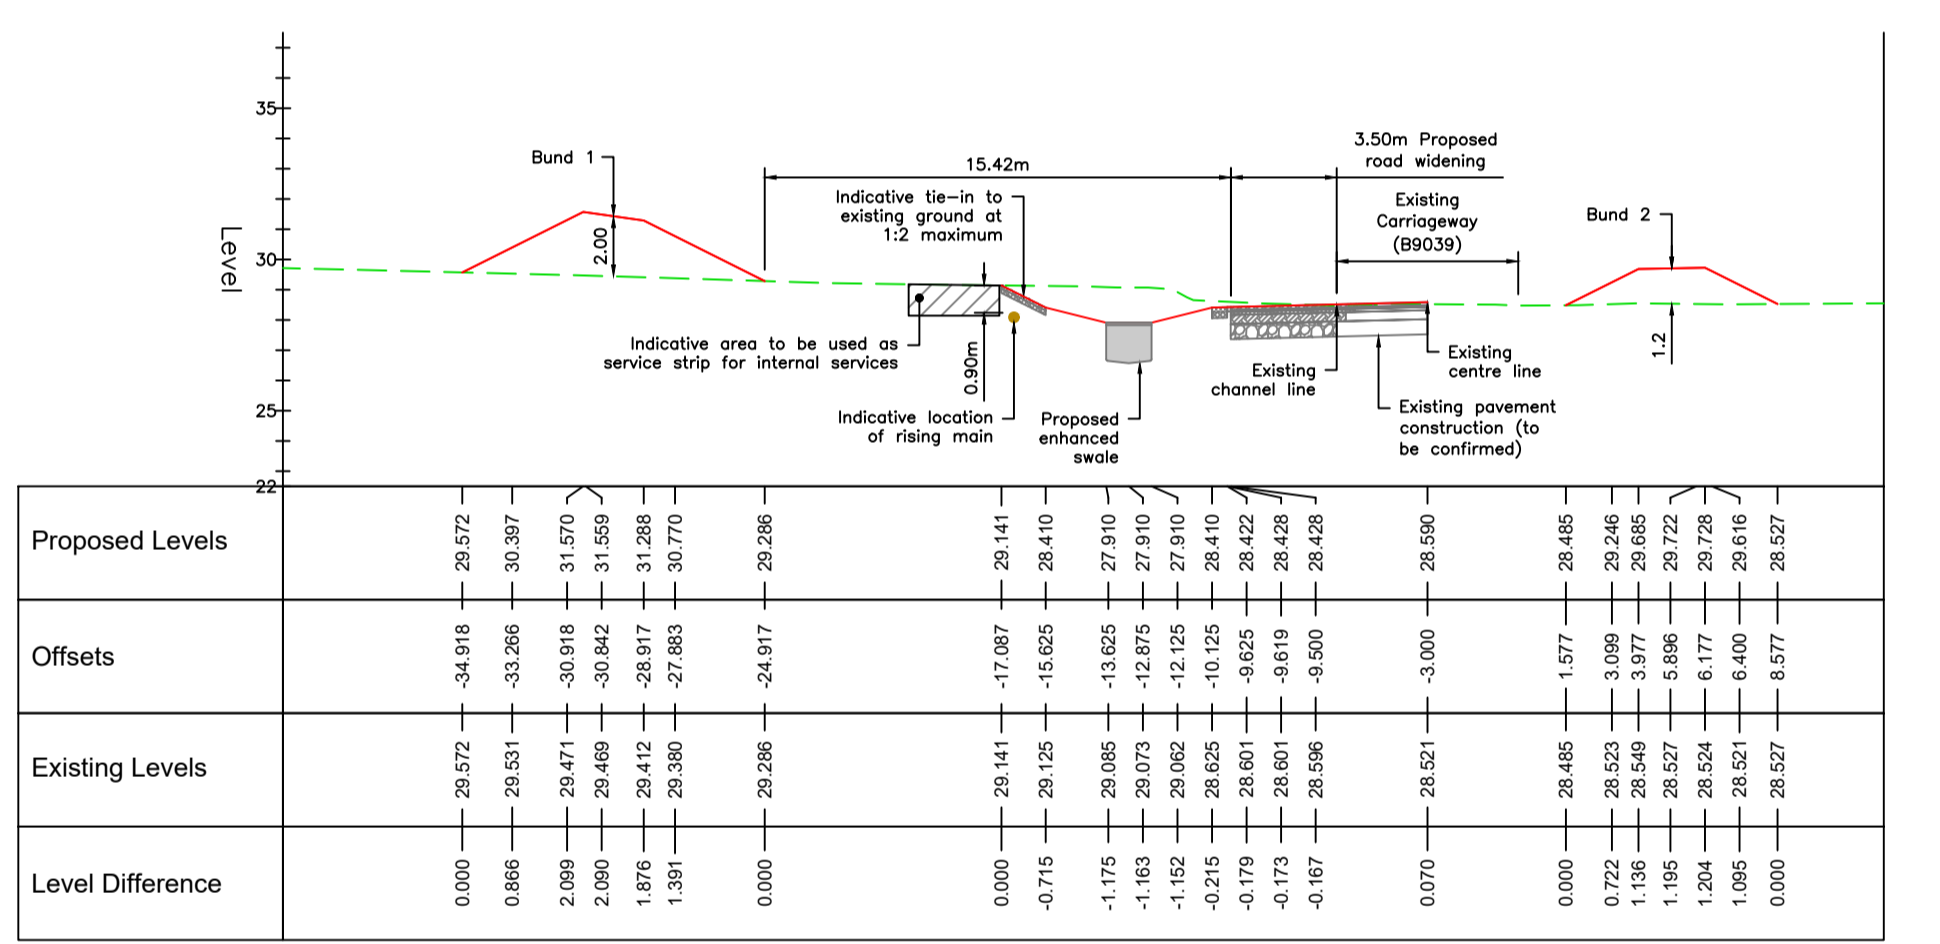

Section C
Scale 1:250

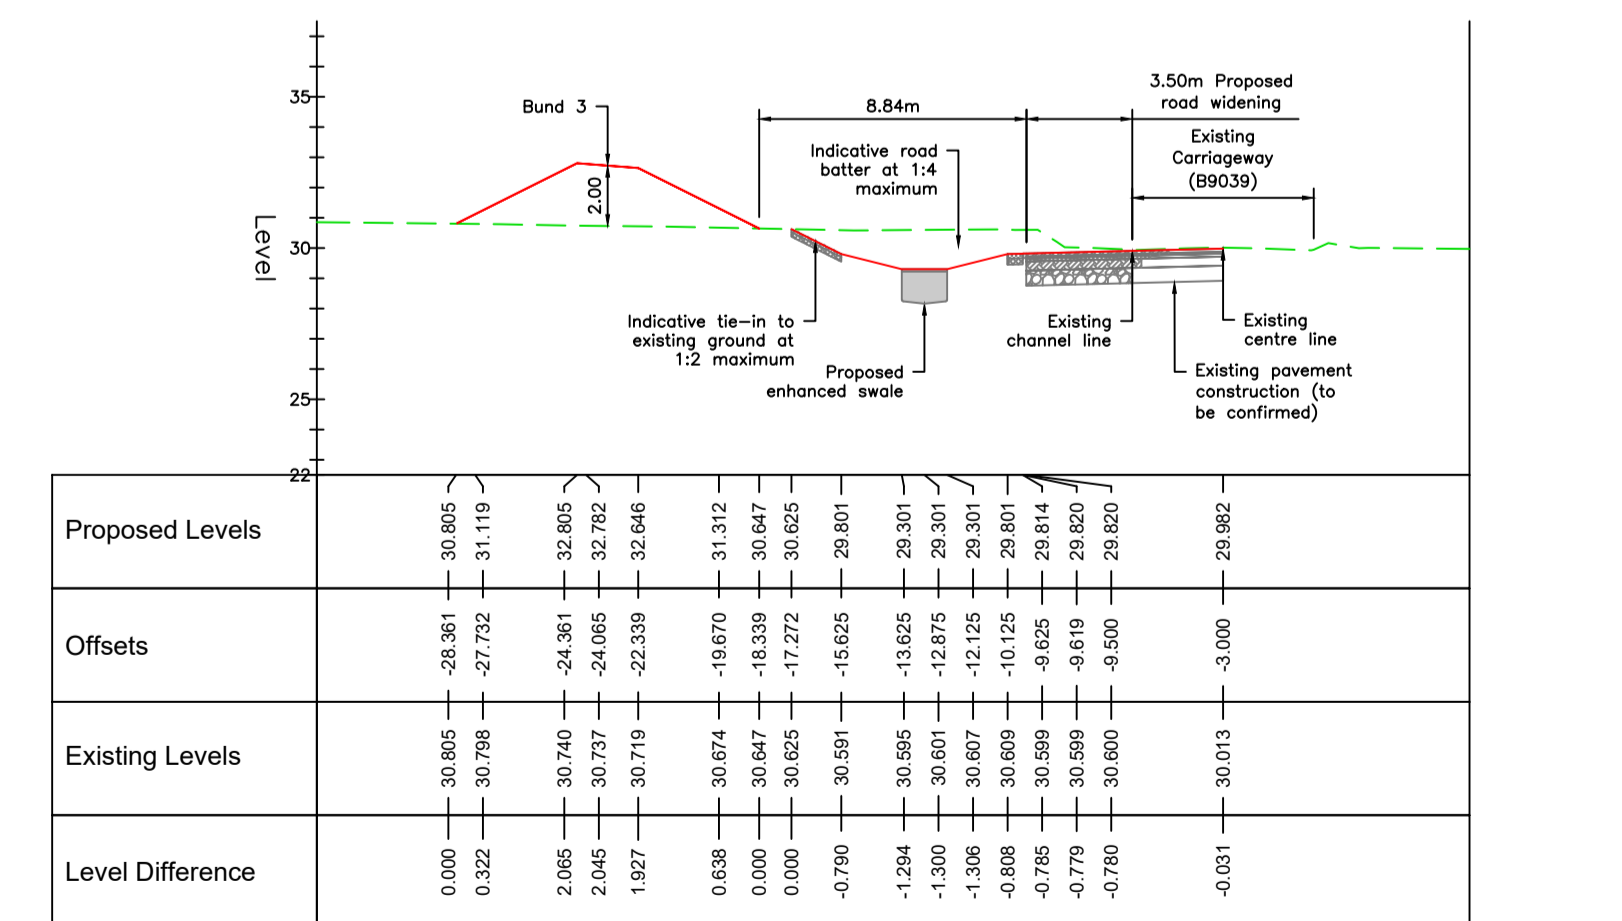

Section D
Scale 1:250

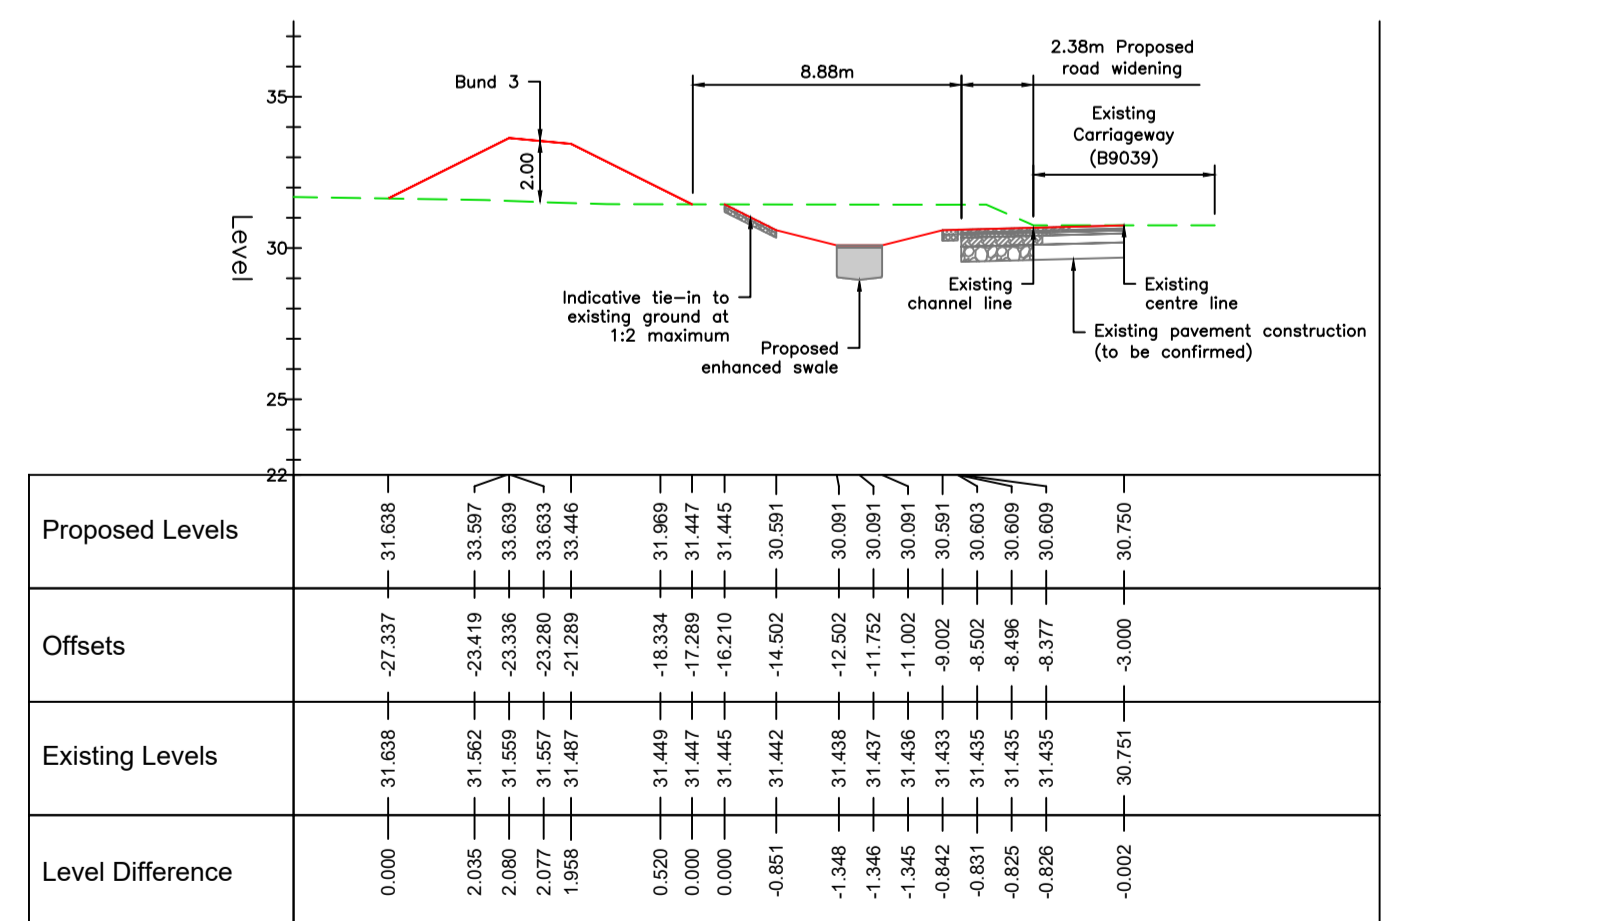

Section E
Scale 1:250

Refer to drawing 154163-PC-1120 for New road to Existing Road Tie-in Detail

Legend:

- Proposed Road Surfacing
- Existing Road Surfacing
- Proposed Landscaped Area/Grassed Verge
- Proposed 1m Bio-Retention
- Proposed Infiltration Trench Underlying Enhanced Swale
- Proposed Rising Foul Main
- Proposed Foul Water Sewer
- Proposed Surface Water Sewer
- Proposed Surface/ Foul Manhole (MH)/Inspection Chamber (IC)
- Proposed Gully
- Existing Gully
- Existing Gully to be Removed

Cross Section Legend:

- Proposed Finished Ground Level
- Existing Ground Level
- Indicative Electricity
- Indicative Water
- Indicative Telecom (Openreach)
- Scottish Water Distribution Main
- Scottish Water Foul Sewer
- Openreach Underground
- Openreach Box
- Scottish Water Foul Chamber

A	11.03.23	Drawing title and legend updated. Road side swales added. Indicative service route and sections updated.	HF	AH	AKF
Rev.	Date	Description	Drawn	Chkd.	Appd.

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Project Title: **Cabot Highlands**

Drawing Title: **Upgraded Access Road Widening Sections**

Scale at A1: As Shown	Status: Road Construction Consent
Drawn: HF	Checked: AH
Date: 11/07/2023	Date: 21/09/2023
Approved: AKF	Date: 21/09/2023

Drawing No.: 154163-PC-1102

Revision: A