

**FP1** **GROUND FLOOR PLAN**  
SCALE: 1:100 @ A3 **EXISTING**



**place for  
humans**


**3 WOBURN RISE,  
NG5 4PS.**

**EXISTING  
FLOOR PLAN**


SCALE: 1:100 @ A3

**A3.1**


DRAWN BY: **Joe Robertshaw**

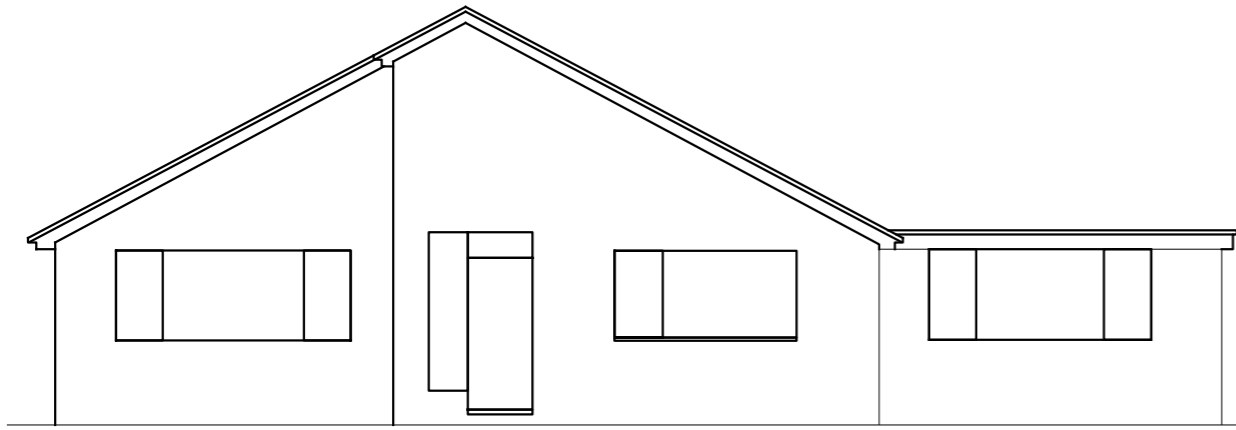


**E1** FRONT ELEVATION  
SCALE: 1:100 @ A3  
**EXISTING**

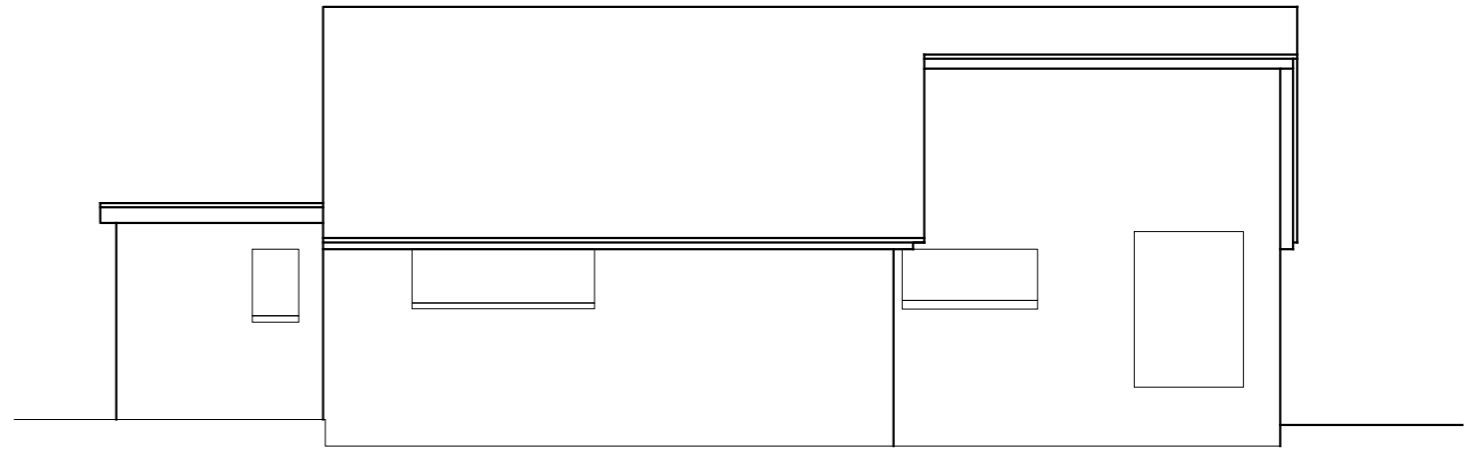

**E2** SIDE ELEVATION  
SCALE: 1:100 @ A3  
**EXISTING**

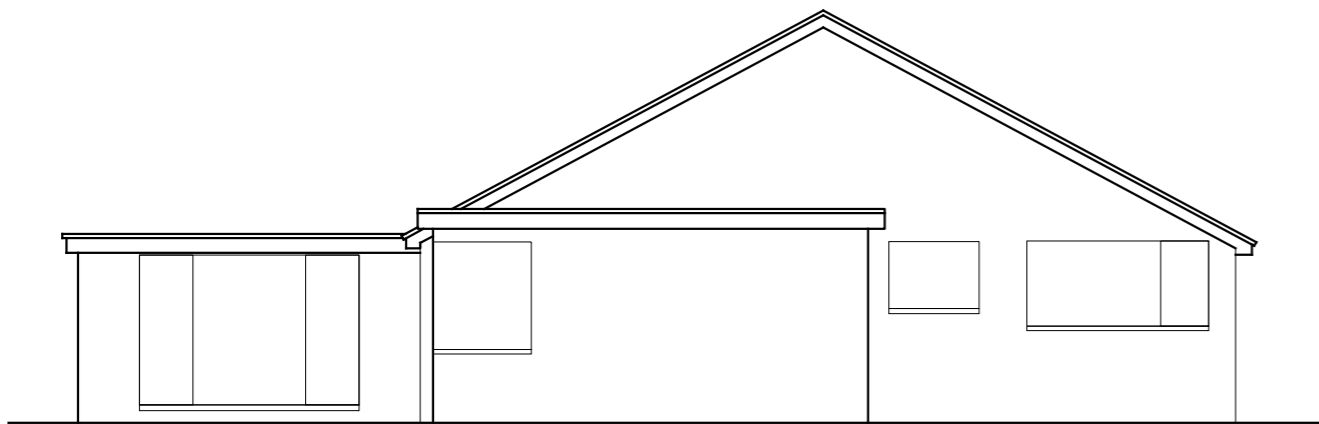

**E3** REAR ELEVATION  
SCALE: 1:100 @ A3  
**EXISTING**

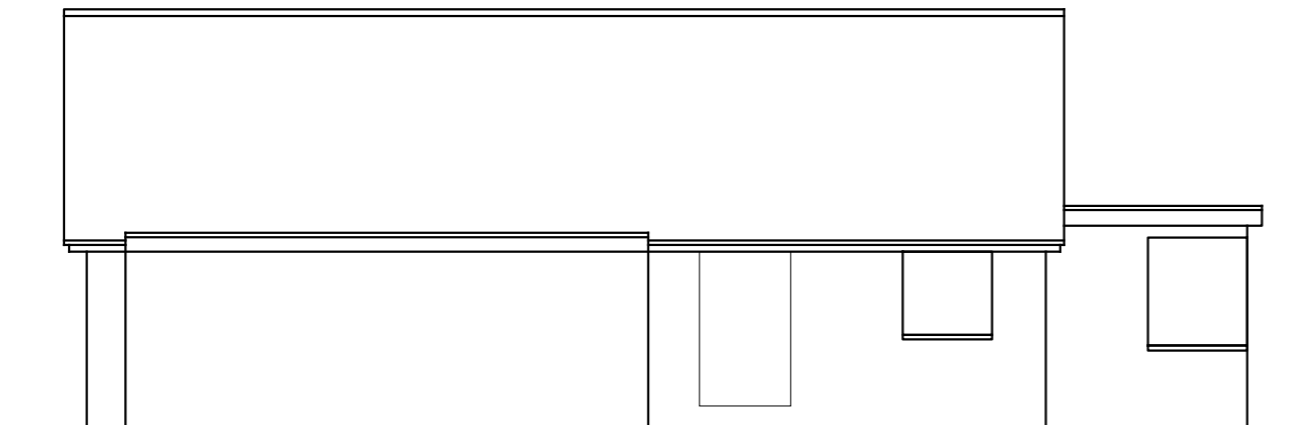

**E4** SIDE ELEVATION  
SCALE: 1:100 @ A3  
**EXISTING**



**place for humans**


**3 WOBURN RISE,  
NG5 4PS.**

**EXISTING  
ELEVATIONS**


SCALE: 1:100 @ A3

**A3.2**

DRAWN BY: **Joe Robertshaw**

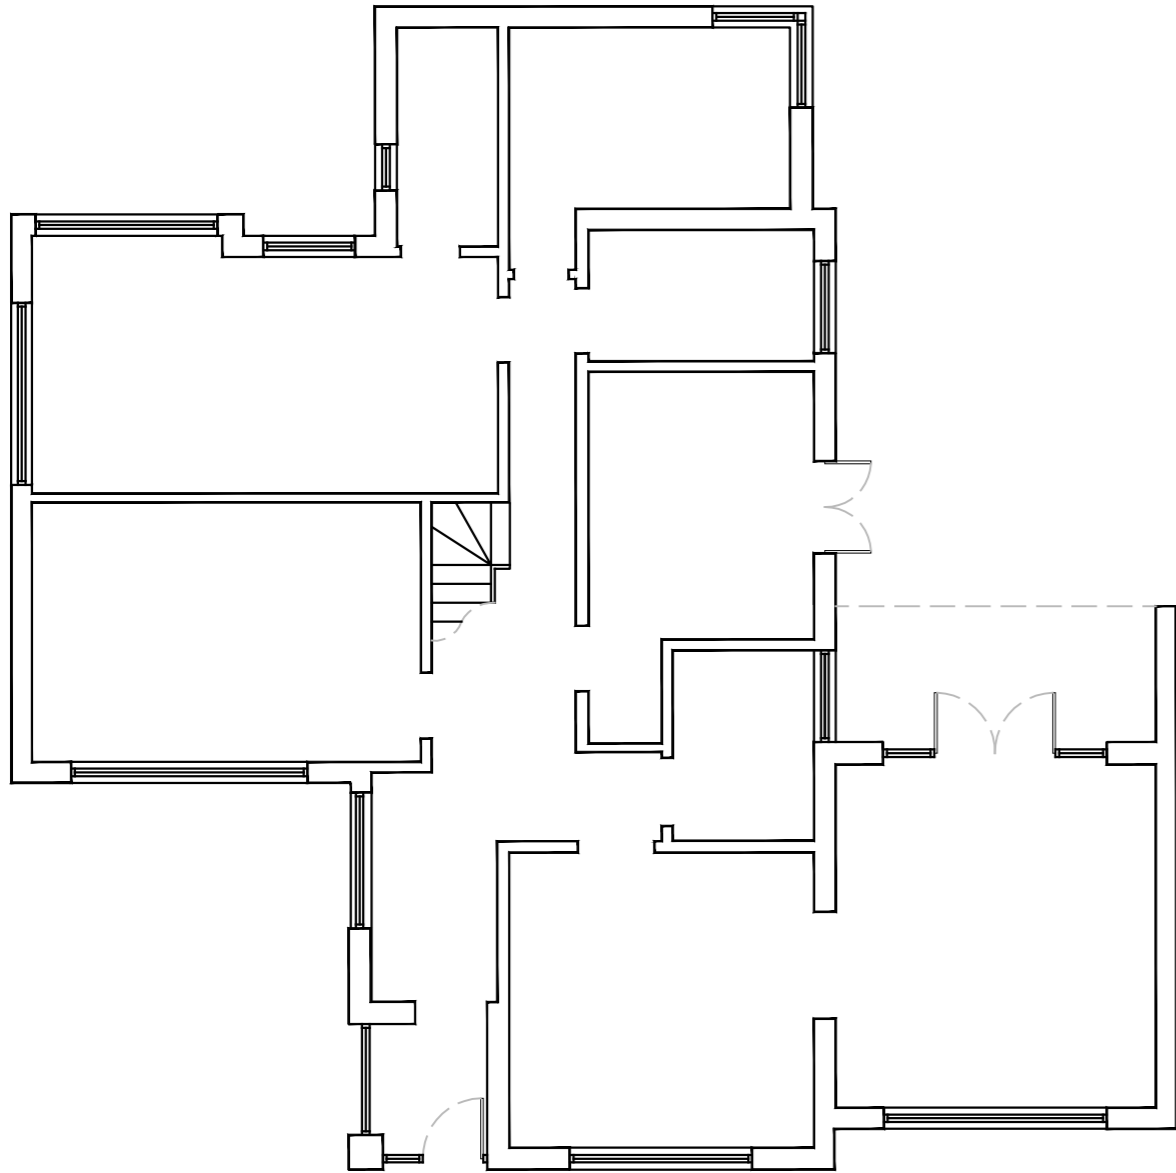

**FP2** GROUND FLOOR PLAN  
SCALE: 1:100 @ A3  
**PROPOSED**

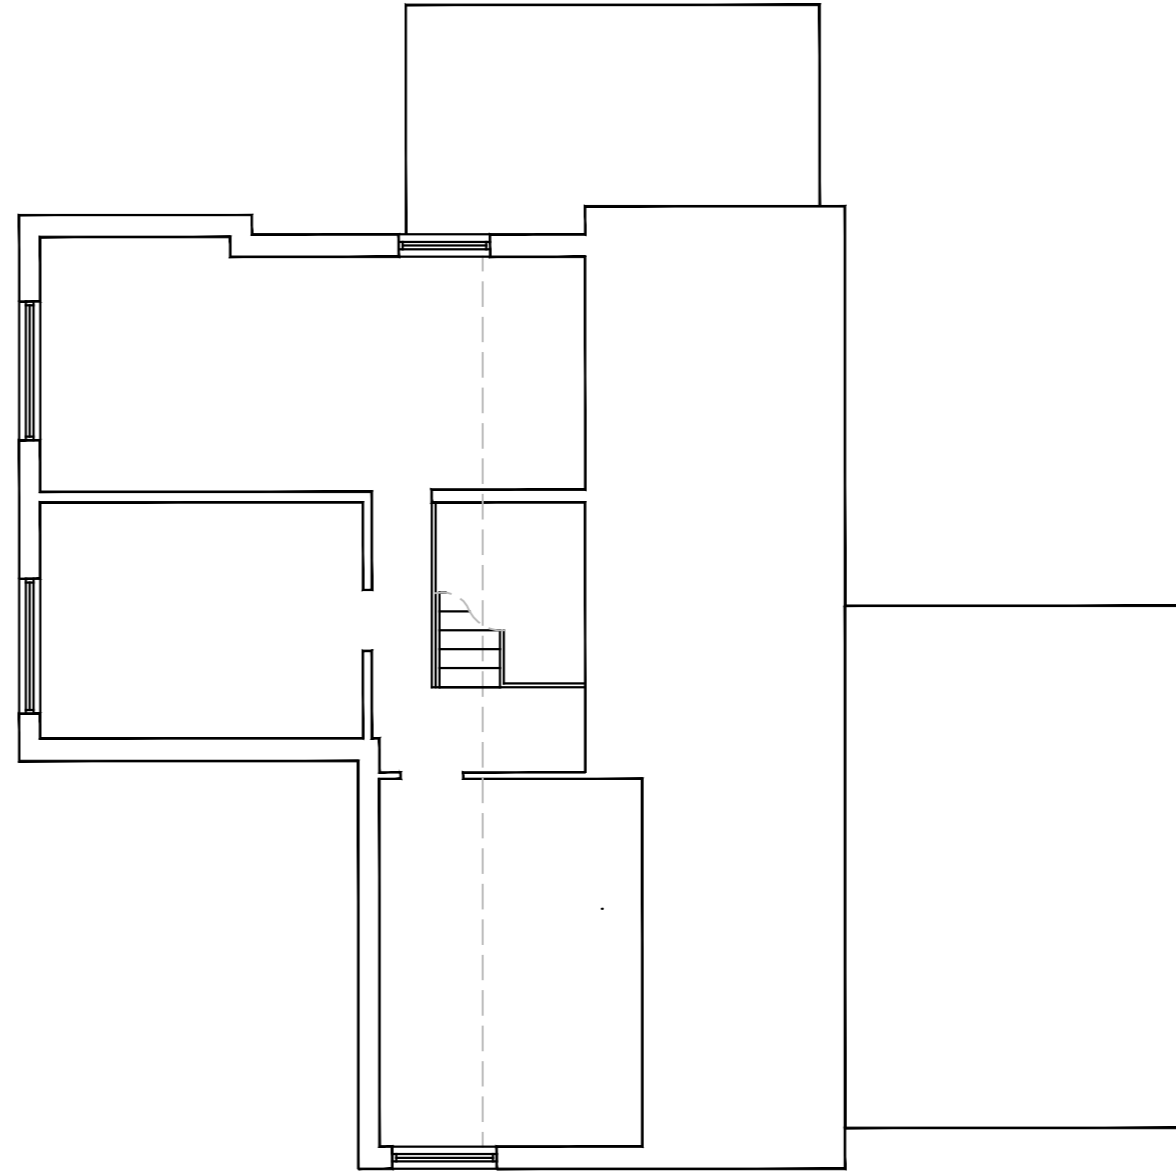

**FP3** FIRST FLOOR PLAN  
SCALE: 1:100 @ A3  
**PROPOSED**



**place for humans**


**3 WOBURN RISE,  
NG5 4PS.**

**PROPOSED  
FLOOR PLANS**


SCALE: 1:100 @ A3

**A3.3**


DRAWN BY: **Joe Robertshaw**

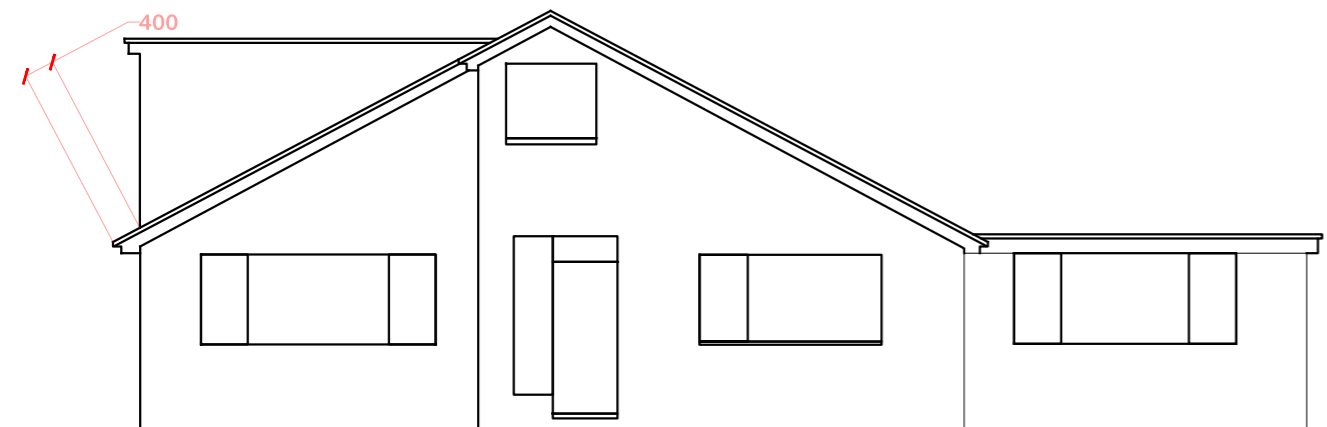

**E5 FRONT ELEVATION**  
SCALE: 1:100 @ A3  
**PROPOSED**

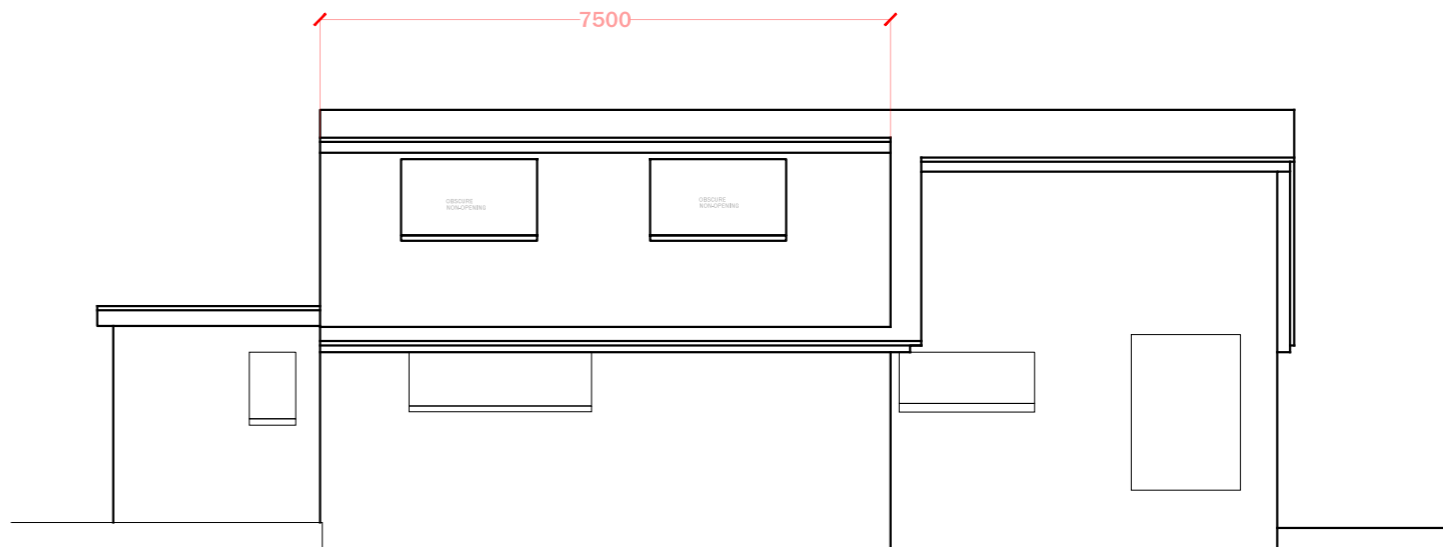


**E6 SIDE ELEVATION**  
SCALE: 1:100 @ A3  
**PROPOSED**

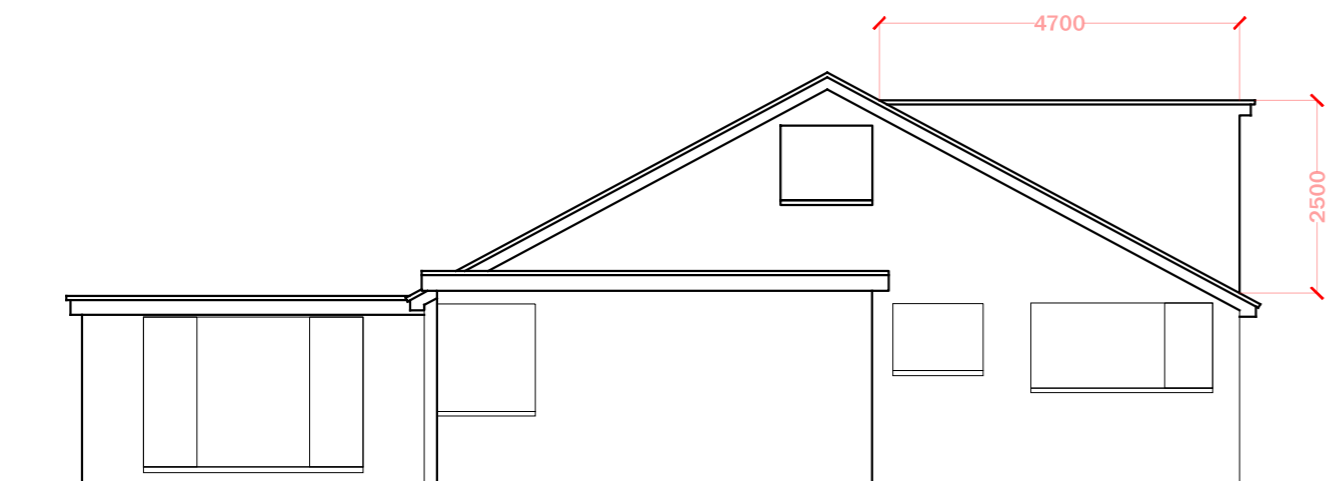

**E7 REAR ELEVATION**  
SCALE: 1:100 @ A3  
**PROPOSED**

**VOLUME CALS:**

**Dormer window – flat roof**

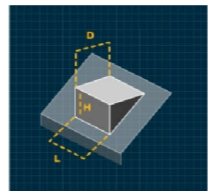

Height (metres)


Depth (metres)

Length (metres)

**Total Volume:**  
**44.06**

[Calculate Volume](#)

[Reset](#)

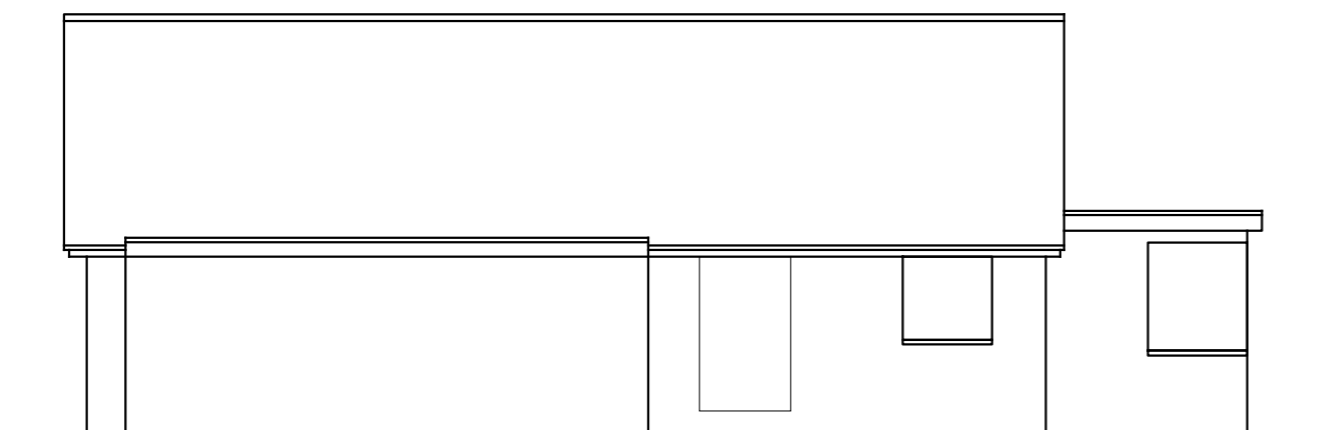

**E8 SIDE ELEVATION**  
SCALE: 1:100 @ A3  
**PROPOSED**



**place for humans**

**3 WOBURN RISE,  
 NG5 4PS.**

**PROPOSED  
 ELEVATIONS**

SCALE: 1:100 @ A3

**A3.4**

DRAWN BY: Joe Robertshaw