



PROPOSED SITE ELEVATION-A

SCALE: 1:100

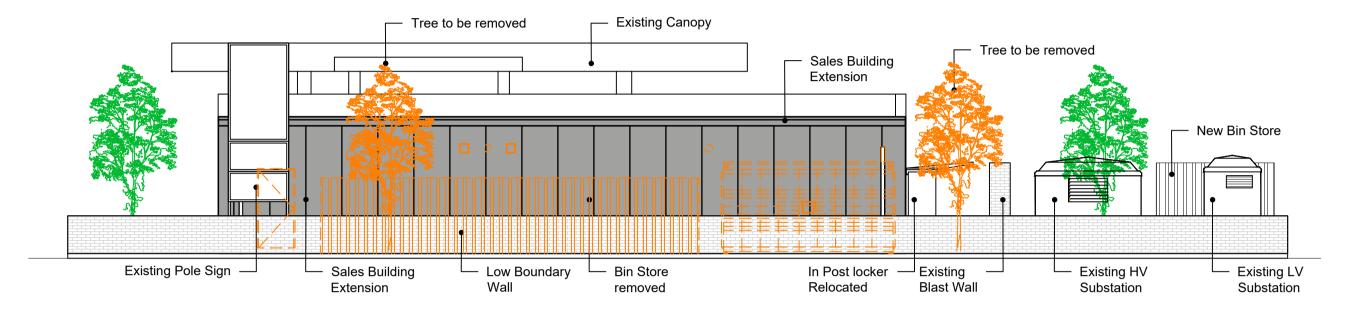


PROPOSED SITE ELEVATION-B

SCALE: 1:100

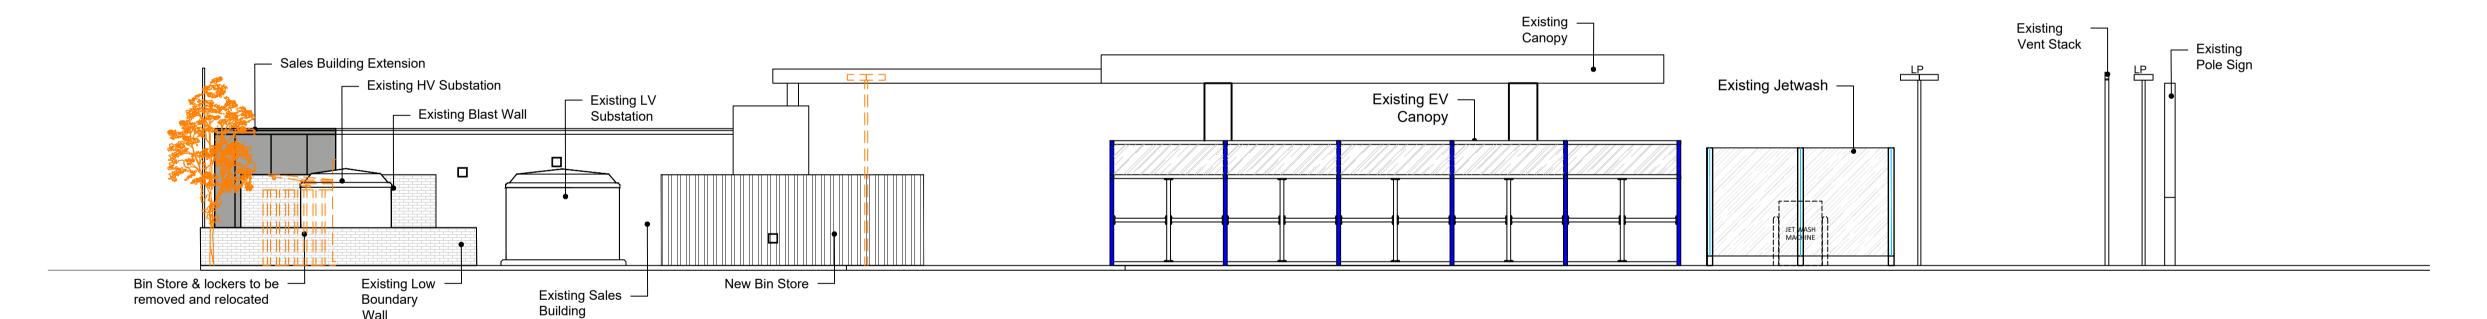

PROPOSED SITE ELEVATION-C

SCALE: 1:100

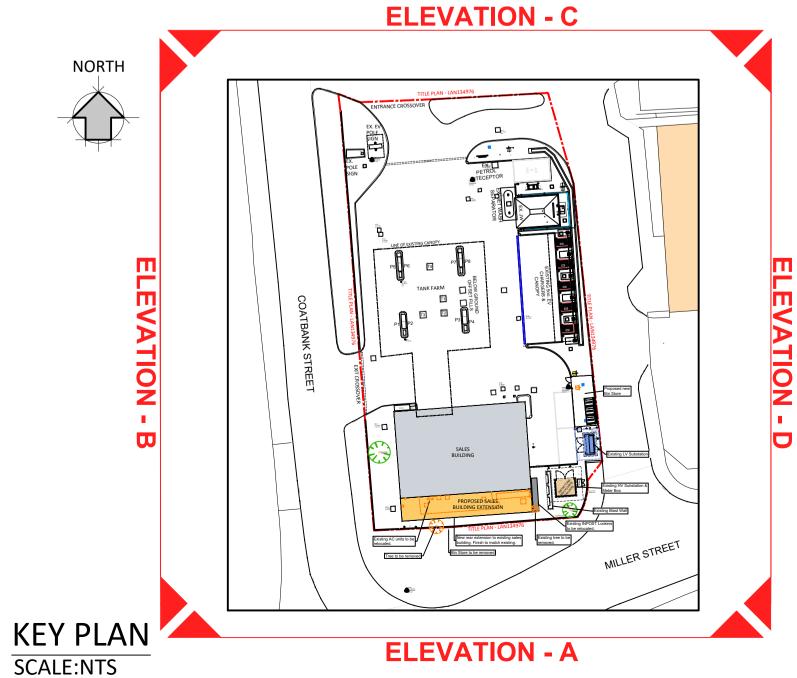

DRAWING NOTES

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This drawing has been produced for the project listed below, is submitted in support of this application application to the Local Planning Authority and is not intended for use by any other person or for any other purpose.

Every effort has been made to ensure the accuracy of these drawings, however MBH Design Studio Ltd. accept no responsibility for any discrepancies arising from the reuse of survey information and preliminary drawings commissioned by the Applicant from others.

GENERAL NOTES

- 1. This drawing has been prepared for the sole purpose of obtaining planning permission.
- 2. This drawing is to be read in conjunction with drawings numbered:

14208-LP Location Plan 14208-BP Block Plan 14208-P01 Existing Site Plan

14208-P02 Existing Site Elevations 14208-P03 Proposed Site Plan

14208-P04 Proposed Site Elevations 14208-P05 Existing Sales Building Plan

14208-P06 Existing Sales Building Elevations 14208-P07 Proposed Sales Building Plan 14208-P08 Proposed Sales Building Elevations

- 3. Any advertisements are indicative and are subject to a separate advertisement application
- 4. Any neighboring buildings shown on the elevations are diagrammatic and have been extrapolated from site photographs. They have not been measured.

SCHEDULE OF PROPOSED FINISHES

ROOF CLADDING : The roof cladding is to be 115mm thick PIR Core Kingspan KS1000 RW profile composite panels (Target U-Value 0.18 W/m2K). Composite panels to laid with all necessary closure fillers and singly ply membrane flashings. The panels are to be fixed to the structure with self-drilling screws. The roof cladding is to be installed strictly in accordance with manufacturers standards details.

Steel framework with Kingspan Kliplock external cladding to all match existing. Composite panels to be RAL 7016 colour with the internal skin Polyster coated White and laid with all necessary trims, closure fillers and matching color coated flashings. The panels are to be fixed to the structure with hidden self drilling screws. The wall cladding is to be installed strictly in accordance with manufacturers standards details.


GLAZED SHOPFRONT:
The shopfront is to be Full Height Curtain walling with aluminium framed doors. All frames to be Powder coated RAL 7016 color. All as existing.

EXTERNAL WALL MOUNTED LED LIGHT:
ALWPLED Lynx LED Wallpack - 29 W Black Robust wall mounted luminaire for general accent illumination. Die-cast aluminium body with vandal resistant polycarbonate Fresnel lens diffuser by Ansell Lighting.

SURFACING
New Asphalt and concrete to be installed to new kerb areas. New Asphalt to rear parking area.

TIMBER

New close boarded timber bin store with 2m high double metal framed gates.

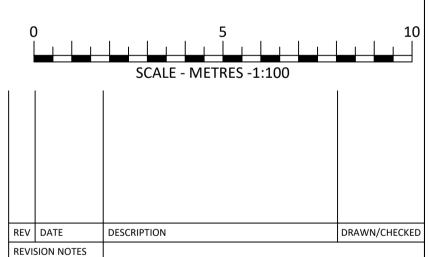

PLANNING



MBH Design Studio Ltd. Rosemount House, Rosemount Avenue, West Byfleet, Surrey, KT14 6LB www.mbhltd.com t: 01932 352 727 f: 01932 351 545



FS823 COATBRIDGE SERVICE STATION 33 COATBANK STREET, COATBRIDGE, LANARKSHIRE

ML5 3SP

PROPOSED SITE ELEVATIONS

DRAWN BY 22.12.2023 DT

DRAWING NUMBER CHECKED BY

14208-P04

1:100