


NRP SOUTH, MULTI-STOREY CAR PARK EXTENSION

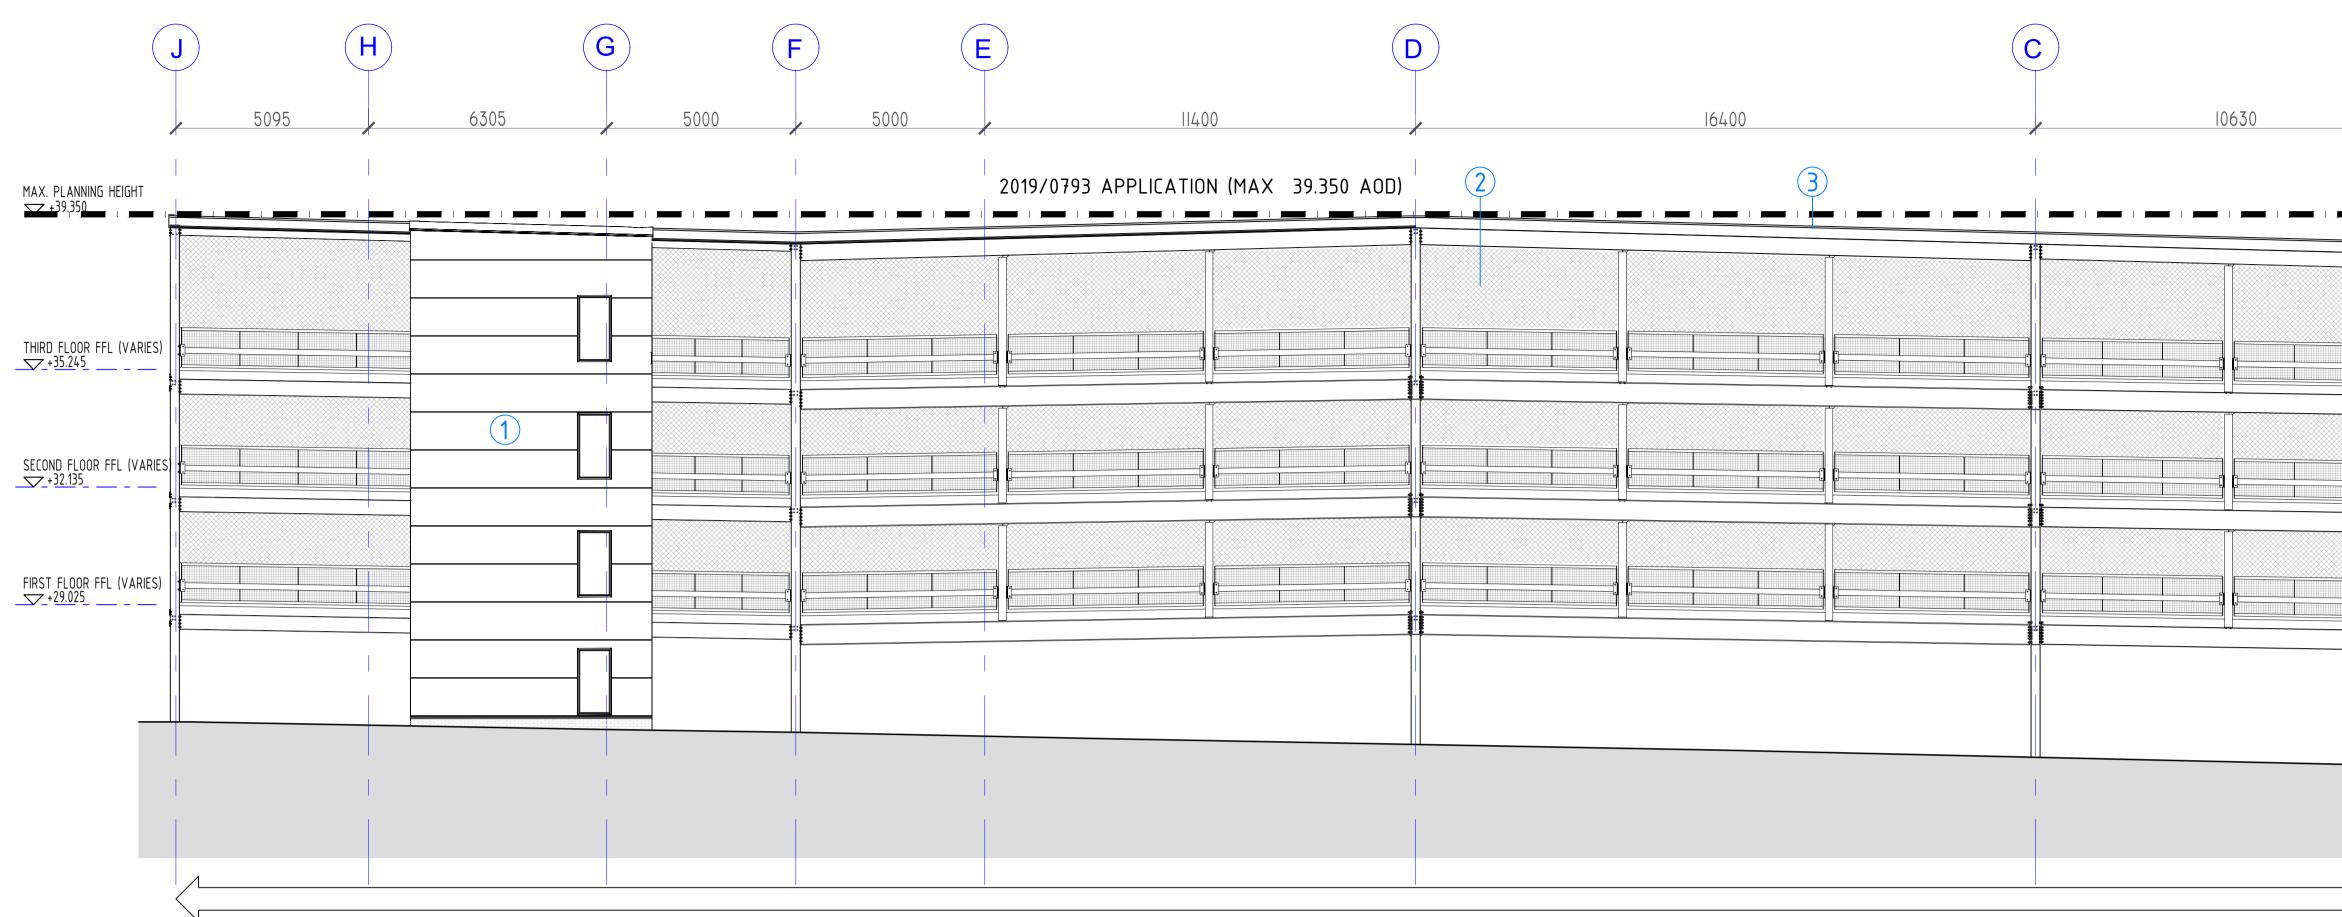

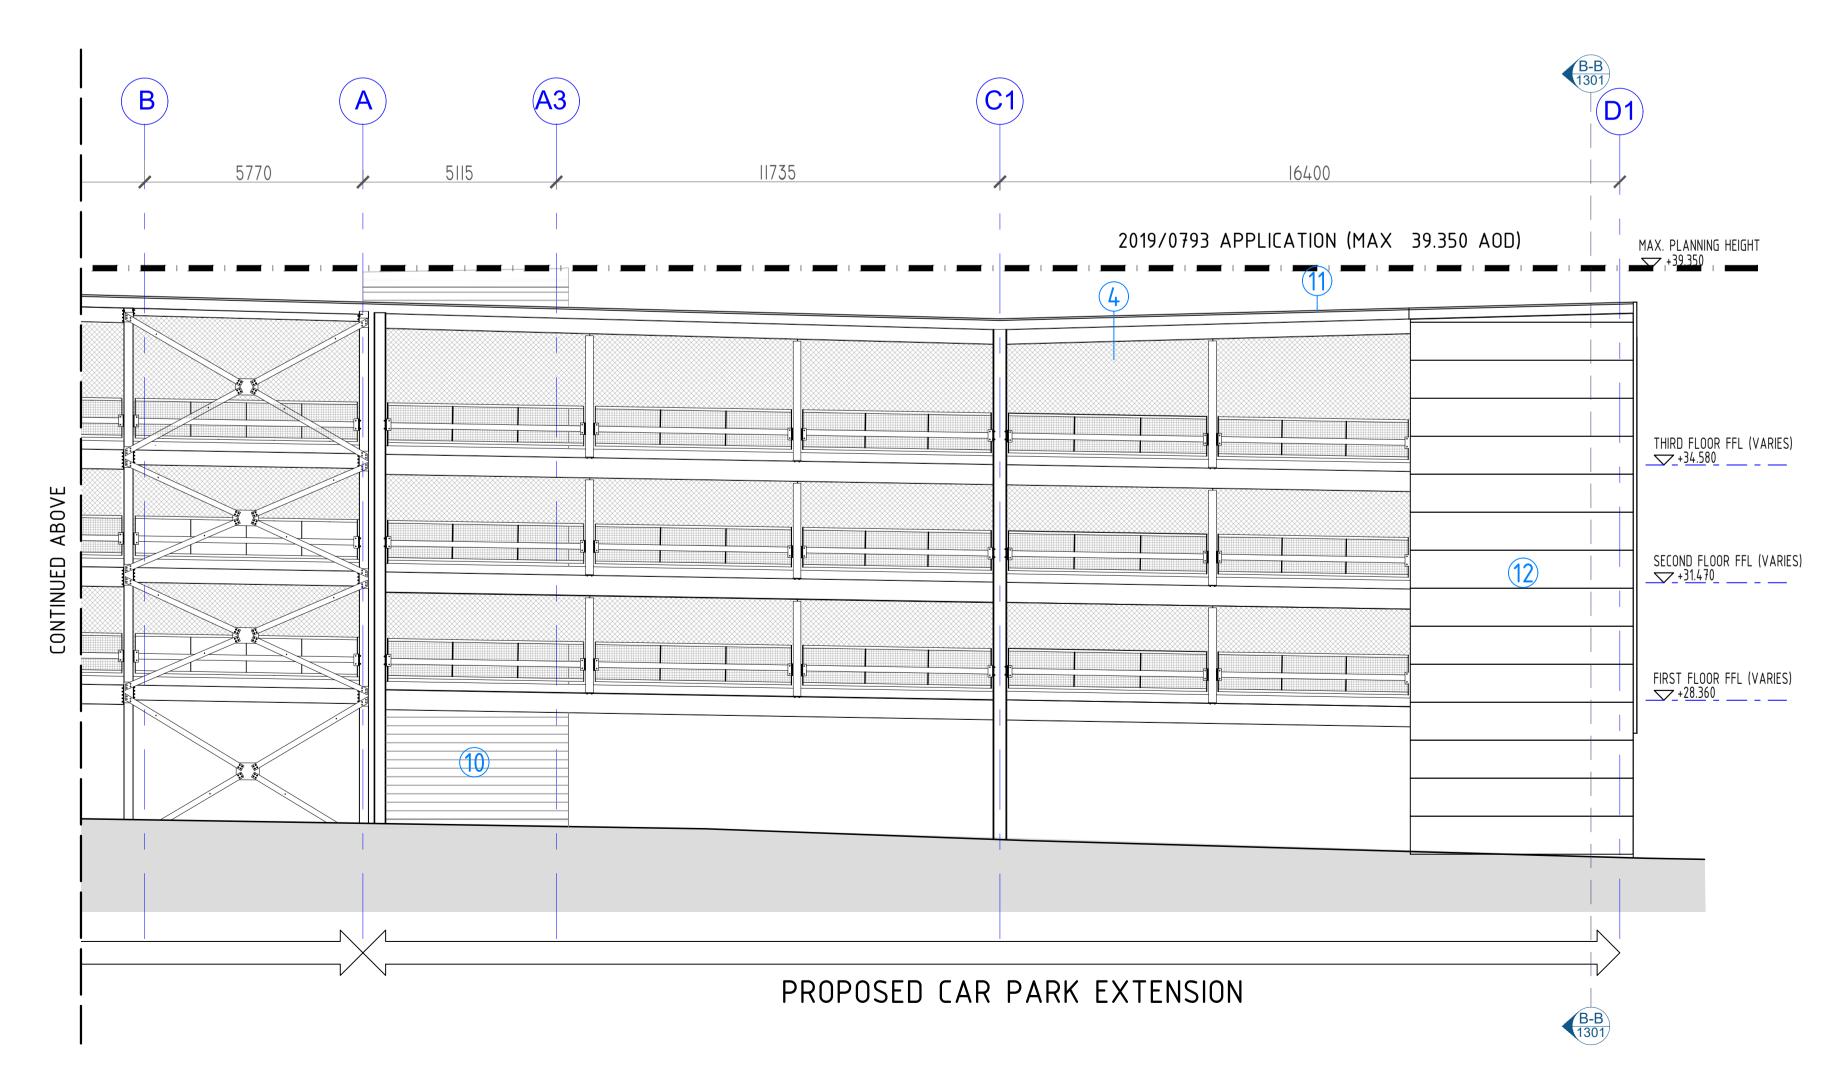

PROPOSED SOUTH-EAST ELEVATION SCALE: 1:100 @ A1

EXISTING CAR PARK

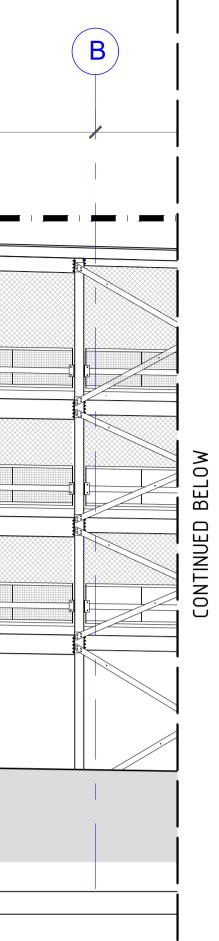

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DO NOT SCALE FROM THIS DRAWING. USE ONLY FIGURED OR GRID DIMENSIONS

NOTES:

All workmanship is to be in accordance with the latest amendment of the relevant section of BS 8000, to the extent that recommendations define quality of finished work. All materials, products and systems are to be installed and fixed in strict accordance with the latest manufacturers written instructions, in line with the requirements of any relevant British Board of Agrément Certificates, British or European Standards and the section of BS 8000 applicable to that trade.

All dimensions must be checked on site prior to commencement of related works.

Any discrepancies should be notified to the design office immediately.

Design, Construction or Residual Risks beyond the expected knowledge of a competent Contractor, End-User/Operator, and/or residual risks that cannot be entirely mitigated through design are identified on this drawing. This drawing should be read alongside any project specific Design Risk Assessments prepared by CDG and/or other designers (including subcontractor or specialist designers).

LEGEND

- 1 EXISTING STAIR CORE TO REMAIN UNCHANGED.
- 2 EXISTING MESH INFILL TO REMAIN UNCHANGED.
- 3 EXISTING STANDING SEAM ROOF PANEL WITH MILL FINISH TO REMAIN.
- 4 MESH INFILL PANELS ALONG ELEVATION ADJACENT TO TREE LINE TO MATCH EXISTING.
- 5 MAIN CAR PARK ENTRANCE TO REMAIN UNALTERED.
- 6 EXISTING FIN CLADDING WITH MESH BEHIND TO REMAIN.
- VERTICAL METAL FINS SIZED, SPACED AND SPLAYED TO MATCH EXISTING. FINS TO BE POLYESTER POWDER COATED RAL 6005 MOSS GREEN.
- 8 PROPOSED STAIR CORE CONSTRUCTED USING FLAT WALL PANELS, COLOUR HOLY BUSH TO MATCH EXISTING. BLUE ENGINEERING BRICK PLINTH TO BE CONSTRUCTED TO DPC LEVEL.
- 9 VERTICAL TIMBER FINS BETWEEN GRIDLINES 8–11. COLOUR: TBC. EXACT SPECIFICATION AND SIZING TBC.
- EXISTING STAIR CORE BEYOND. CURTAIN WALLING IS TO BE REMOVED AND BLOCKED UP. CLADDING TO BE REMOVED AND REPLACED WITH 100mm SOLID DENSE 7.3N/mm² BLOCKWORK.
 KALZIP STANDING SEAM ROOF SHEETS TO BE
- INSTALLED IN ACCORDANCE WITH MANUFACTURERS LATEST WRITTEN INFORMATION.
- (12) COMPOSITE CLADDING PANEL IN ELEVATION TO MATCH EXISTING STAIRCORE CLADDING FOR SPECIFICATION AND COLOUR.

S4.P01	Elevations updated to suit client comments	023		
		29.04.2023	Client	AG
ou	revisions	date	source	drawn
PLANNING				
Project NRP SOUTH, MULTI-STOREY CAR PARK EXTENSION drawing title PROPOSED SOUTH-EAST ELEVATION				
date: 05.06.2023 date: 05.06.2023 scale: 1:100 @ A1				
project originator volume level type role number status revision 8657.CDG.XX.XX.DR.A.1211 S4.P02 VICTORY PARK, LONDON ROAD, ATTLEBOROUGH, NORFOLK, NR17 1ZA. TEL: 01553 767788 E-MAIL: design@rgcarter.co.uk				
drawr date: pro	LP checked: AG corter 05.06.2023 date: 05.06.2023 scale: 1:100 @ A1 corter ect . originator . volume . level . type . role . number stat	desiç tus . 1. F	gn re	evis 0