
Chimney place to be removed. Structural alterations are required to support the chimney place.

Structural supports are to be fire protected to a minimum  $_{\mbox{\scriptsize 1/2}}$  hour fire protection. Fire protection to

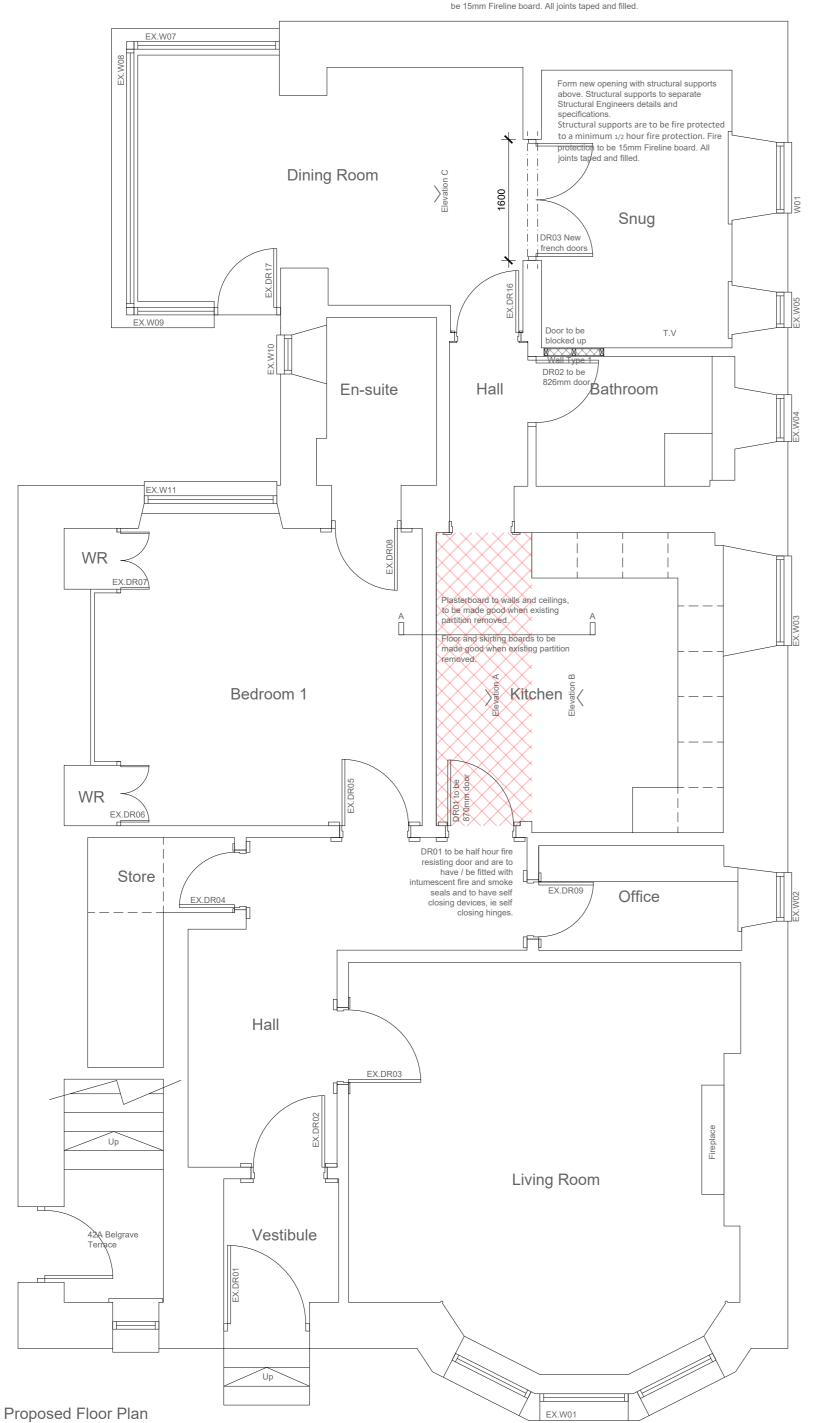

Window to be an escape window. Window to have a U value of 1.4 w/m<sup>2</sup>k. Trickle ventilation 12,000 mm<sup>2</sup> Windows to fully comply with part 2.9.4 of the current Technical Standards.

Escape windows are to have an openable area of at 0.33m<sup>2</sup> and at least be 450mm high and 450mm wide (the route through the window may be at an angle rather than straight through). The bottom of the openable area should not be more than 1.1m above the floor.


All glazing in vulnerable locations is to be laminated.

Glazing should be designed to resist human impact as set out in BS 6262:Part 4: 2005, where all, or part, of a pane is: \* within 800mm of floor level; or \*part of a door leaf; or


\*within 300mm of a door and within 1.5m of floor level. All to comply with part 4.8.2 of the current Technical

Standards




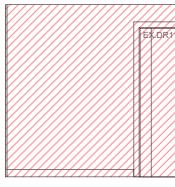

Scale 1:50

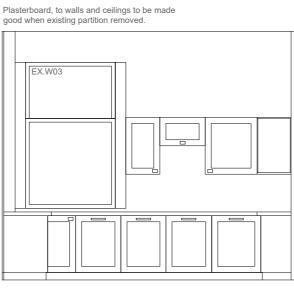

Proposed Elevation A Scale 1:50

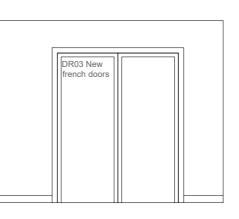

Existing Elevation C Scale 1:50


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Figured dimensions take preferrence. Do not scale from this drawing. All dimensions to be checked on site by Main Contractor before commencement of any work, shop drawings or manufacture of components. Dimensions are in millimetres unless otherwise specified. Any discrepancies to be referred to this office for decision. This drawing is to be read in conjunction with the specification (when applicable). All drainage lines are assumed until verified on site by Main Contractor.

For kitchen and utility units, all dimensions (plan and vertical) must be taken on site prior to manufacture by kitchen and utility unit manufacturer.

AD 1713 / 01, 02, and 04

These drawings are to be read in conjunction with:

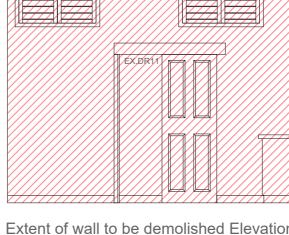

WALL CONSTRUCTION

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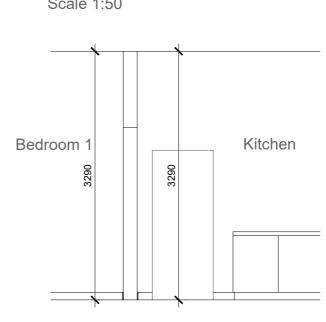
10ka/m<sup>3</sup>.

WALL TYPE 1 - Infill Partition

87mm x 47mm s/w framing, with 12.5mm plasterboard each side. Plasterboard to have a mass of 10kg/m<sup>3</sup>. 75mm Rockwool insulation to be laid between the studs with a minimum density of


Extent of wall to be demolished Elevation A





Proposed Section A-A Scale 1:50

Extent of wall to	be demolished	Elevation	B
Scale 1:50		Liovatori	

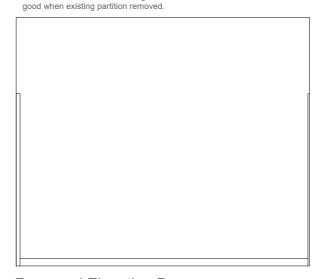

Plasterboard, to walls and ceilings to be made

Proposed Elevation B Scale 1:50

All Design architectural services				
	Aberdeen Innovation Park, Campus 2, James Gregory Centre Bridge of Don, Aberdeen, AB22 8GU Telephone Number - 01224 701576 Website : www.all-design.co.uk			
	Project	Development at 42 Belgrave Terrace, Aberdeen, AB25 2NS		
	Drawing Title	Proposed Floor Plan, Proposed		

10.01.24 AB

03.01.24 AB

21.12.23 AB

Date By

4m

C Issued to Planning

Rev Comments

0m

B Issued to Planning & Building Control

3m

2m

A Issued to Client for Comments

1m

Drawing Title	Proposed Floor Plan, Proposed Elevations and Section A - A	
Drawing Num	ber	AD 1713 / 03 Rev C
Scale 1:50 @ A2		Date : 21st December 2023 Drawn : AB