



- LEGEND (PLAN):**
- HIGHWAY BOUNDARY LIMITS
 - MAJOR CONTOUR - 0.1m INTERVALS
 - MINOR CONTOUR - 0.025m INTERVALS
 - CURRENT PLANNING APPLICATION BOUNDARY
 - PLANNING PERMISSION BOUNDARY 20/2481/EIS 11 JUNE 2021
- LEGEND (PROFILE):**
- EXISTING GROUND LEVEL
 - PROPOSED GROUND LEVEL

- NOTES:**
- ALL DIMENSIONS ARE IN METERS UNLESS OTHERWISE STATED.
 - DO NOT SCALE FROM DRAWING, USE FIGURED DIMENSIONS ONLY.
 - VERTICAL PROFILE CURVES AND GRADIENTS ARE IN ACCORDANCE WITH THE COUNCIL DESIGN GUIDE AND SPECIFICATION.
 - REFER TO DRAWING NO: STO-ARC-XX-XX-DR-CE-5101 FOR GENERAL ARRANGEMENT DETAILS.
 - REFER TO DRAWING NO'S: STO-ARC-XX-XX-DR-CE-5106 TO 5113 FOR CROSS SECTIONS.
 - REFER TO DRAWING STO-ARC-XX-XX-DR-CE-5500 FOR HIGHWAY DRAINAGE LAYOUT. SPECIFICATION TO BE THE STOCKTON BOROUGH COUNCIL HIGHWAY DESIGN GUIDE. SPECIFIC ATTENTION IS DRAWN TO THE CONSTRUCTION (DESIGN AND MANAGEMENT) REGULATIONS 2007 DEFINED WITHIN THE STATUTORY REQUIREMENTS CHAPTER.

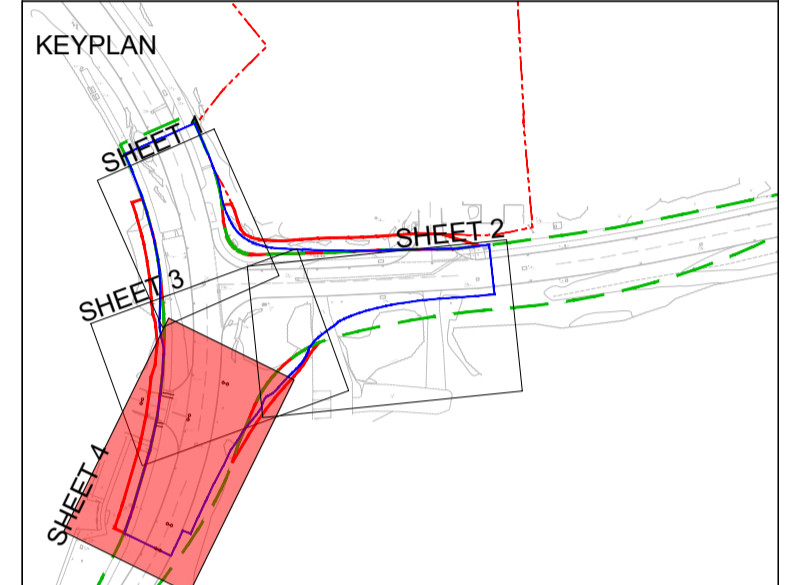

P04 11/12/23	BOUNDARIES & CLIENT UPDATED	DD	DO	MD
P03 26/07/22	NOTE ADDED	LR	DO	MD
P02 27/10/21	WEST SHARED-USE PATH ADDED	AW	DO	MD
P01 08/10/21	FIRST ISSUE	AW	DO	MD

PLAN - SCALE 1:200

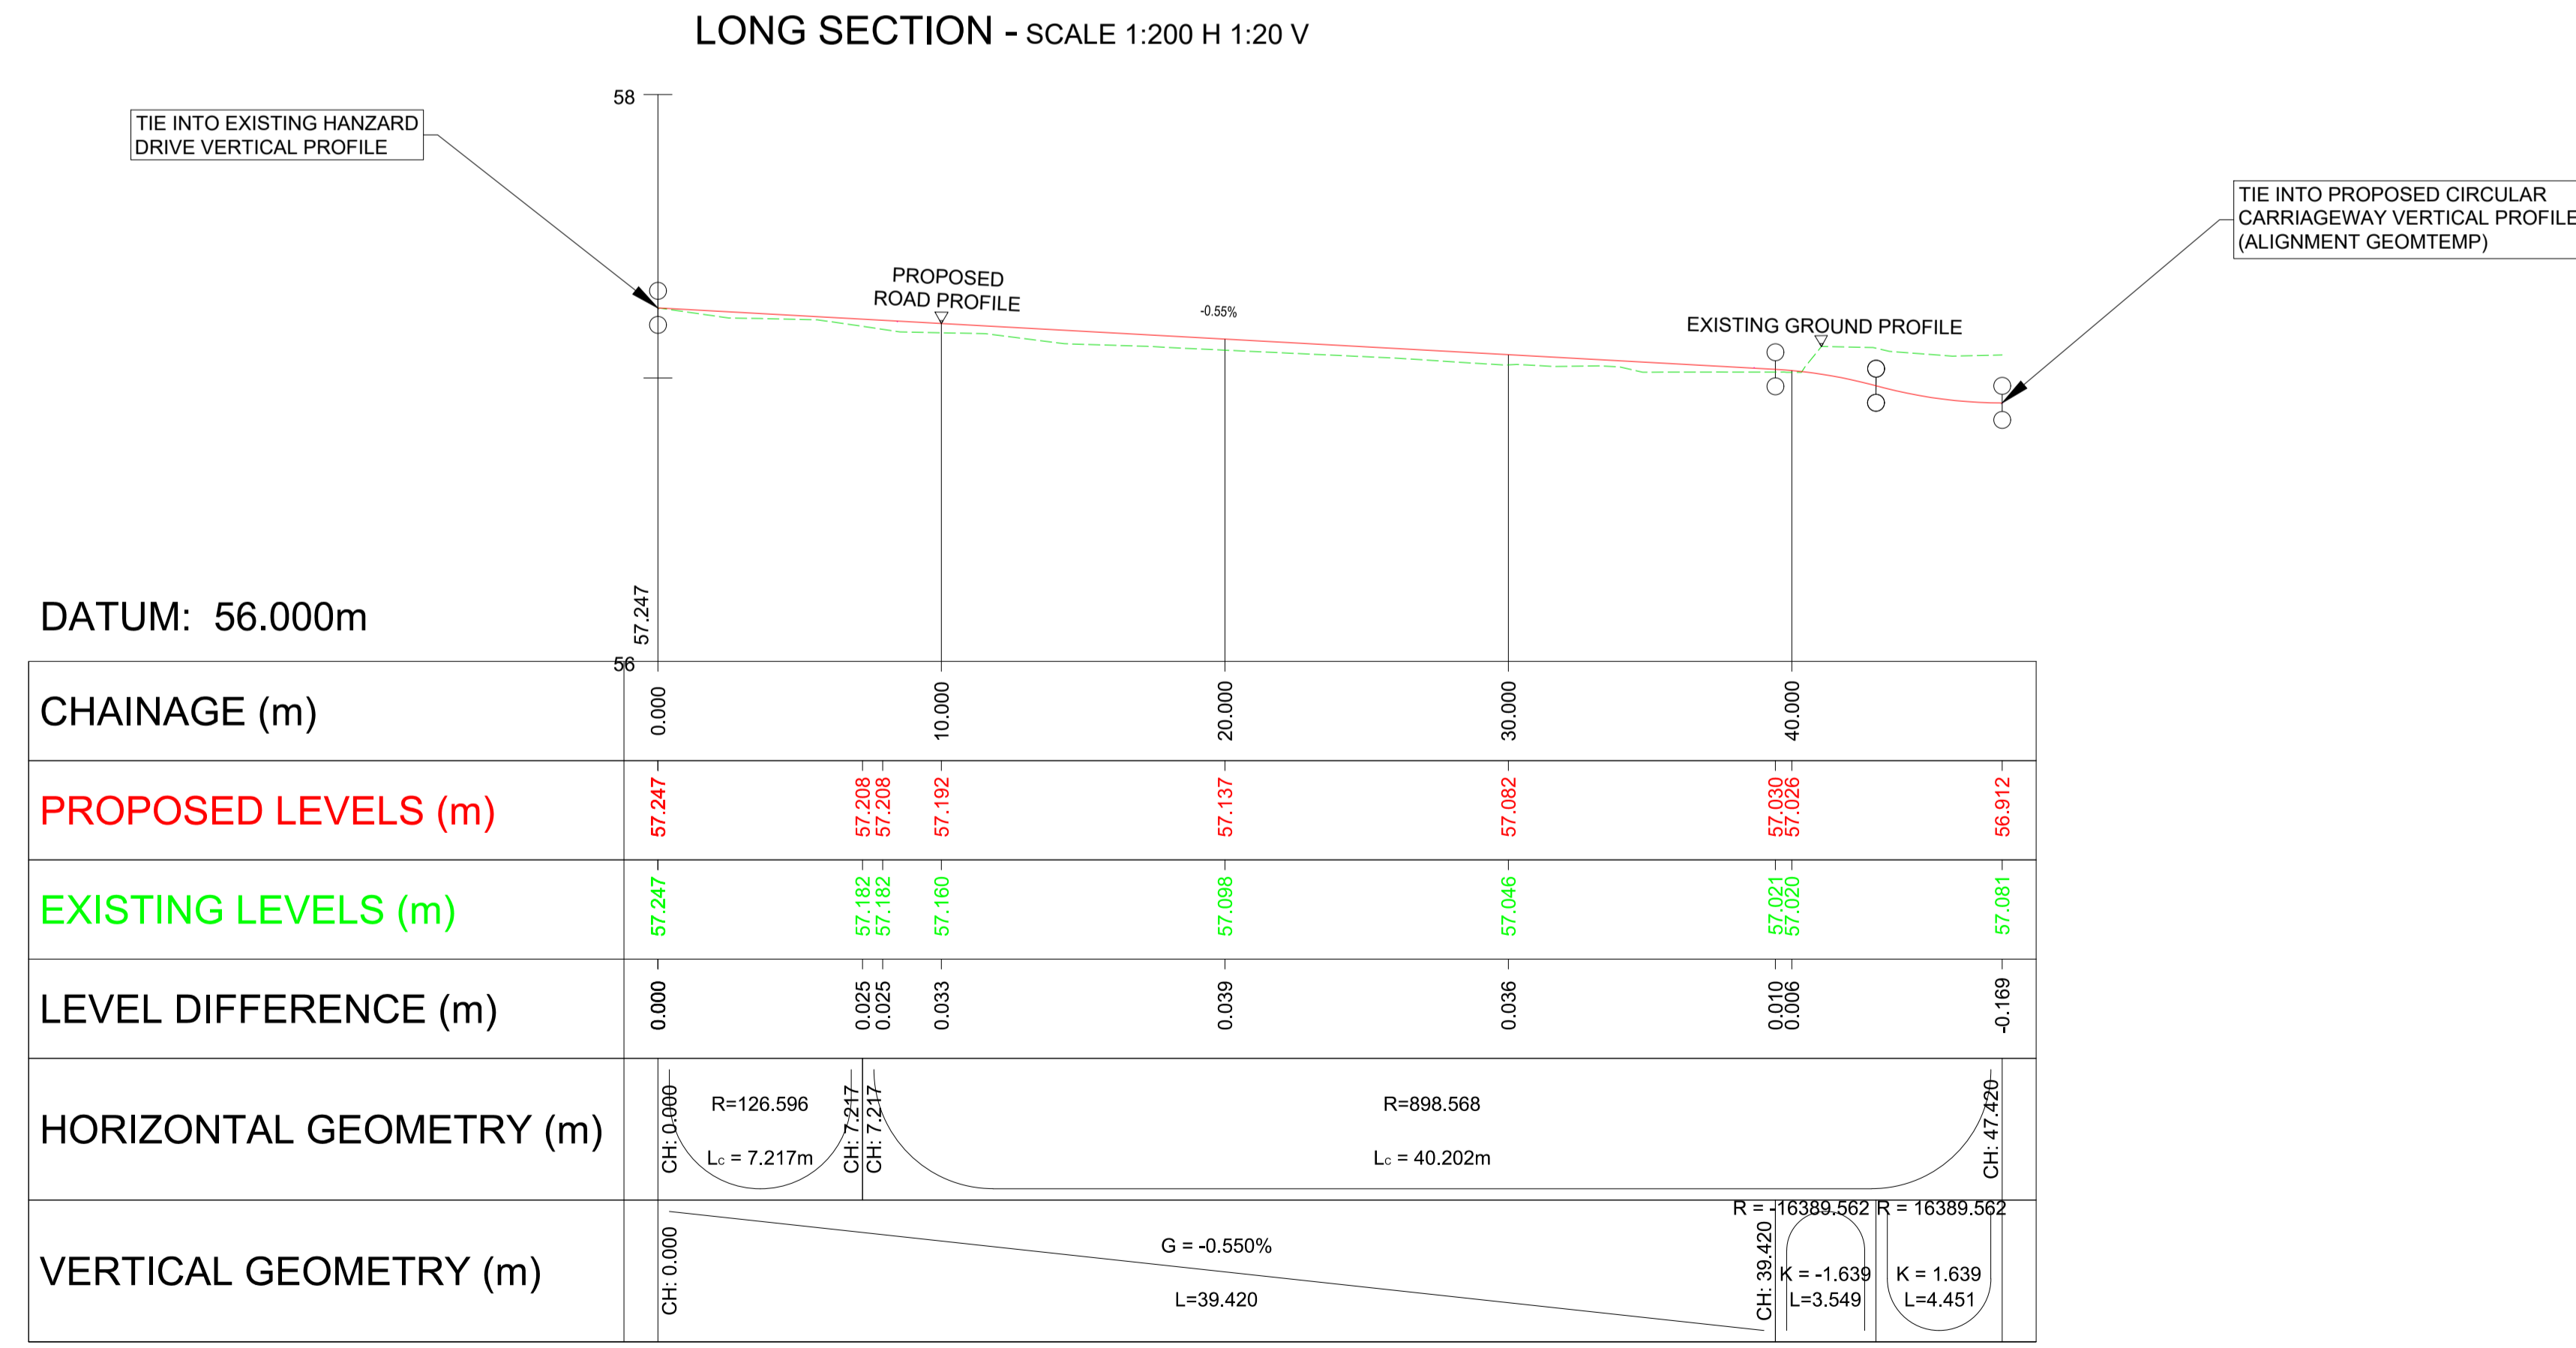

ALIG-GEOMBL_SOUTHARM
SCALE: H 1:200. V 1:20. DATUM: 56.000

Client
Amazon UK Services LTD

PROJECT:
STOCKTON

Site Chapel Lane North Stockton-on-Tees
Client Amazon UK Services Ltd

ARCADIS Design & Consultancy for technical and built assets

Registered office:
Arcadis House
34 York Way
London
N1 9AB

Coordinating office:
2 Glass Wharf
Temple Quay
Bristol BS2 0FR
Tel: +44 (0)11 7372 1200

www.arcadis.com

TITLE: STOCKTON HANZARD DRIVE / GLENARM ROAD ROUNDABOUT
PLAN AND PROFILE SHEET 4 OF 4

Designed	M.Collin	Signed		Date	27/10/2021
Drawn	A.Wilczynska	Signed		Date	27/10/2021
Checked	D.Ogden	Signed		Date	27/10/2021
Approved	M.Davies	Signed		Date	27/10/2021
Scale:	AS SHOWN	Datum:	OSGB 1936		
Original Size:	A1	Grid:	OSGB 1936		
Suitability Code:	S0	Project Number:	10042440		

Suitability Description:
PRELIMINARY NOT TO BE USED FOR CONSTRUCTION

Drawing Number:	STO-ARC-XX-XX-DR-CE-5105	Revision:	P04
-----------------	--------------------------	-----------	-----

