



NOTES

H3G & EE 1No. CVV65BSX-3x2 ANTENNA AT 15.8m MEAN HEIGHT, BEARING 300° E.T.N. ID No. EQU900190345 TO BE REMOVED

EE 1No. DUAL GSM FULL BAND 1800 MHA I.D. No. EQU900527961 TO BE REMOVED

H3G & EE 1No. METER CABINET

H3G & EE 6No. AVA5-50 & 6No. AVA6-50 FEEDERS TO BE REUSED (SUBJECT TO TESTING). EXISTING EE 6No. AVA6-50 FEEDER TO BE REMOVED. PROPOSED EE 3No. SINGLE MODE FIBRES & 3No. 8 CORE DC CABLES TO BE INSTALLED. EXISTING CABLE MANAGEMENT TO BE UTILIZED FOR PROPOSED UPGRADE

H3G & EE 1No. WREA CABINET INSTALLED ON STEEL GRILLAGE

H3G & EE 1No. FLEXI STACK INSTALLED ON STEEL GRILLAGE

H3G & EE 1No. LINK AC CABINET INSTALLED ON STEEL GRILLAGE

EE 1No. FURO CABINET TO BE REFRESHED FOR PROPOSED UPGRADE

PROPOSED EE 1No. RZVV-65B-R4-V4 ANTENNA AT 16.8m MEAN HEIGHT, BEARING 310° E.T.N. ID No. EQU900725150 TO BE INSTALLED ON PROPOSED STEEL WORK

PROPOSED EE 1No. 1800/2100 AHEGC RRU I.D. No. EQU900725153 TO BE INSTALLED ON PROPOSED STEELWORK

PROPOSED EE 1No. MK2 BOB's I.D. No. EQU900725162 TO BE INSTALLED ON PROPOSED STEEL WORK

H3G 1No. E15R02P11 800 MHA I.D. NO. EQU900521510 TO BE RELOCATED ON PROPOSED STEELWORK

H3G & EE 1No. TMA2053F01V2-1 1800/2100 MHA I.D. No. EQU900501822 TO BE RELOCATED ON PROPOSED STEELWORK

H3G & EE 1No. CVV65BSX-3x2 ANTENNA AT 15.8m MEAN HEIGHT, BEARING 190° E.T.N. ID No. EQU900190344 TO BE REMOVED

EE 1No. DUAL GSM FULL BAND 1800 MHA I.D. No. EQU900527960 TO BE REMOVED

PROPOSED EE 1No. RZVV-65B-R4-V4 ANTENNA AT 15.8m MEAN HEIGHT, BEARING 50° E.T.N. ID No. EQU900725148 TO BE INSTALLED ON PROPOSED STEEL WORK

PROPOSED EE 1No. 1800/2100 AHEGC RRU I.D. No. EQU900725151 TO BE INSTALLED ON PROPOSED STEELWORK

PROPOSED EE 1No. MK2 BOB's I.D. No. EQU900725160 TO BE INSTALLED ON PROPOSED STEEL WORK

H3G 1No. E15R02P11 800 MHA I.D. No. EQU900521508 TO BE RELOCATED ON PROPOSED STEELWORK

H3G & EE 1No. TMA2053F01V2-1 1800/2100 MHA I.D. No. EQU900501820 TO BE RELOCATED ON PROPOSED STEELWORK

H3G 1No. SAMO CABINET INSTALLED ON STEEL GRILLAGE

H3G & EE 1No. CVV65BSX-3x2 ANTENNA AT 15.8m MEAN HEIGHT, BEARING 50° E.T.N. ID No. EQU900190343 TO BE REMOVED

EE 1No. DUAL GSM FULL BAND 1800 MHA I.D. No. EQU900527959 TO BE REMOVED

PROPOSED EE 1No. GPS MODULE AT 16.4m I.D.No. EQU900725163 TO BE INSTALLED ON PROPOSED GANTRY POLE

PROPOSED EE 3No. MK2 BOB's I.D. No. EQU900725157, EQU900725158 & EQU900725159 TO BE INSTALLED ON PROPOSED GANTRY POLE


PROPOSED EE 1No. RZVV-65B-R4-V4 ANTENNA AT 16.0m MEAN HEIGHT, BEARING 180° E.T.N. ID No. EQU900725149 TO BE INSTALLED ON PROPOSED STEEL WORK

PROPOSED EE 1No. 1800/2100 AHEGC RRU I.D. No. EQU900725152 TO BE INSTALLED ON PROPOSED STEELWORK

PROPOSED EE 1No. MK2 BOB's I.D. No. EQU900725161 TO BE INSTALLED ON PROPOSED STEEL WORK

H3G 1No. E15R02P11 800 MHA I.D. No. EQU900521509 TO BE RELOCATED ON PROPOSED STEELWORK

H3G & EE 1No. TMA2053F01V2-1 1800/2100 MHA I.D. No. EQU900501821 TO BE RELOCATED ON PROPOSED STEELWORK

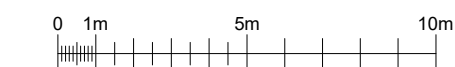

SITE PLAN
 SCALE 1:200

FEINT DETAILS INDICATE LOCATIONS RESERVED FOR OTHER PROPOSALS WHICH MAY BE THE SUBJECT OF SEPARATE APPLICATIONS

PROJECT No. COM-0024721

CELL No. 22712

BT SKYLINE No. GZ0036

ISS	REVISION	DATE	DRN	APP
14	0024721	25/10/23	HFC	HFC
13	233577	16/10/20	JBT	LGB
12	188912	03/05/19	KG	LGB
11	N/A	23/01/18	HF	KG
10	173706	12/01/17	HFC	PD



CELLNEX UK
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 Tel. 020 4526 8553

SITE No. 164906
 MILNGAVIE ATE
 ASHFIELD ROAD
 MILNGAVIE
 GLASGOW
 GLASGOW
 G62 6BT

NGR NS 55298 74280

OS GRID 255298 674280

TITLE
 SITE PLAN
 PROPOSED
 EE LTD

SCALE 1:200

DRAWN IM 31/05/11

APPROVED HFC 25/10/23

DRG No. Sheet 1 of 1 Rev

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H3G & EE 1No. METER CABINET

H3G & EE 1No. WREA CABINET
 INSTALLED ON STEEL GRILLAGE

H3G & EE 1No. FLEXI STACK
 INSTALLED ON STEEL GRILLAGE

H3G & EE 1No. LINK AC CABINET
 INSTALLED ON STEEL GRILLAGE

EE 1No. FURO CABINET TO BE REFRESHED
 FOR PROPOSED UPGRADE

E1

H3G 1No. SAMO CABINET
 INSTALLED ON STEEL GRILLAGE

PROPOSED EE 1No. GPS MODULE AT 16.4m I.D.No. EQU900725163
 TO BE INSTALLED ON PROPOSED GANTRY POLE

PROPOSED EE 3No. MK2 BOB's I.D. No. EQU900725157, EQU900725158 &
 EQU900725159 TO BE INSTALLED ON PROPOSED GANTRY POLE

NOTES

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TITLE
 EQUIPMENT PLAN
 PROPOSED
 EE LTD

SCALE 1:50

DRAWN IM 31/05/11

APPROVED HFC 25/10/23

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EQUIPMENT PLAN
 SCALE 1:50

FEINT DETAILS INDICATE LOCATIONS
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H3G 1No. SAMO CABINET INSTALLED ON STEEL GRILLAGE

H3G & EE 1No. LINK AC CABINET INSTALLED ON STEEL GRILLAGE

H3G & EE 1No. WREA CABINET INSTALLED ON STEEL GRILLAGE

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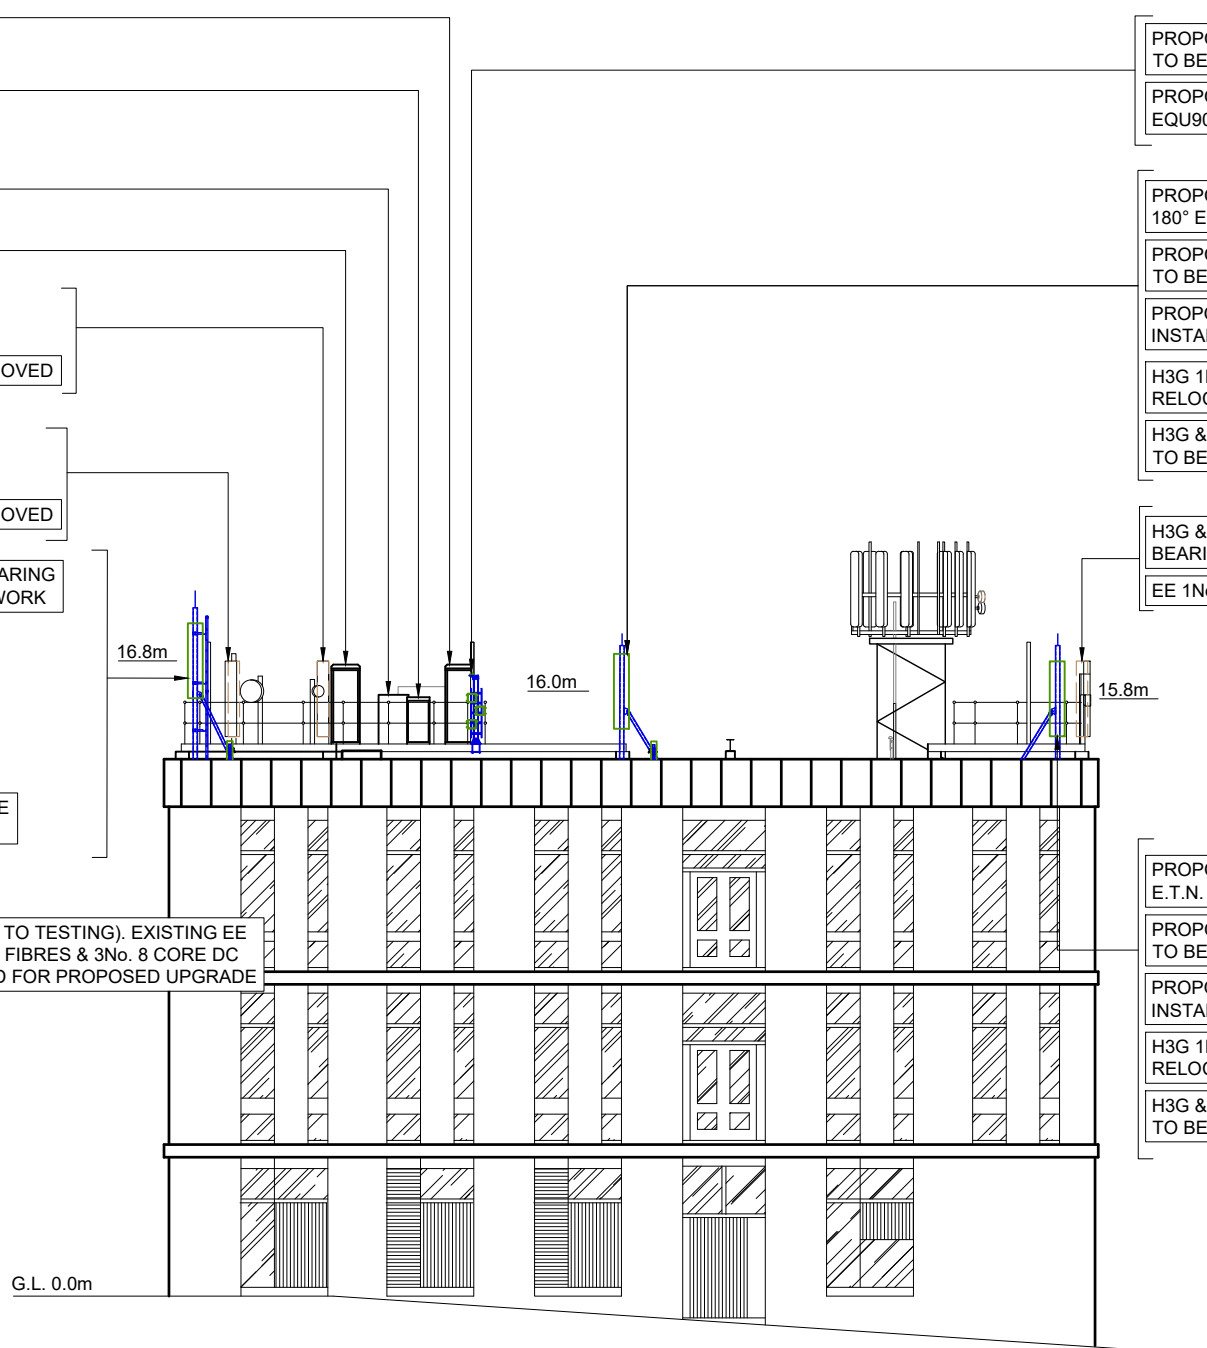
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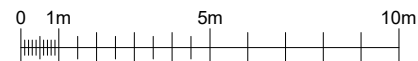
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EE 1No. DUAL GSM FULL BAND 1800 MHA I.D. No. EQU900527959 TO BE REMOVED



PARAPET LEVEL 14.2m
 ROOF LEVEL 13.3m

SOUTH ELEVATION
 SCALE 1:200



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 ELEVATION
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 EE LTD

SCALE 1:200

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