
Copyright 2022



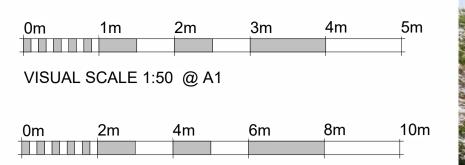


VISUAL SCALE 1:100 @ A1



TBR =	T	ha	ran		
IDK —	\mathbf{I}		160	lacea	



Room Schedule												
	Name		Department		Percentage of area	Finish						
Number		Level		Area		Wall Finish	Floor Finish	Ceiling Finish				
First Floor Pla	ın											
1	Bedroom	First Floor Plan		12.58 m²	29.51%							
2	Landing	First Floor Plan		7.04 m ²	16.50%							
3	Bedroom	First Floor Plan		13.81 m ²	32.40%							
4	Bathroom	First Floor Plan		9.20 m²	21.58%							
First Floor Pla	in: 4			42.63 m²	100.00%							
Ground Floo	r Plan											
5	Kitchen & Dining Room	Ground Floor Plan		22.39 m ²	41.44%							
6	WC	Ground Floor Plan		1.36 m ²	2.52%							
7	C/D	Ground Floor Plan		0.49 m ²	0.91%							
8	C/D	Ground Floor Plan		0.47 m ²	0.87%							
9	Living Room	Ground Floor Plan		10.59 m ²	19.61%							
10	Hallway	Ground Floor Plan		18.72 m ²	34.64%							
Ground Floo	,	Greena neer nam		54.02 m ²	100.00%							
Basement Flo	oor Plan											
11	Study	Basement Floor Plan		10.37 m ²	25.82%							
13	Bedroom/Living Room	Basement Floor Plan		Not Enclosed	0.00%							
14	С/В	Basement Floor Plan		0.41 m ²	1.02%							
15	C/B	Basement Floor Plan		0.47 m ²	1.16%							
16	С/В	Basement Floor Plan		1.20 m ²	3.00%							
17	С/В	Basement Floor Plan		2.08 m ²	5.18%							
18	Lower Hallway	Basement Floor Plan		12.03 m ²	29.96%							
19	Workshop	Basement Floor Plan		8.64 m ²	21.51%							
20	Bathroom	Basement Floor Plan		4.96 m²	12.35%							
Basement Flo				40.15 m ²	100.00%	1						
Total area: 1				136.81 m ²								

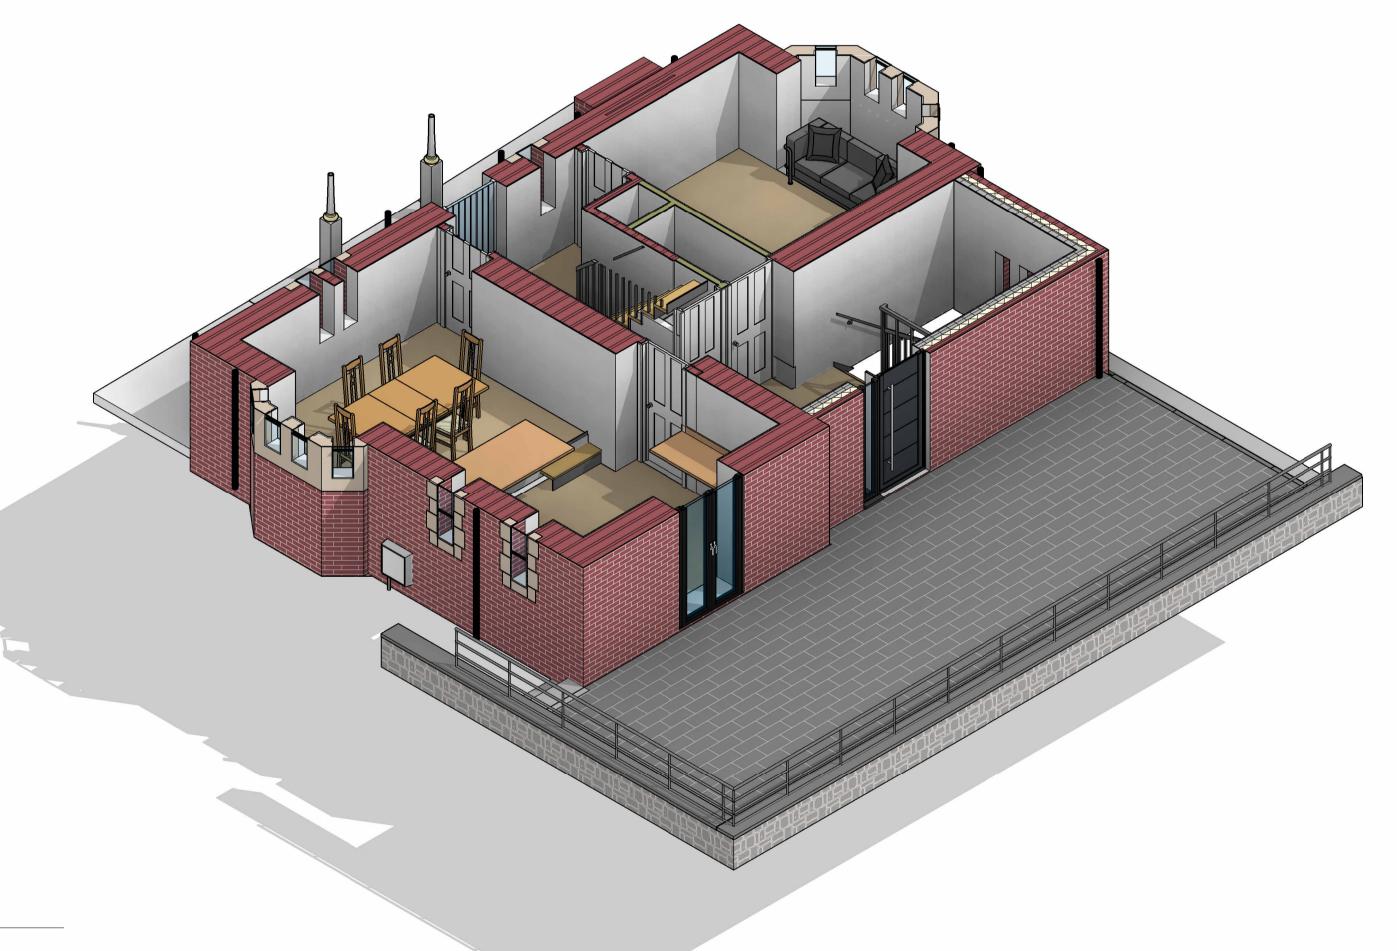

Wall Structure Key:

— Cavity Wall: Render — Cavity Wall: Face Brick — Block Work: 100mm Studwork Wall: 75mm Metal Frame: 70mm — Solid Brick Wall: 215mm — Solid Block Wall: 215mm ____ _ _ _ Structural Opening — Walls Removed

Passive Extract

Mechanical Extract

Heat Detector

Extract fan

Carbon Monoxide Detector

Underfloor heating control

All drawings are for the purposes of planning only unless marked for construction.

All builders to site measure to confirm measurements.

Report all discrepancies to the person named below, do not proceed without instruction.

BRO take no responsibility should any drawing/s unless specified are used for building purposes and measurements aren't checked on site.

All drawings remain the property of BRO Architecture

<u>Drainage Key</u>

Storm Drainage Manhole FD SVP Foul Drainage Soil Vent Pipe GP Gulley Pot Rainwater Pipe ACO Drain

Ducting Colour & Use

Electric cable Gas Pipe Water pipes Data/Comms Green

Grey

Security - Cameras

Garden Lighting non Security

DRAWING NUMBER

Ground Floor Plan

1:50



Mobile: 07508 856621 Website: www.broarchitecture.co.uk E-mail: info@broarchitecture.co.uk

CLIENT

SITE ADDRESS

Peter Helgosson

Burwalls Lodge BS8 3PT

PROJECT NAME

Proposed Windows and Front Door Replacement

DRAWING NAME

Proposed Ground Floor Plans

DATE 20th Dec 23

DRAWN BY

SCALE (@ A1) 1:50

CHECKED BY

PROJECT NUMBER SH/BRO/201223-PH