

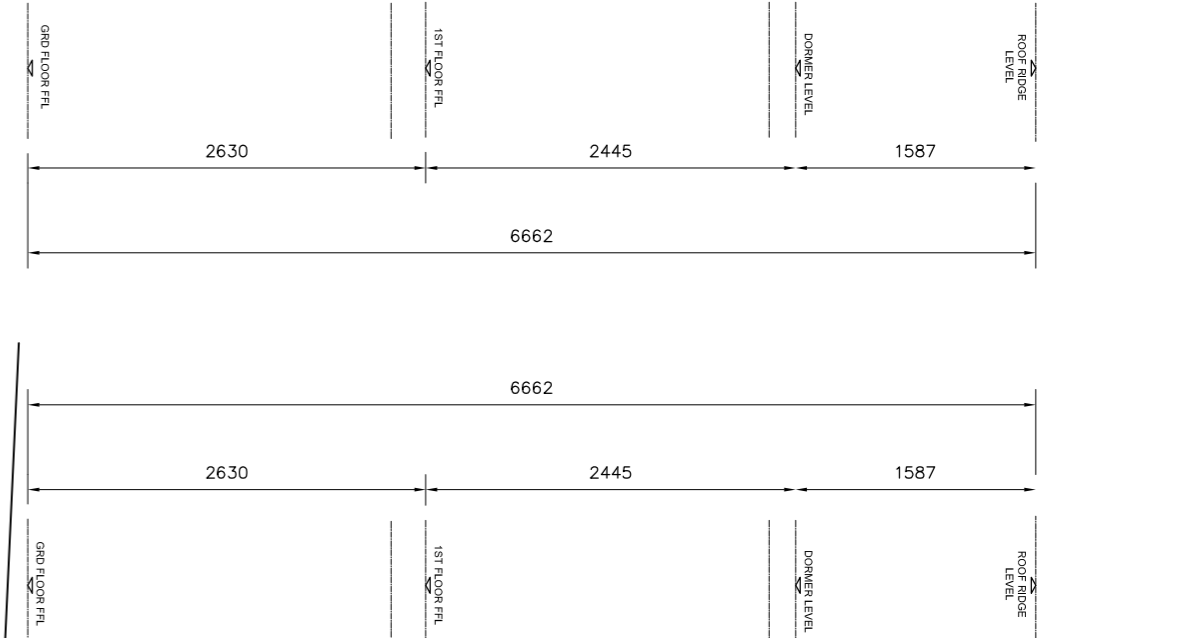



PROPOSED FRONT ELEVATION
SCALE 1:50

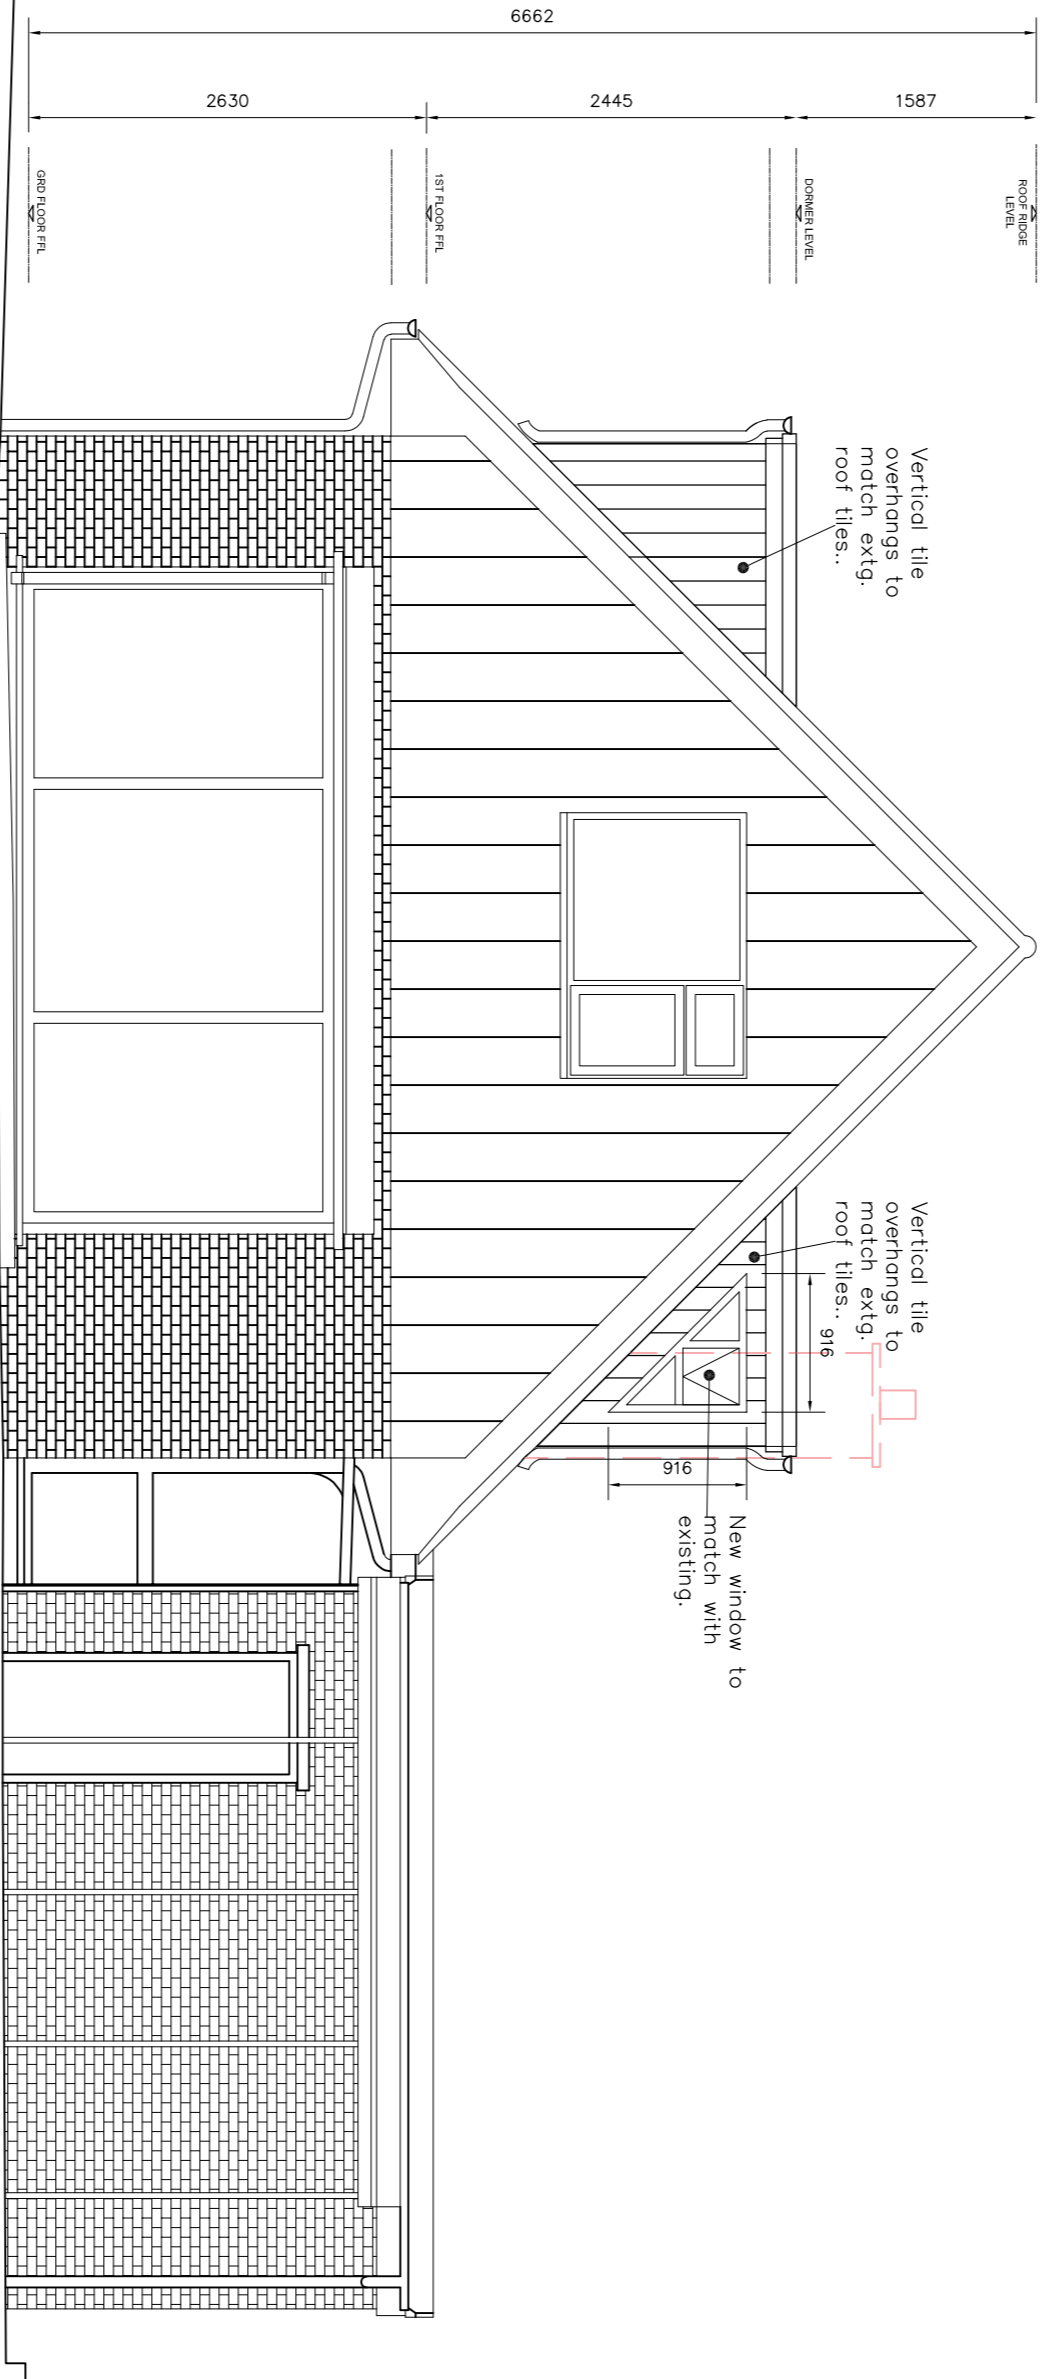


PROPOSED SIDE ELEVATION "A"
SCALE 1:50

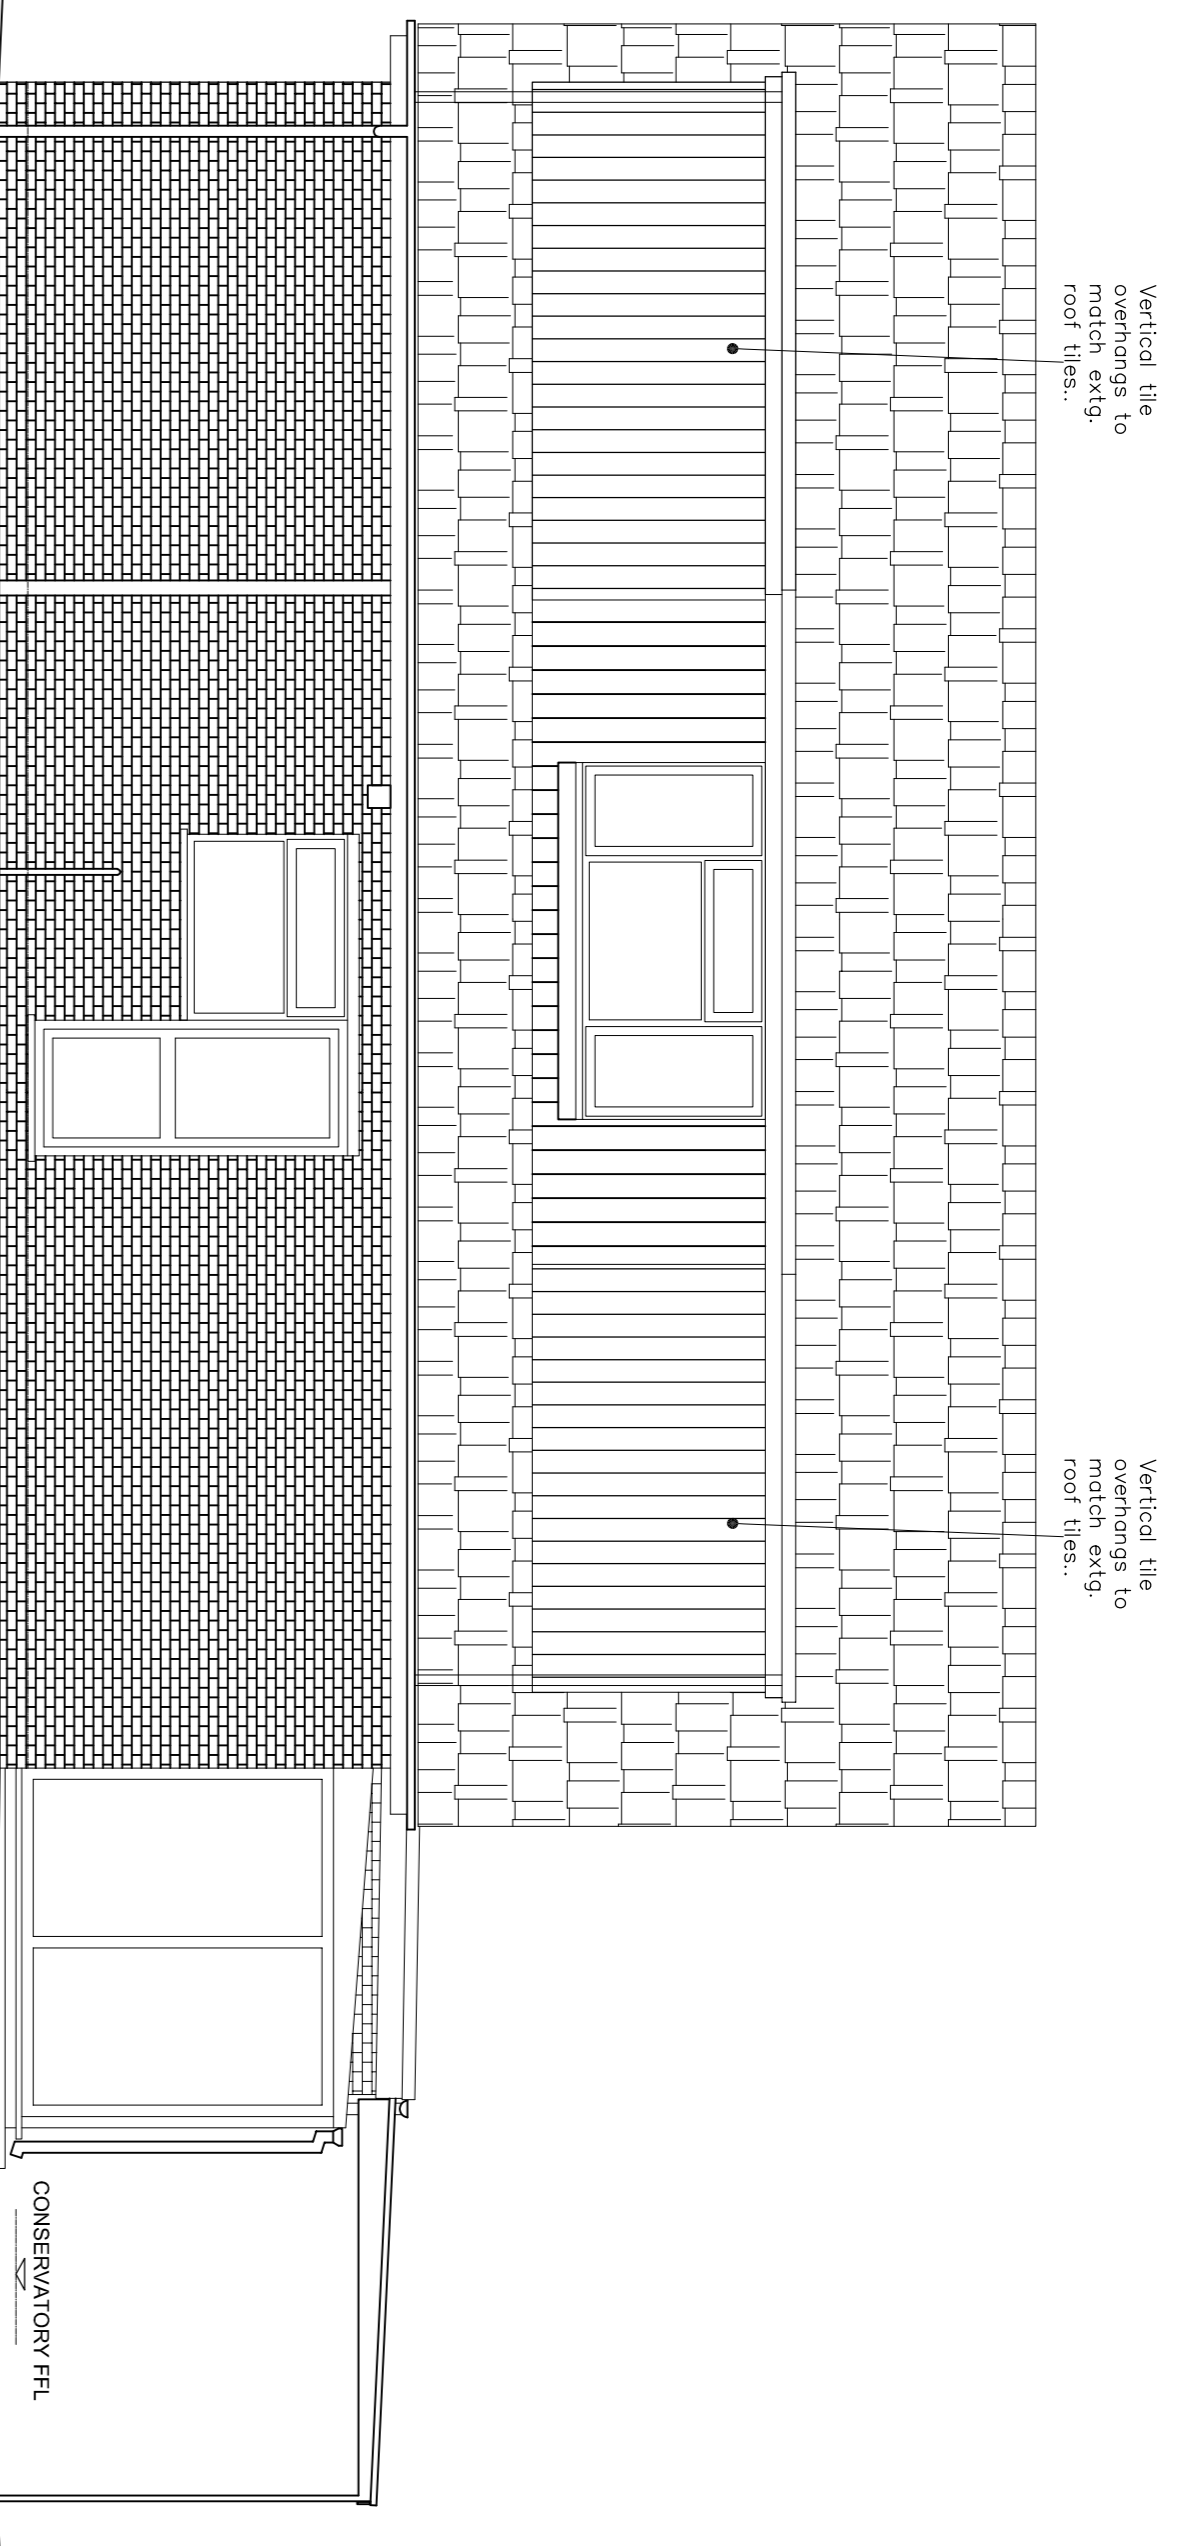

PROPOSED REAR ELEVATION
SCALE 1:50

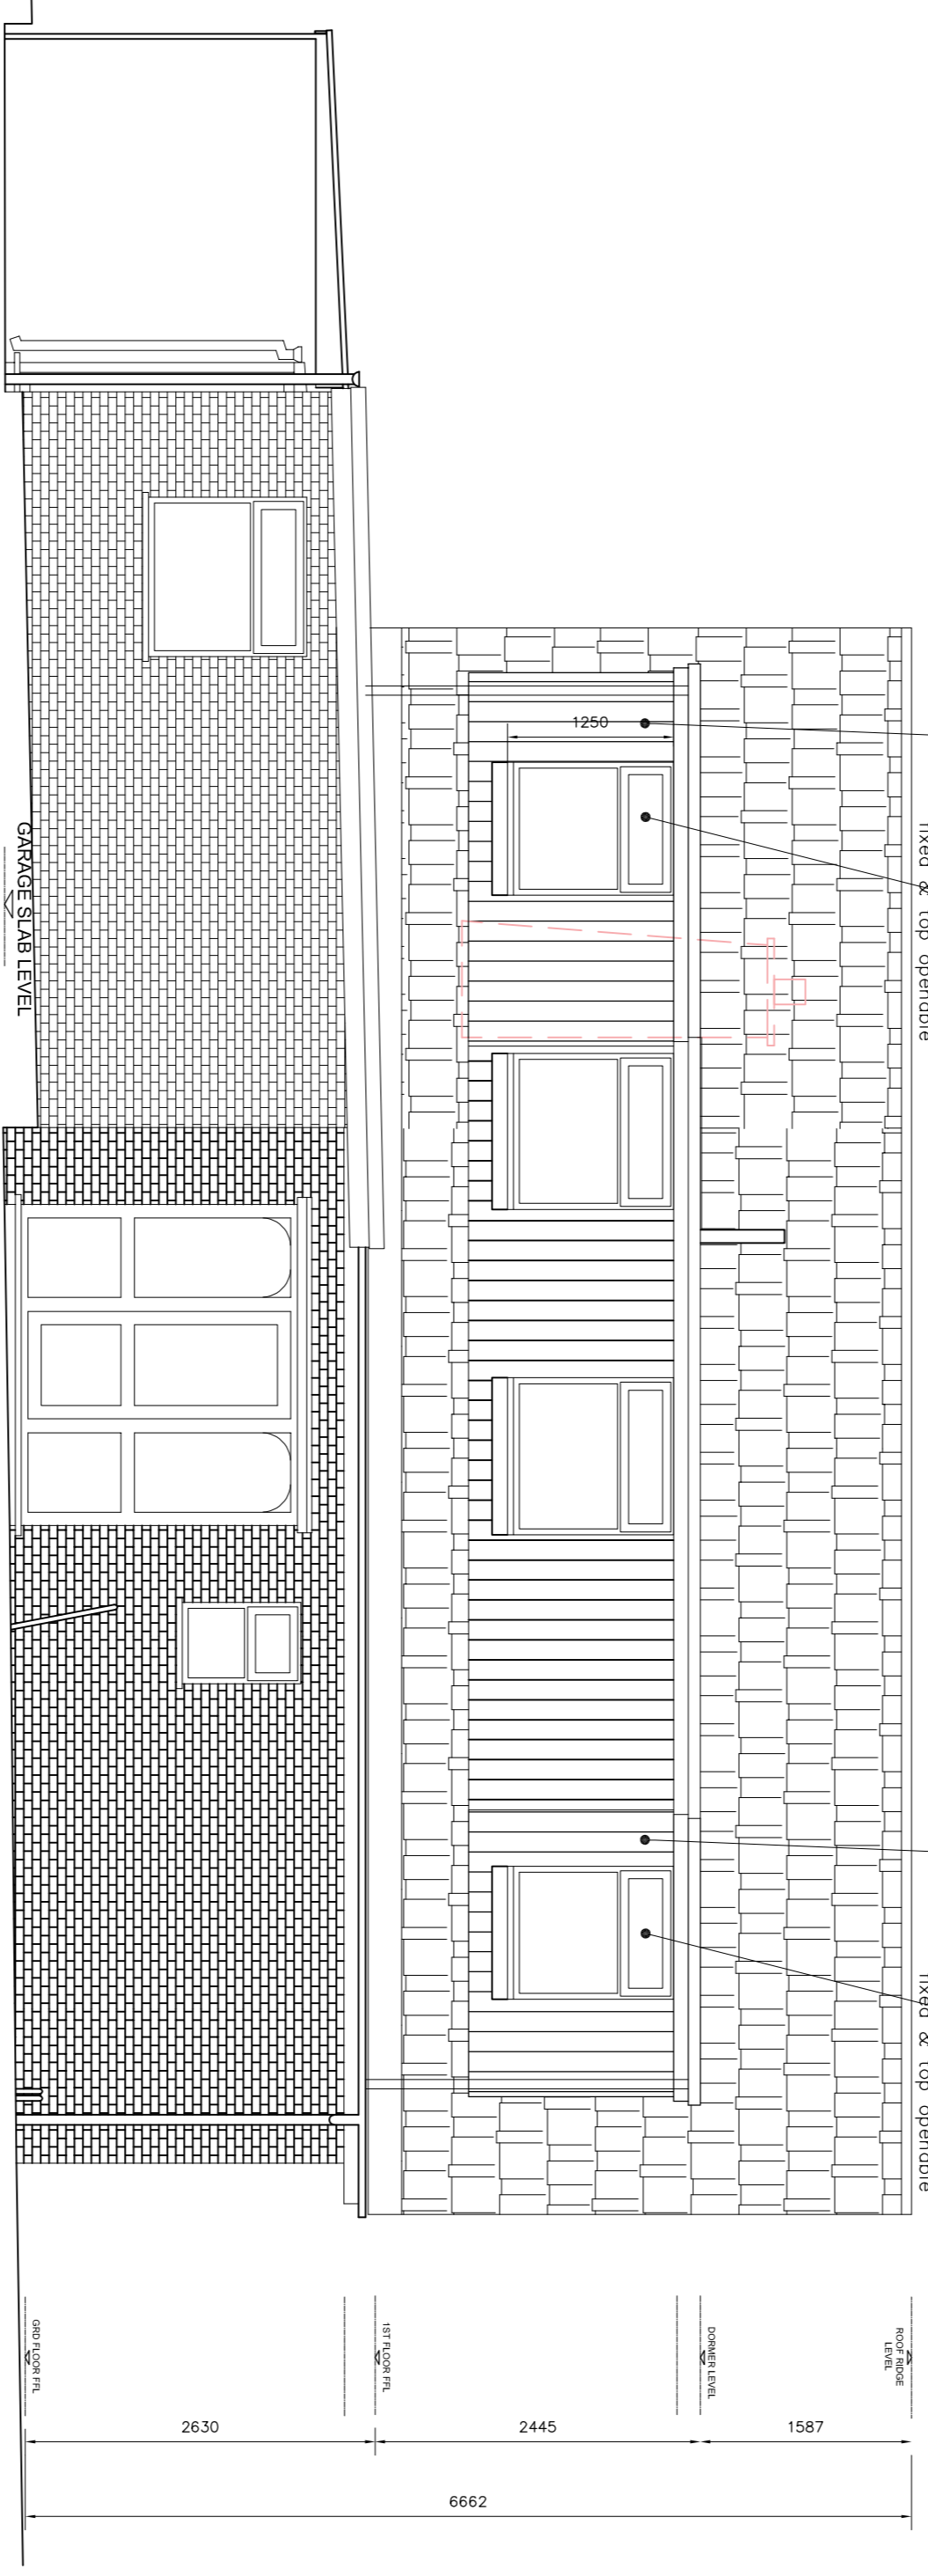

PROPOSED SIDE ELEVATION "B"
SCALE 1:50

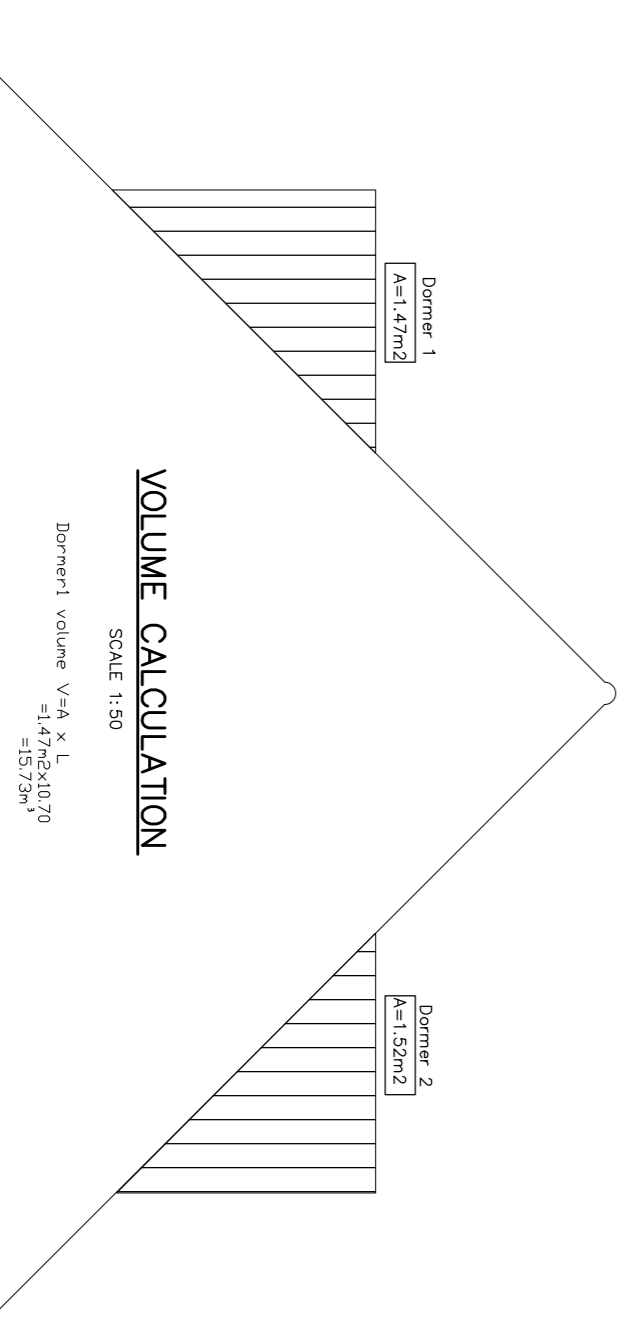

VOLUME CALCULATION
SCALE 1:50


Dormer 1 Volume via x L
= 11.47m x 11.47m x 11.47m
= 1502.82m³

Dormer 2 Volume via x L
= 11.47m x 11.47m x 11.47m
= 1502.82m³


Dormer 1 + Dormer 2 = 3005.64m³

Roof Volume via x L
= 11.47m x 11.47m x 11.47m
= 1502.82m³

Total Volume = 4508.46m³

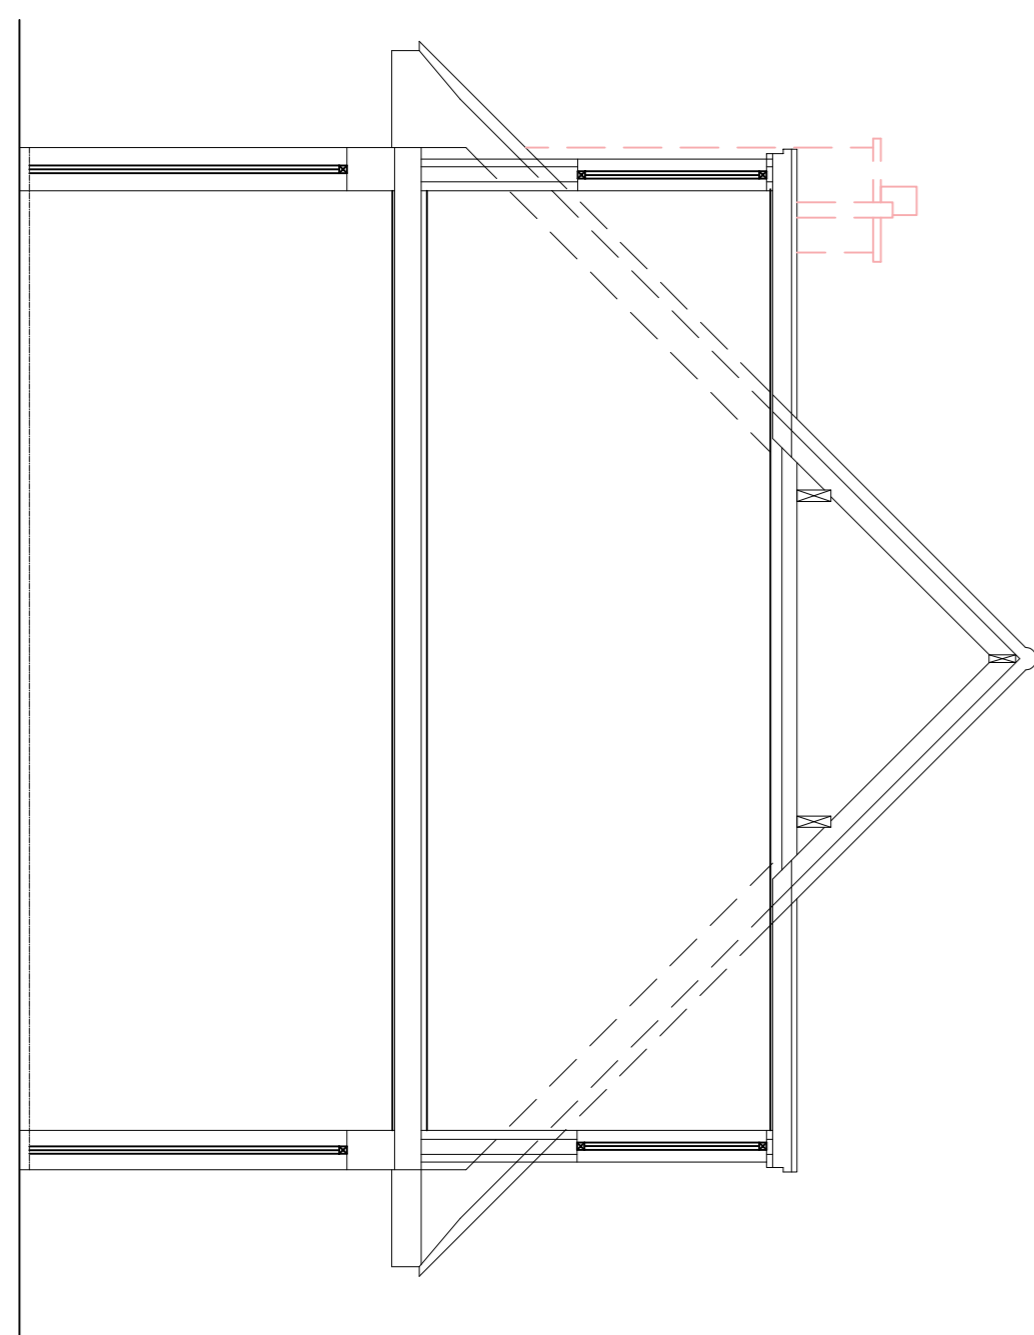

PROPOSED SECTION A-A
SCALE 1:50

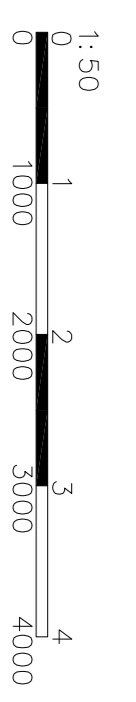

ONE & STRUCTURAL ENGINEERS

Planning & Design

18 Tunnel Wood Road WD17 4NN

Scale 1:50

Project No. KKR-1523

Drawing No. PL-04

Size A1

Date JULY 2023

Client: SS

Project Title: 18 Tunnel Wood Road WD17 4NN

Project No: KKR-1523

Drawing No: PL-04

Scale: 1:50

Size: A1

Date: JULY 2023

Client: SS