





Proposed South East Elevation

1 · 100

Proposed South West Elevation

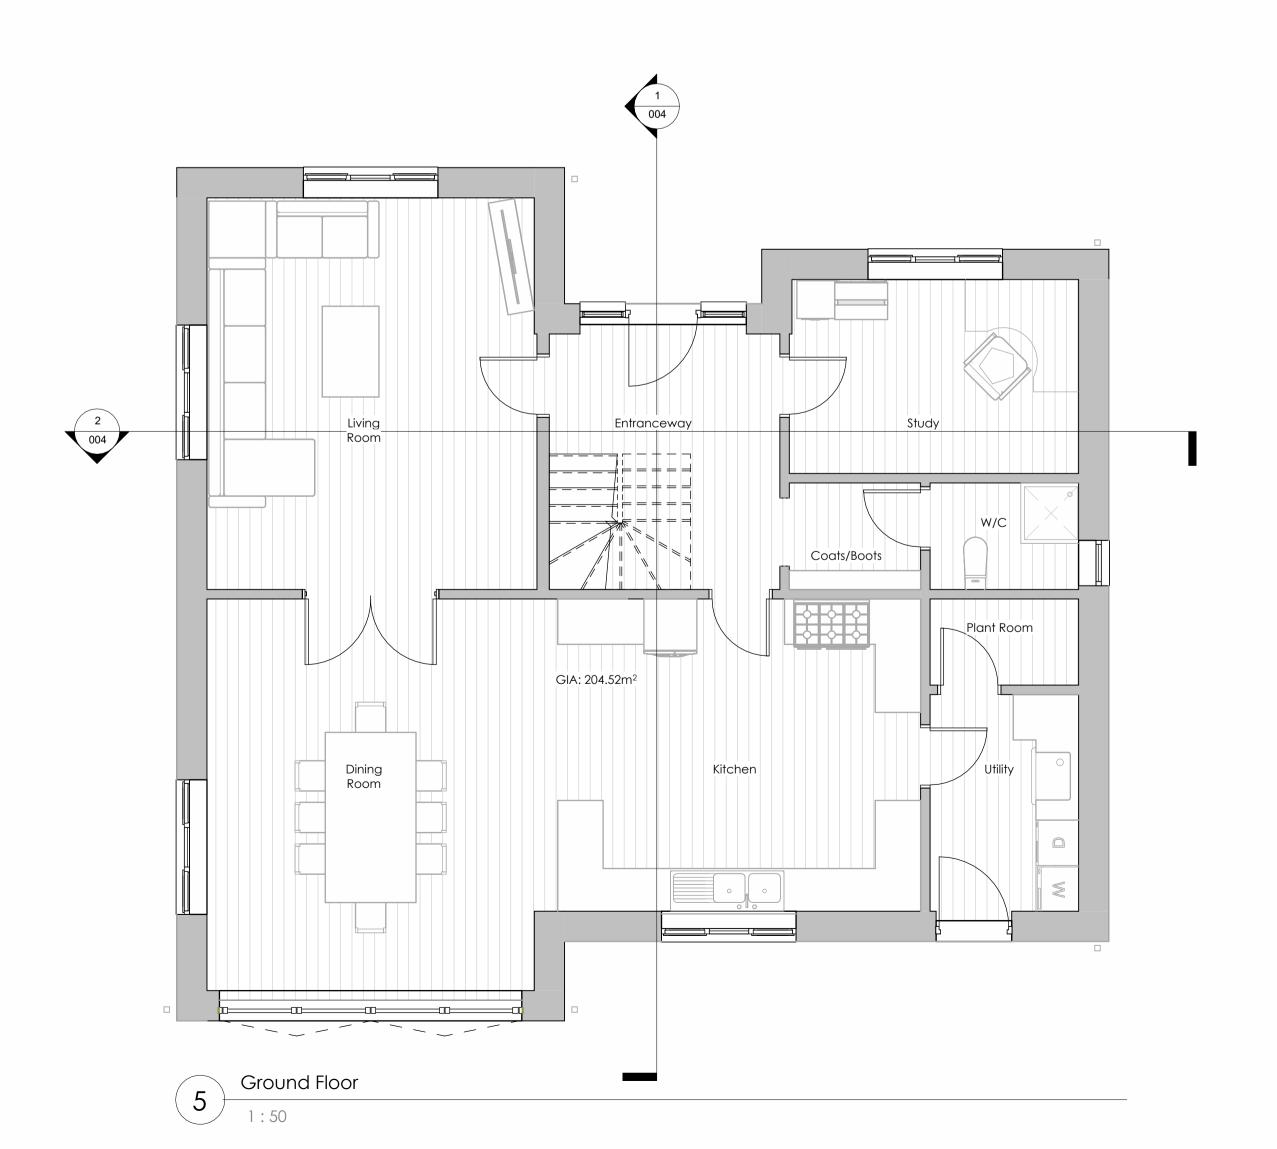

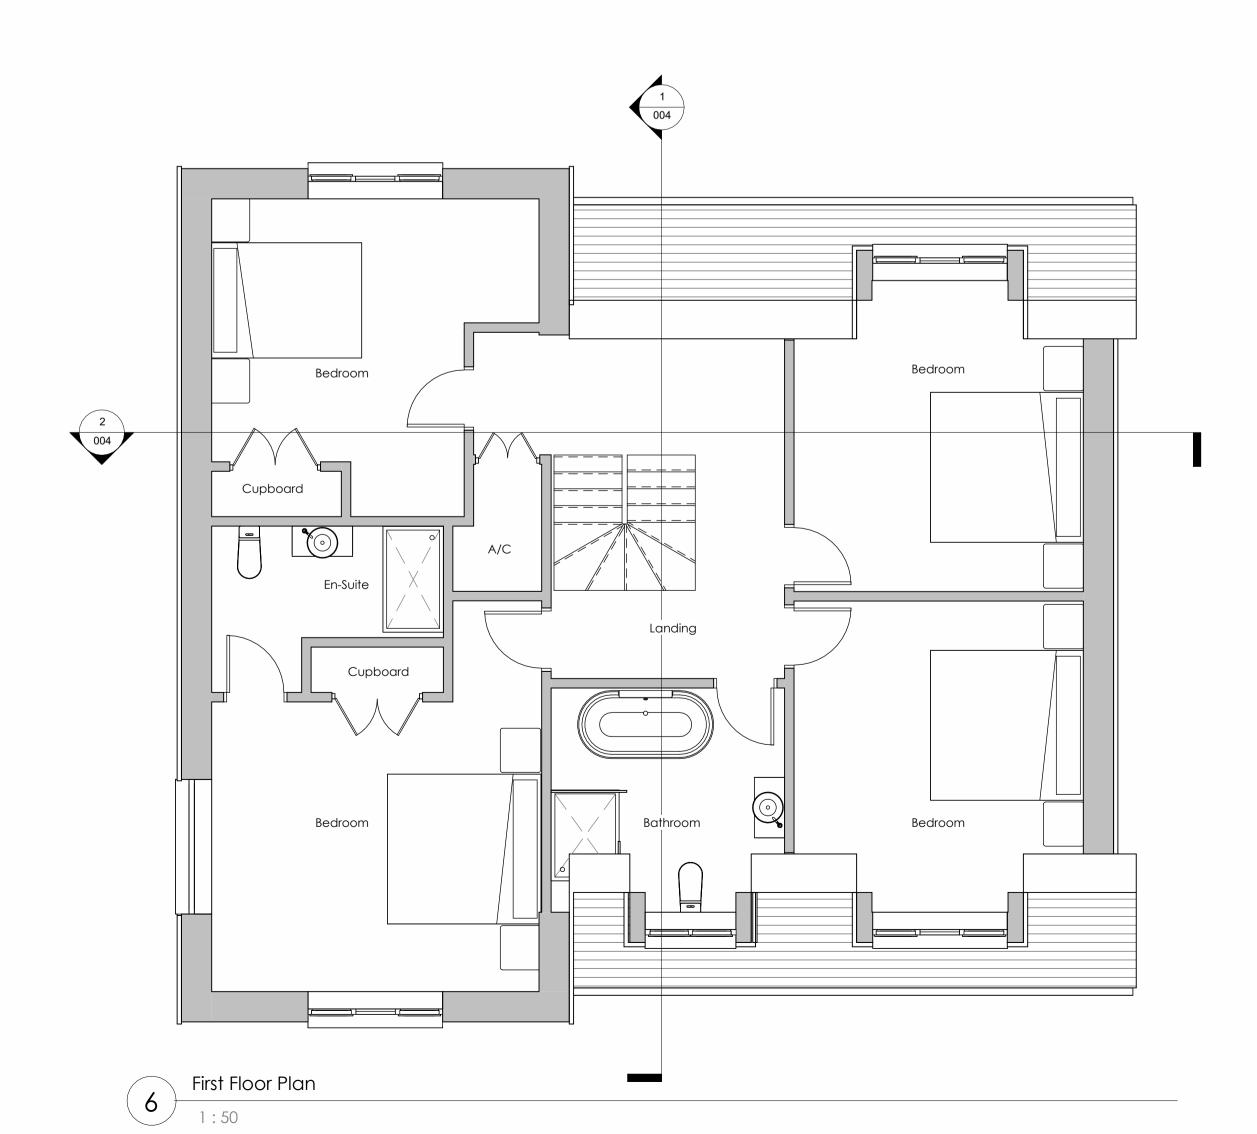



Product Mixed Bird & Bat Box Kits
Product- F5MBB

Panels FSC Certified Exterior Grade European Birch Plywood

Sundries Nails, screw (hole boxes only), sandpaper, instructions

Finish None applied or provided but you might like to apply a

None applied or provided, but you might like to apply a non-toxic water based stain or preservative after assembly.

Height: 33cm, Width: 16cm, Depth: 9cm (Finished Bat Box); Height: 23cm, Width: 13cm, Depth: 15cm (Finished Bird Box)

0.9kg - 1.1kg per kit


ight 0.9kg - 1.1kg per kit

2 fixing holes in top corners of back panels

Bee Brick to be positioned ideally south facing, with no vegitation. Placed a min 1m above the ground level.



1. This drawing is the copyright of Cornwall Planning Group and may not be reproduced without licence.
2. The Contractor shall not scale off this drawing for construction purposes, only figured dimensions shall be worked from.
3. All dimensions and levels are to be checked on site by the Contractor before the commencement of any work and any discrepancies reported to the Architect.
4. No responsibility can be accepted for errors arising on site due to unauthorised variations from the Architects drawings.
5. The Contractor is recommended to visit the site before tendering to ascertain all local conditions and restrictions likely to affect the works. No claims arising from failure to do so will be considered.
6. Tenders must include for all the works described or being apparent on the drawings or can reasonably inferred as being necessary for the proper execution of the works.
7. This drawing is for town planning and building regulations only and is not a complete working drawing.
8. Depth, size and design of foundations shown are preliminary only, actual foundation, depth, size and design may differ depending on site conditions.
9. On completion of the works, if a National Home Energy Rating Certificate is required by the client, contact the Local Authority Building Control Department.
10.L1 and L2 requirements for limiting thermal bridging & air leakage workmanship shall be executed by the Contractor in accordance with the appropriate sections and DEFRE/DTLR guidance document "Limiting Thermal Bridging & Air Leakage: Robust Construction Details for Dwellings and Similar Buildings" available from The Stationery Office

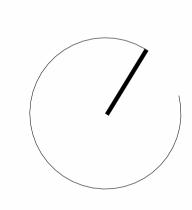

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Client: Mr R Thorpe

Project: Demolition & Construction of Dwelling Following Approval PA23/07250

Address: Penhale Paddock, Main Road, Ashton, Helston, Cornwall, TR13 9SD

Title: Proposed Plans & Elevations

Revisions

Rev. Issue Date Description by

Stage: PRE APP

Deita: 04/01/200

Scale: As indicated

Date: 24/01/2024

Drawn: AF Checked: CM

Project No: 2571 Drawing No: 003

Rev: