




- Notes**
1. Do not scale drawing.
 2. All dimensions are in millimeters unless noted otherwise.
 3. Not for construction unless otherwise shown.
 4. When appropriate, this drawing to be read in conjunction with project specific Designers Risk Assessments, produced in accordance with requirements of Regulation 13 of the Construction (Design and Management) Regulations 1994.

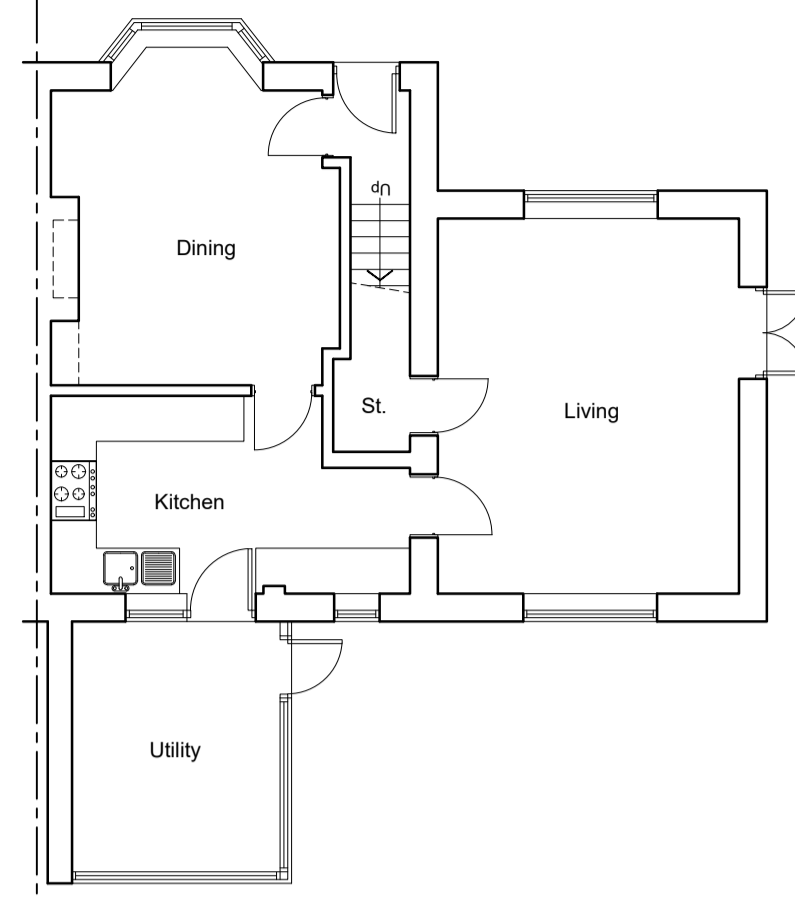


EXISTING GROUND FLOOR PLAN
Scale 1:100

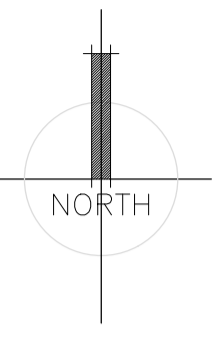


EXISTING REAR ELEVATION
Scale 1:100

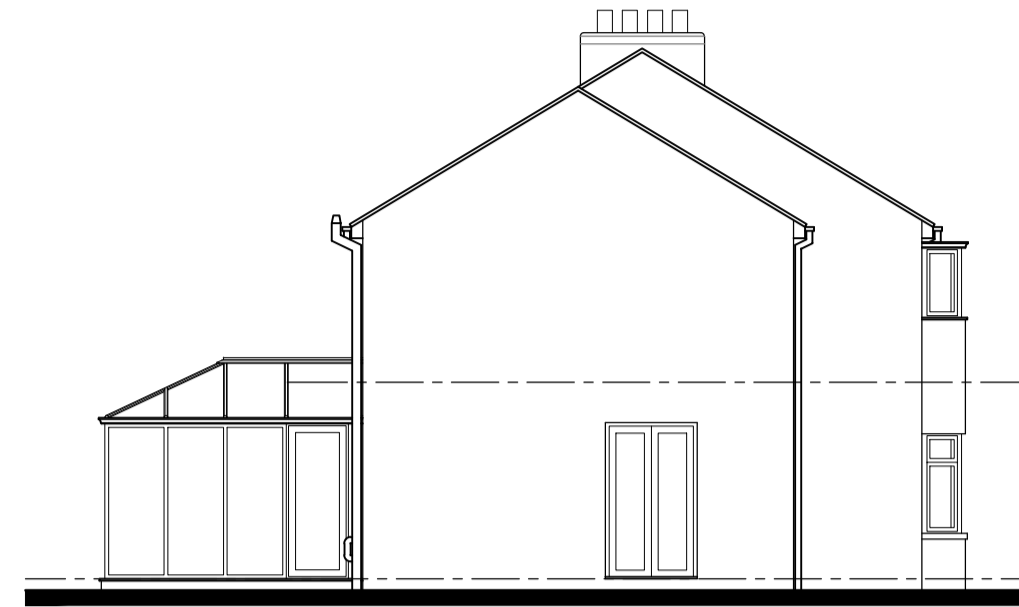


EXISTING SIDE ELEVATION
Scale 1:100

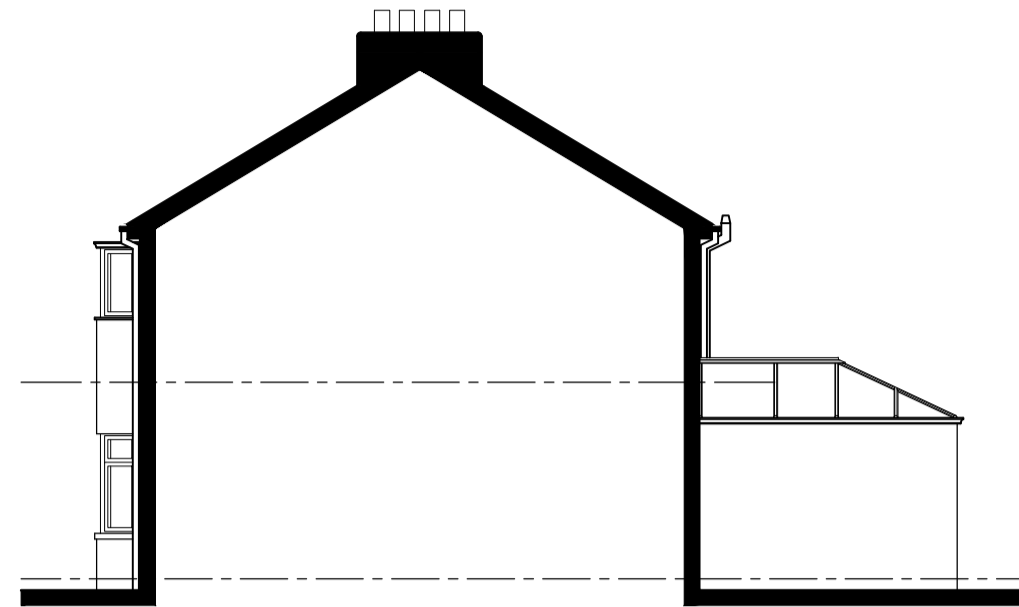

EXISTING SIDE ELEVATION
Scale 1:100

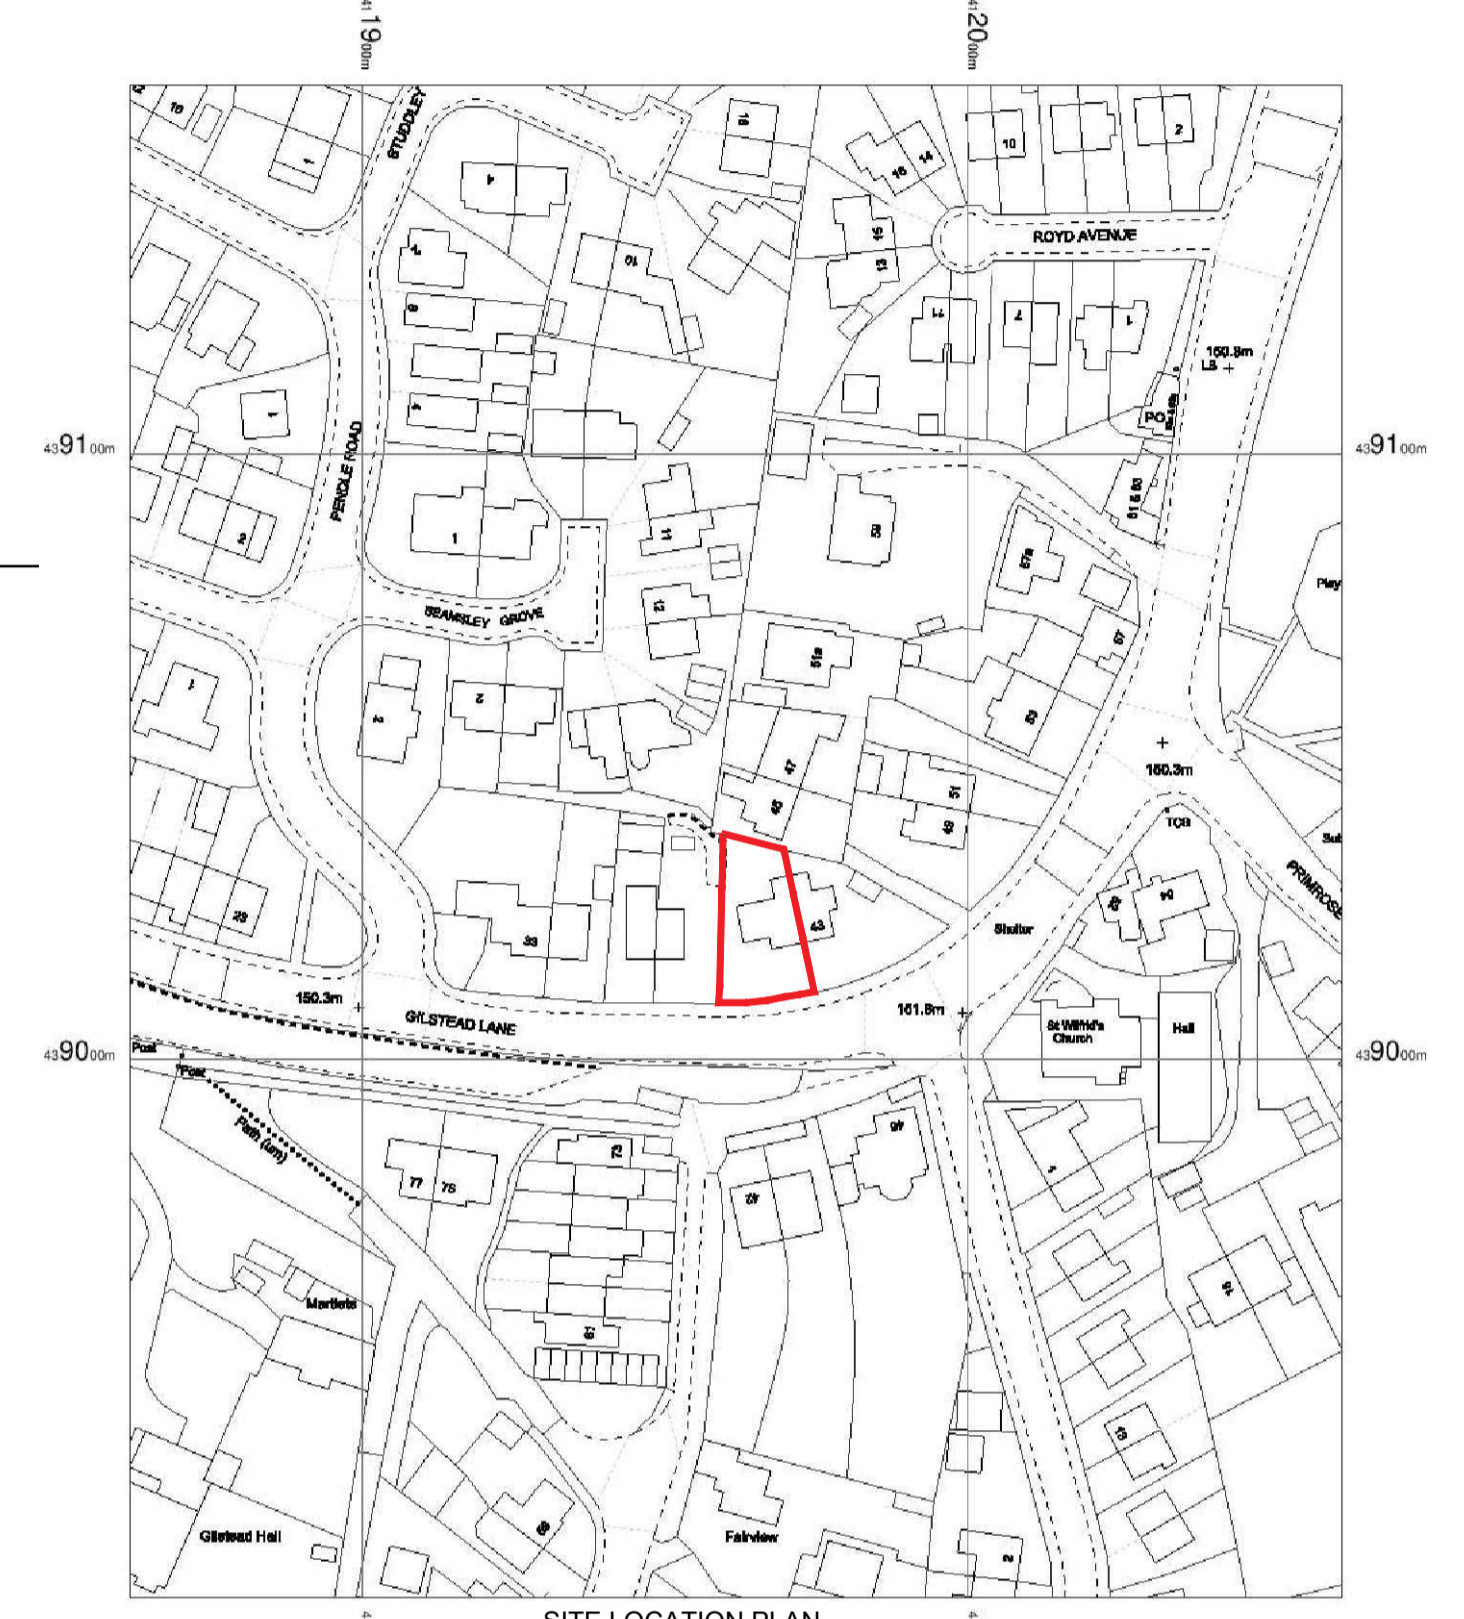

SITE LOCATION PLAN
Scale 1:1250

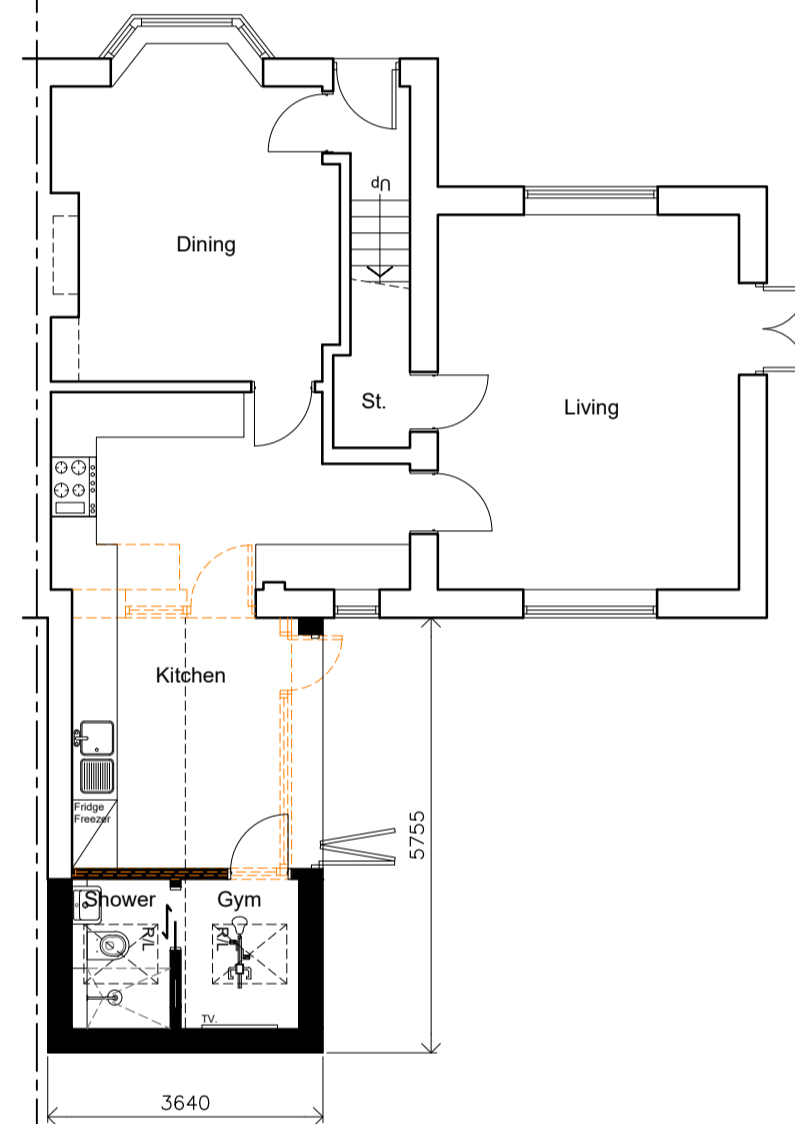


PROPOSED GROUND FLOOR PLAN
Scale 1:100




PROPOSED REAR ELEVATION
Scale 1:100



PROPOSED SIDE ELEVATION
Scale 1:100


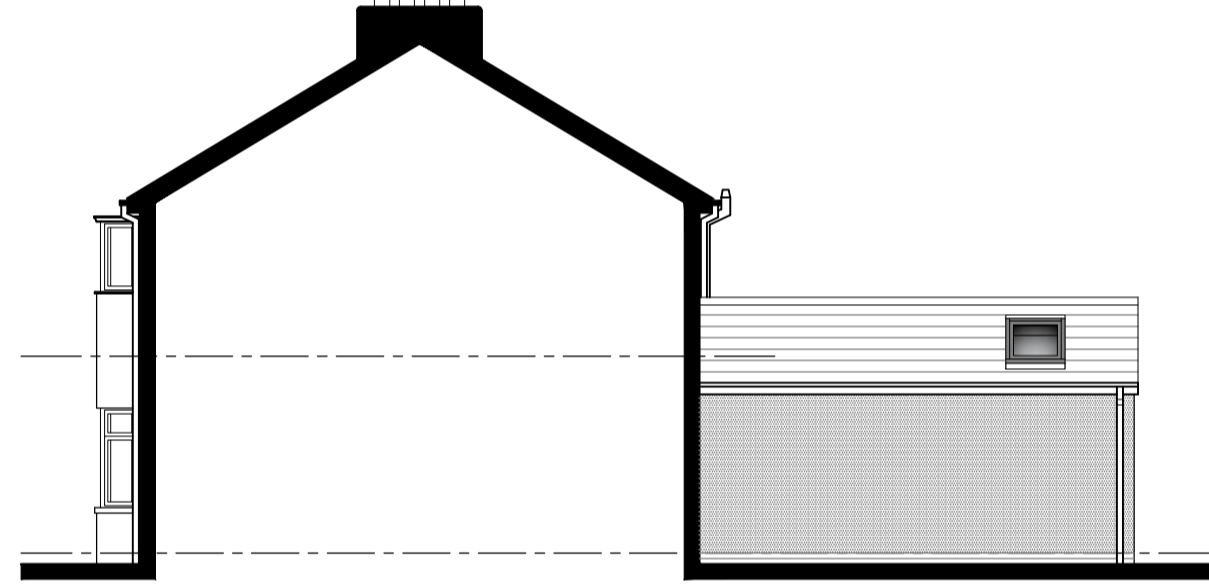


PROPOSED SIDE ELEVATION
Scale 1:100

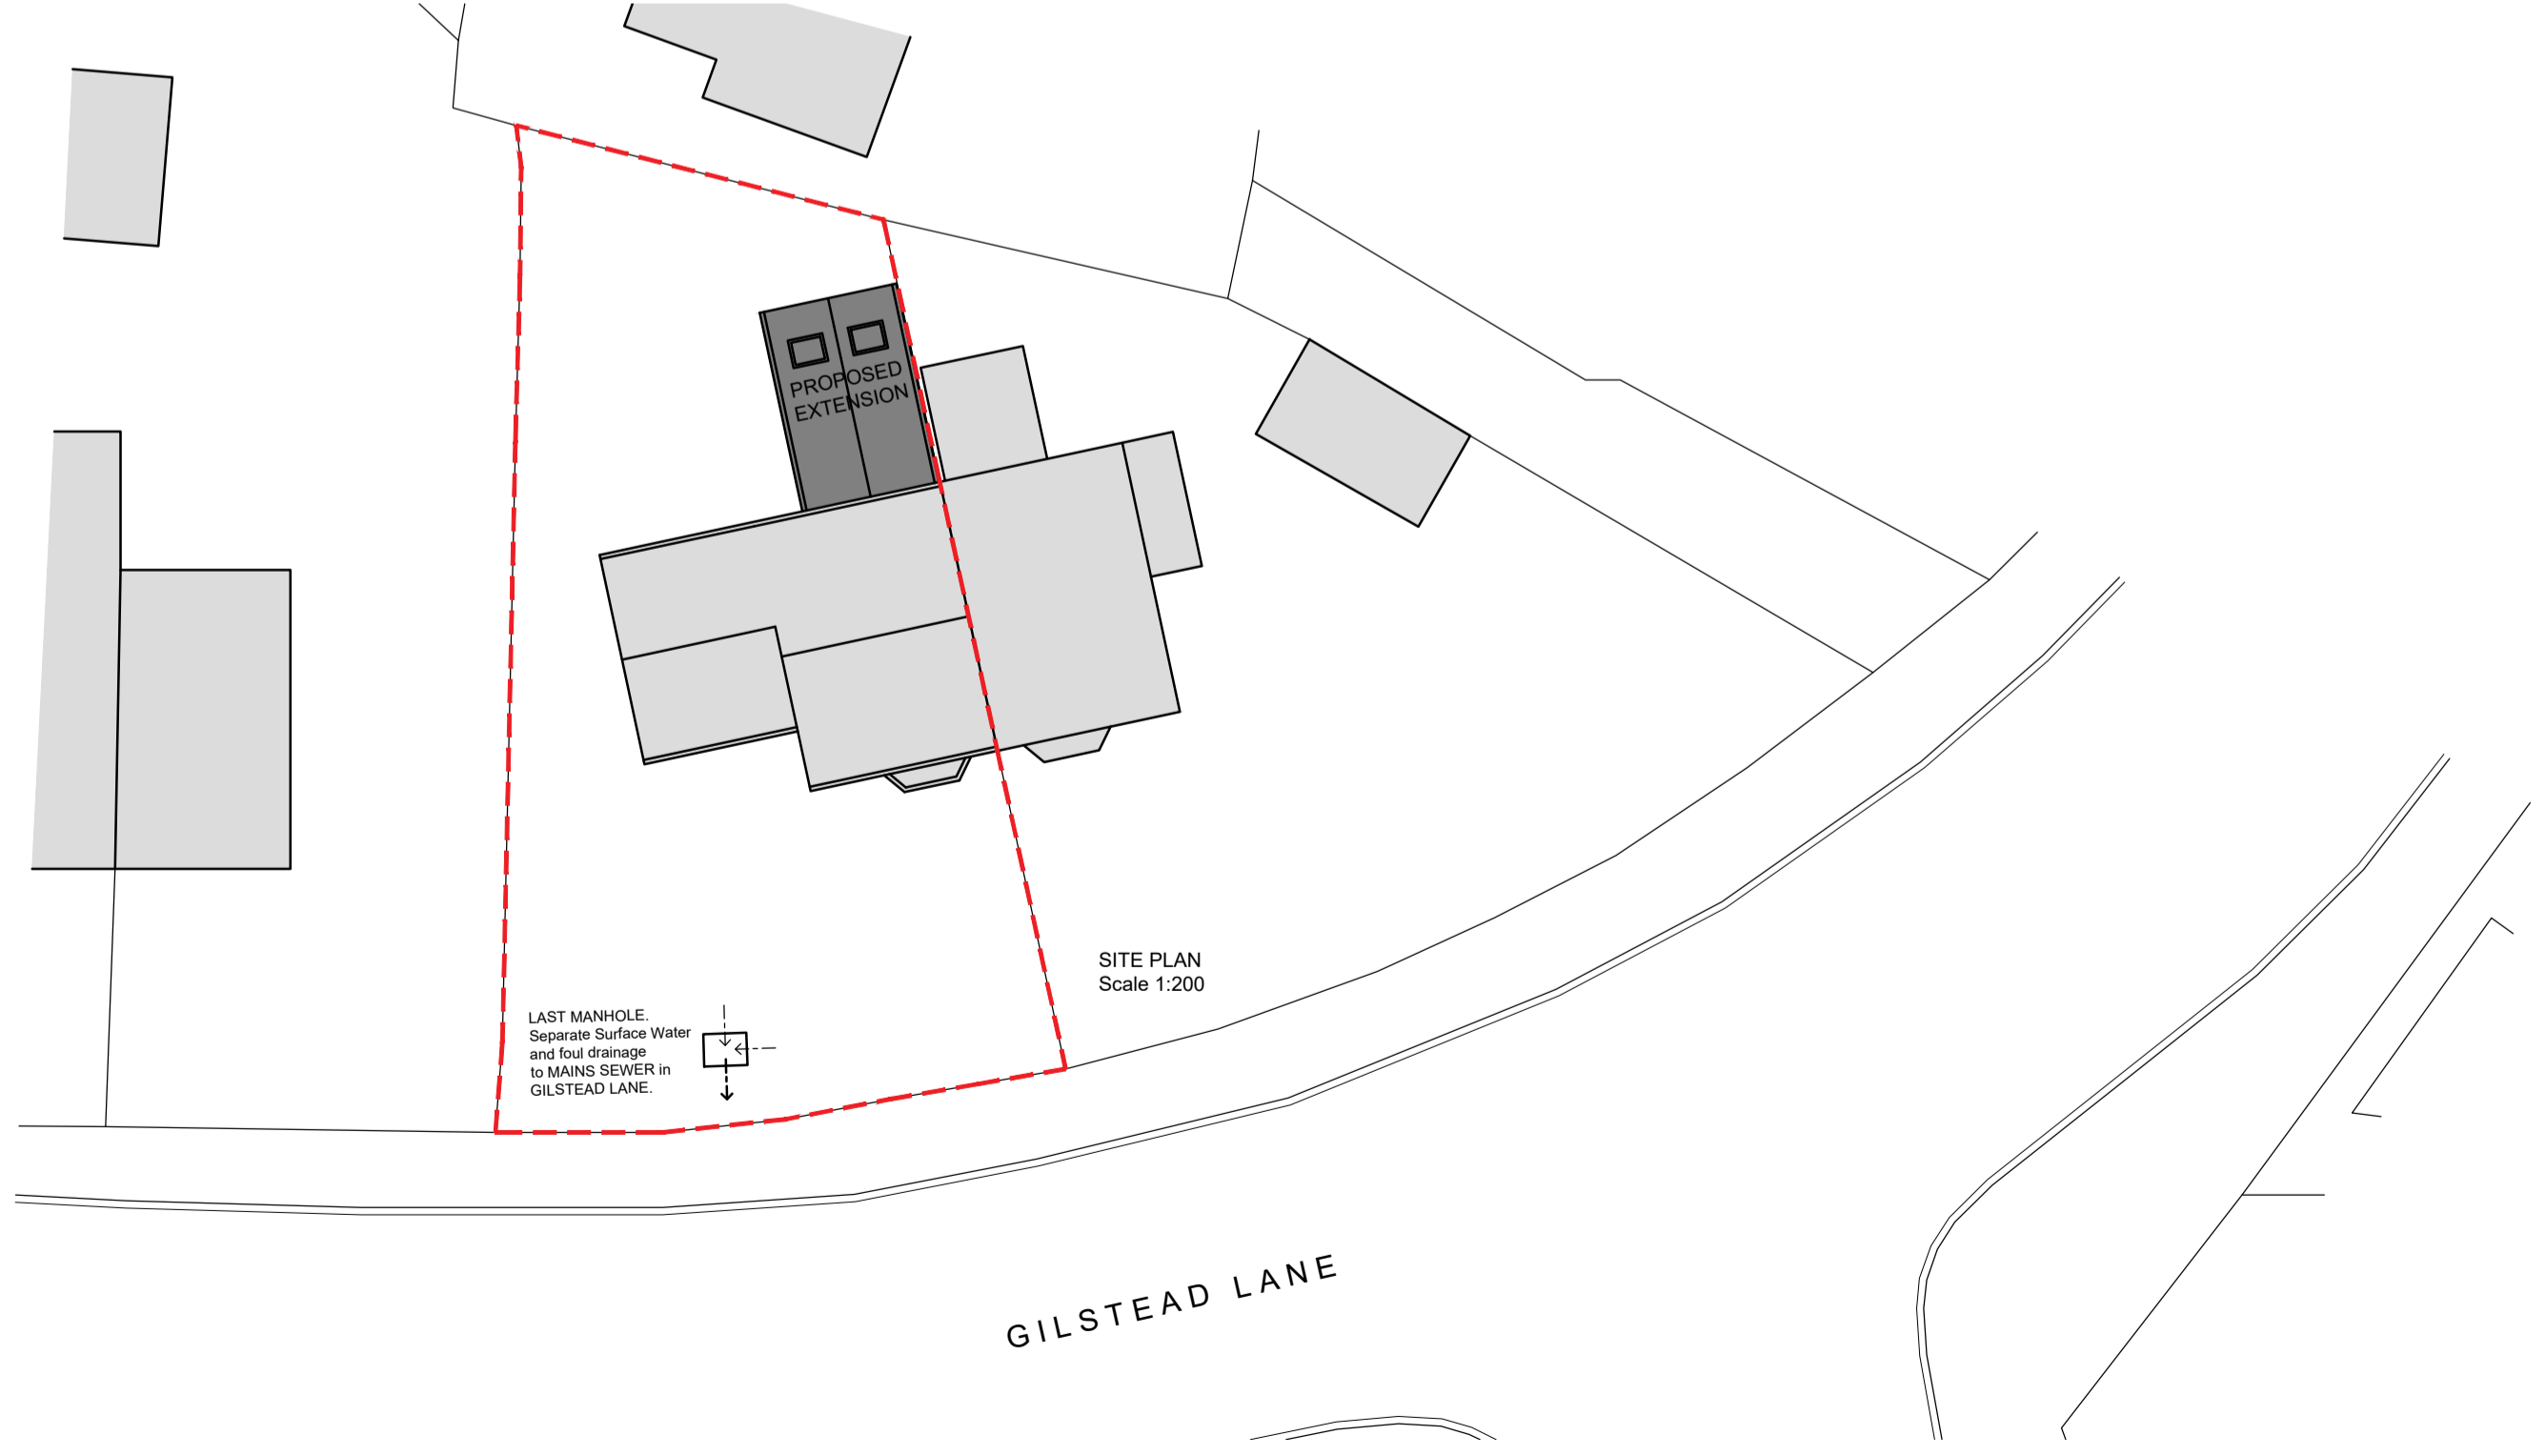

SITE PLAN
Scale 1:200

LAST MANHOLE
Separate Surface Water
and foul drainage
to MAINS SEWER in
GILSTEAD LANE.

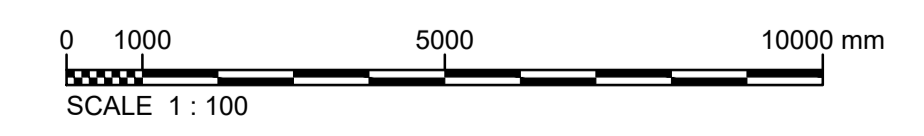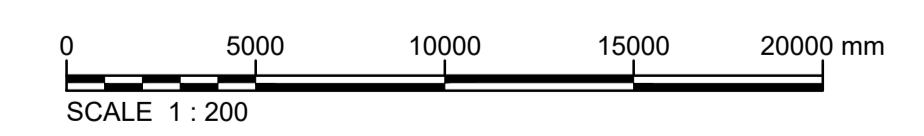

REV.	DATE	DESCRIPTION	DRN.	CKD.
B	30.01.24	Planning issue.	FD	AG
A	30.01.24	Revised following client comments received 30.01.24.	FD	AG

AM ARCHITECTURAL
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PROJECT
MR M. BULMER
PROPOSED REAR EXTENSION
41 GILSTEAD LANE
BINGLEY
BD16 3NL

TITLE
EXISTING FLOOR PLANS AND ELEVATIONS
PROPOSED FLOOR PLANS AND ELEVATIONS
SITE PLAN, SITE LOCATION PLAN

STAGE
PLANNING

JOB No. 2023 509	DWG No. 01	REV. B
SCALE 1:1250, 1:200, 1:100 @ A1	DATE January 2023	
DRAWN FDD	CHECKED AMG	