

TOPOGRAPHICAL & MEASURED BUILDING SURVEYS

ABBREVIATIONS & SYMBOLS

AH	Arch Head Height	FH	Fire Hydrant	RSJ	Rolled Steel Joist
AR	Assumed Route	FBD	Floor Board Direction	SI	Sign Post
AV	Air Valve	FL	Floor Level	SP	Arch Spring Point Height
BB	Beltline Beacon	FL	Floor Level	SV	Stop Valve
BH	Bore Hole	FP	Flag Pole	SW	Surface Water
BL	Bed Level	FW	Four Water	SY	Stair
BO	Rotator	GS	Gully Grate	Tac	Tactile Paving
BRP	Brace Post	GV	Gas Valve	TC	Telecom Cover
BS	Bus Stop	HH	Head Height	TH	Trail Pit
BU	Bus	IC	Inspection Cover	TL	Threshold Level
BW	Barbed Wire Fence	IL	Invert Level	TL	Traffic Light
BX	Box (Utilities)	IR	Iron Railings	TOW	Top of Wall
CIB	Cross Board Fence	KD	Kerb Outlet	TP	Telegraph Pole
CH	Cill Height	LP	Lamp Post	TV	Cable TV Cover
CL	Cover Level	MH	Manhole	UB	Universal Beam
CA	Chain Link Fence	MP	Marker Post	UC	Unknown Cover
C-LEV	Ceiling Level	NS	Name Board	UK	Unknown Tree
Col	Column	OHL	Overhead Line (approx)	USB	Under Side Beam
CIP	Chestnut Paving Fence	Plan	Panel Fence	UTL	Unable To Lift
CR	Cable Reeler	PB	Post Box	VP	Vent Pipe
DC	Drainage Channel	PM	Parking Meter	WB	Waste Bin
DH	Door Head Height	PO	Post	WH	Woop Hole
DP	Down Pipe	PR	Post & Rail Fence	WL	Water Level
DR	Drain	PWF	Post & Wire Fence	WM	Water Meter
EL	Eaves Level	P/Wall	Partition Wall	WO	Wash Out
EP	Electric Pole	RE	Rodding Eye	⊙	Floor to Ceiling Height
ER	Earth Road	RL	Ridge Level	⊙	Floor to Ceiling Height
ET	EP-Transformer	RP	Reflector Post	⊙	Floor to False Ceiling Ht
FB	Flower Bed	RS	Road Sign	⊙	Road Sign
FBD	Floor Board Direction	RSD	Rooster Shutter Door	⊙	Survey Control Station

DRAWING NOTE

Topographical Surveys
Trees are drawn to scale showing the average canopy spread. Descriptions and heights should be used as a guide only.

All building names, descriptions, number of storeys, construction type including roof line details are indicative only and taken externally from ground level.

All below ground details including drainage, voids and services have been identified from above ground and therefore all details relating to these features including, sizes, depth, description etc will be approximate only. All critical dimensions and connections should be checked and verified prior to starting work.

Detail, services and features may not have been surveyed if obstructed or not reasonably visible at the time of the survey.

Measured Building Surveys
Measurements to internal walls are taken to the wall finishes at approx 1m above the floor level and the wall assumed to be vertical.

Cill heights are measured as floor to the cill and head heights are measured from cill to the top of window.

General
The contractor must check and verify all site and building dimensions, levels, utilities and drainage details and connections prior to commencing work. Any errors or discrepancies must be notified to Survey Solutions immediately.

The accuracy of the digital data is the same as the plotting scale implies. All dimensions are in metres unless otherwise stated.

The survey control listed is only to be used for topographical surveys at the stated scale. All control must be checked and verified prior to use.

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Do not scale from this drawing
The coordinate system established for this survey is related to Ordnance Survey (OS) national grid at a single point using Smartnet, then orientated to grid north with a scale factor of 1.000

The level datum established for this survey is related to Ordnance Survey (OS) using GPS Smartnet.
To avoid discrepancies any coordinated data used in conjunction with this survey must be derived directly from this control data.

SURVEY CONTROL CO-ORDINATES

STATIONS	EASTINGS	NORTHINGS	LEVEL	DESCRIPTION

REV	DESCRIPTION	DRAWN	APPR	DATE





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LAND SURVEYING BUILDING SURVEYING UNDERGROUND SURVEYING

PROJECT TITLE
**MANDEVILLE GRANGE NURSING HOME,
201-203 WENDOVER ROAD, STOKE MANDEVILLE, HP21 9PB**

DRAWING DETAIL
MEASURED BUILDING SURVEY
Sheet 1 of 2


CLIENT TOOLEY & FOSTER PARTNERSHIP		SCALE 1:100	
SURVEYOR GWP	SURVEY DATE 15-03-2019	CHECKED BY IA	APPROVED BY PDS
DRAWING NUMBER 23900cv-02	REVISION	ISSUE DATE 21-03-2019	

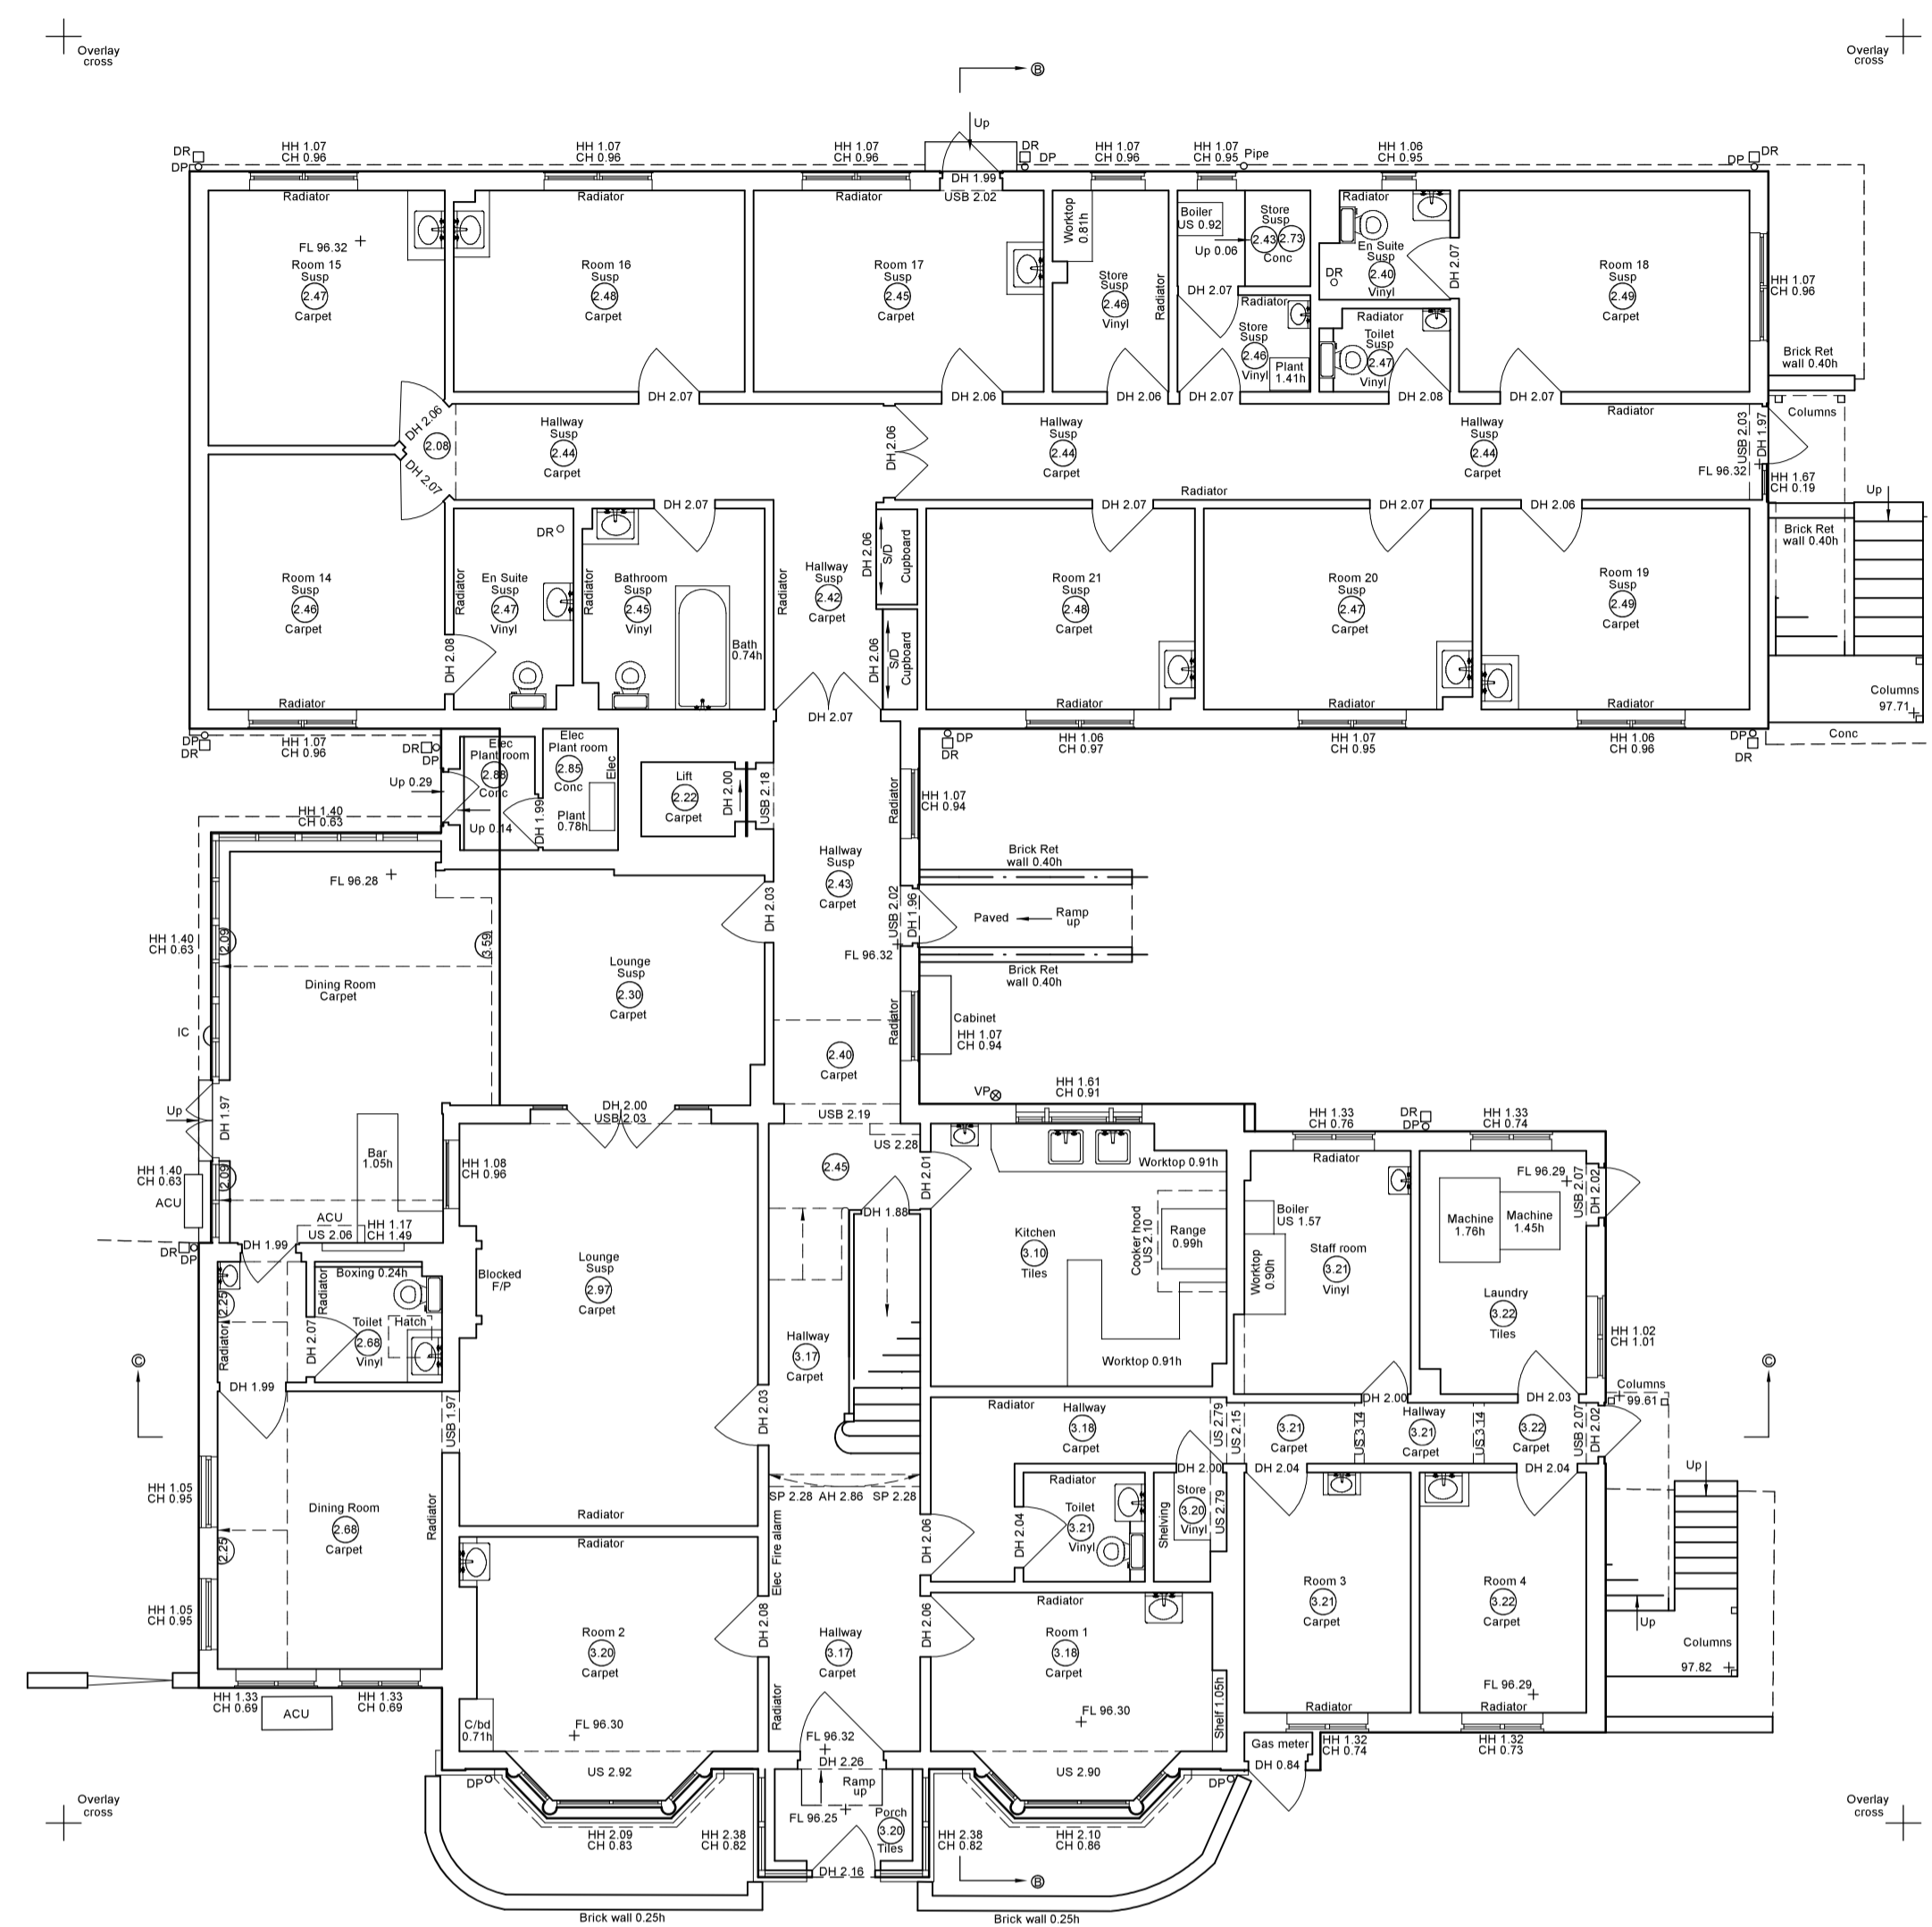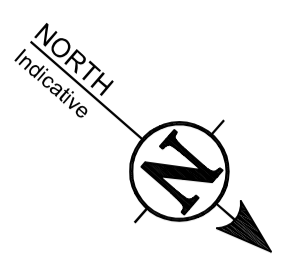


Ground Floor Plan



First Floor Plan

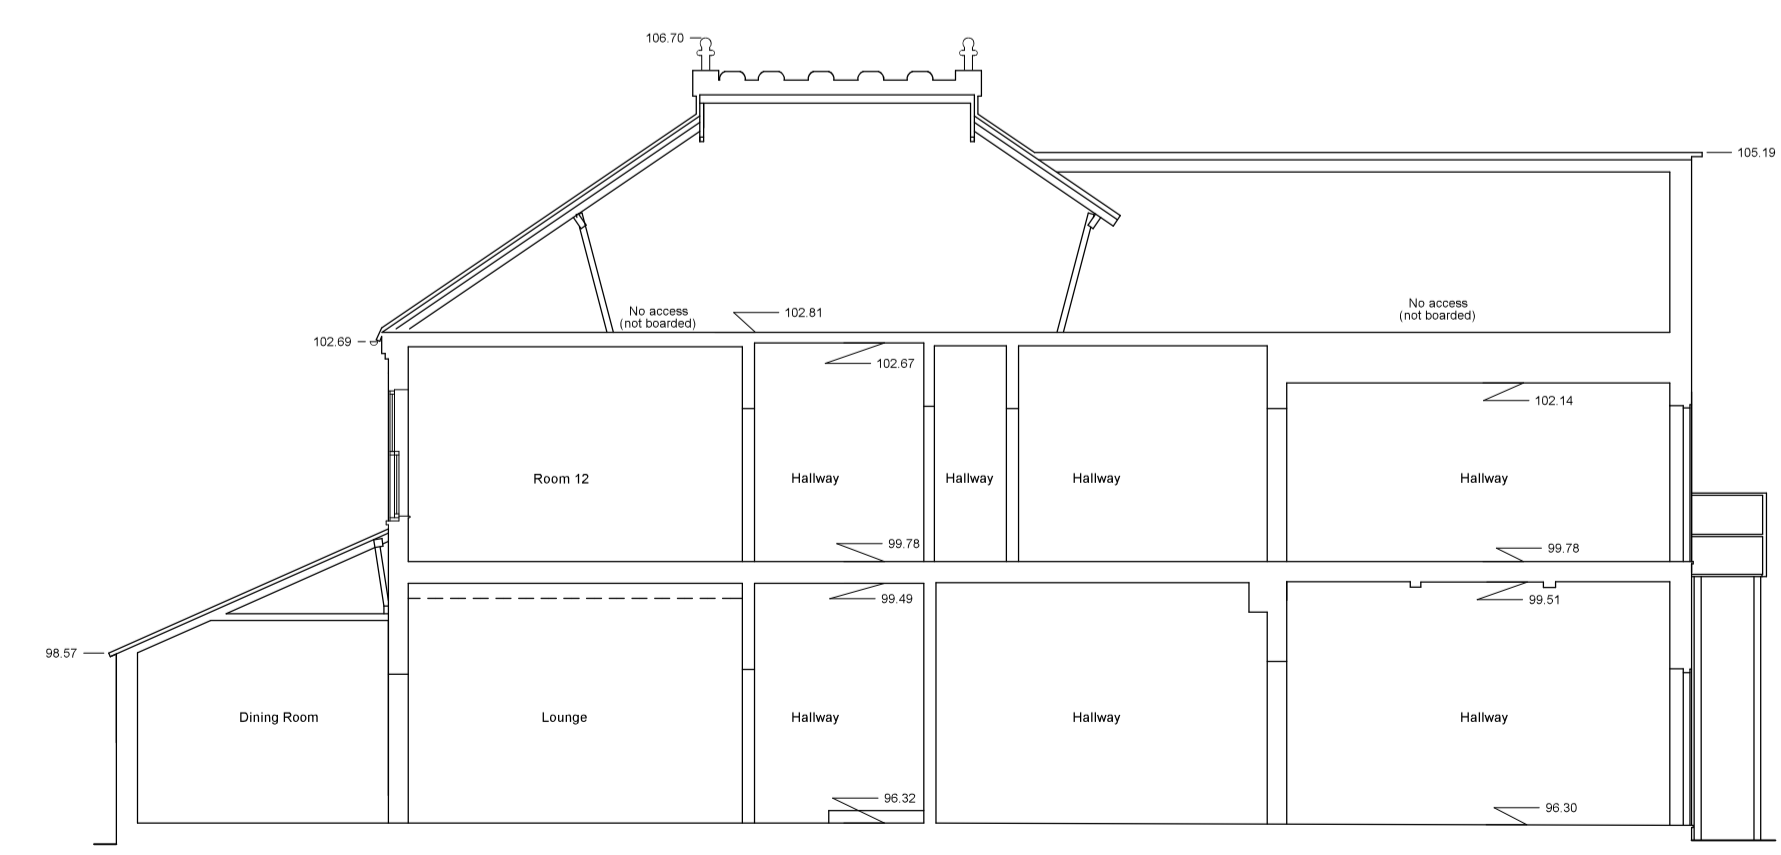

Datum 95.00m Section C-C

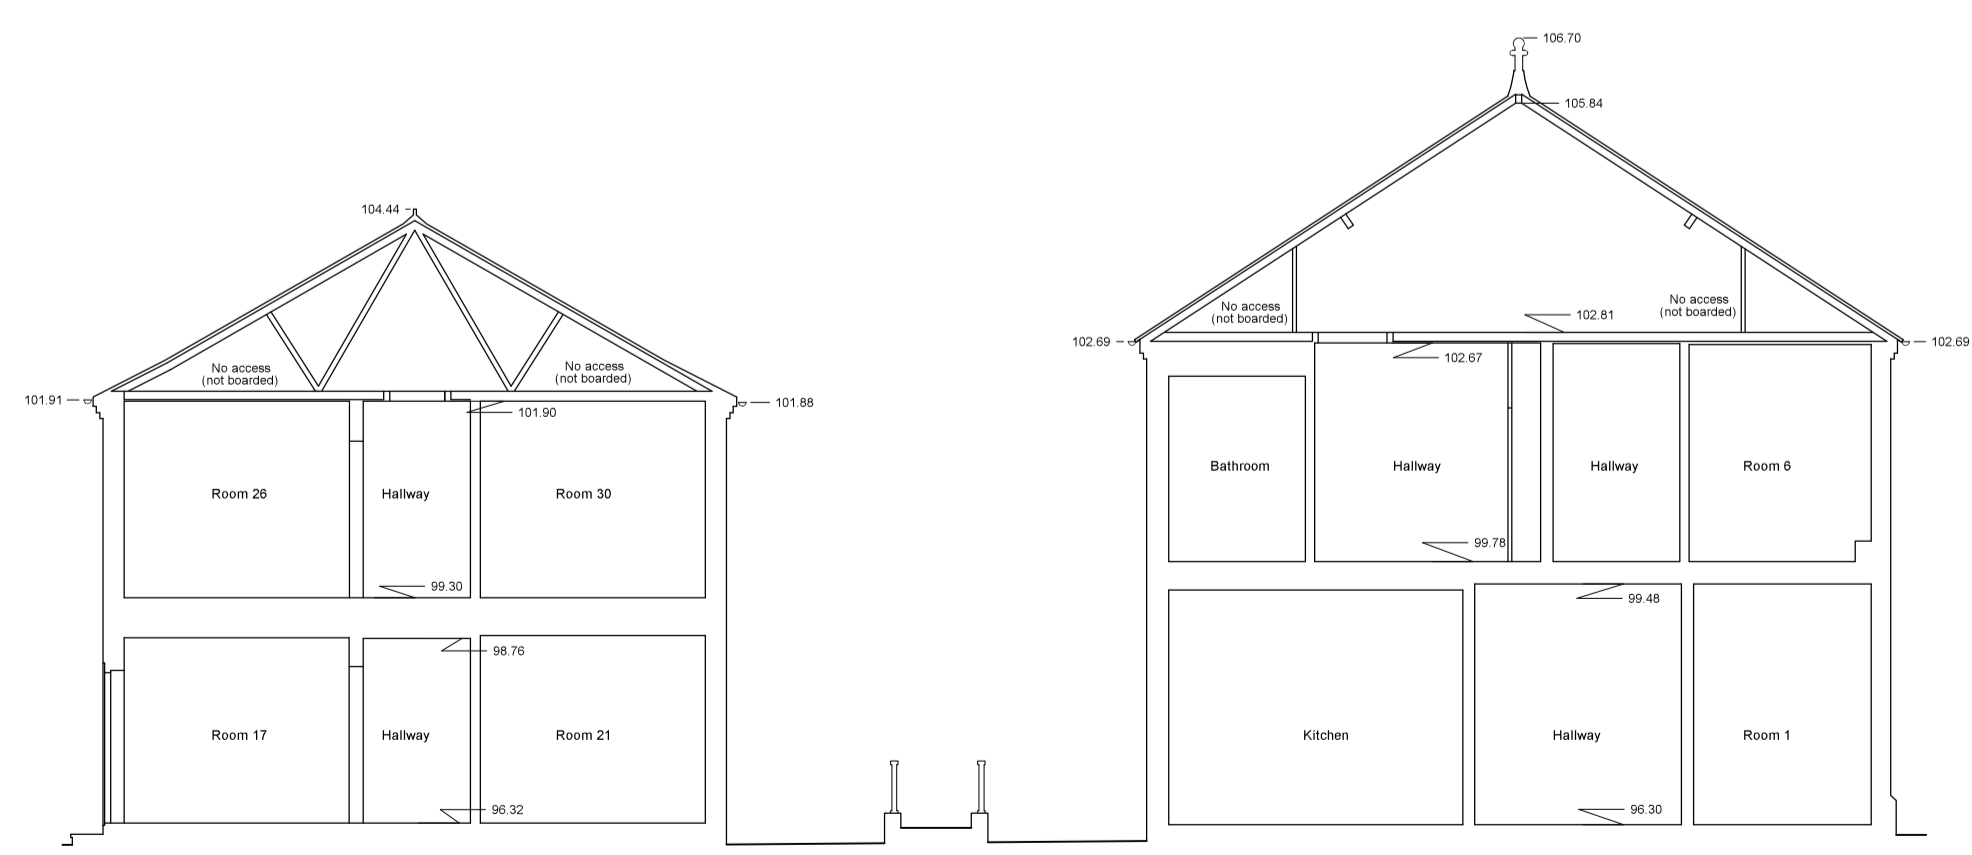

Datum 95.00m Section B-B