


Notes:

1. If this drawing has been received electronically it is the recipients responsibility to print the document to the correct scale.
2. All dimensions are in millimeters unless stated otherwise. It is recommended that information is not scaled off this drawing.
3. This drawing should be read in conjunction with all other relevant drawings and specifications.
4. All boundaries, dimensions and levels are to be checked on site before construction and any discrepancies are to be reported to the Architect.
5. For the purpose of coordination, all relevant parties must check this information prior to implementation and report any discrepancies to the Architect.

EXISTING MSA BUILDING

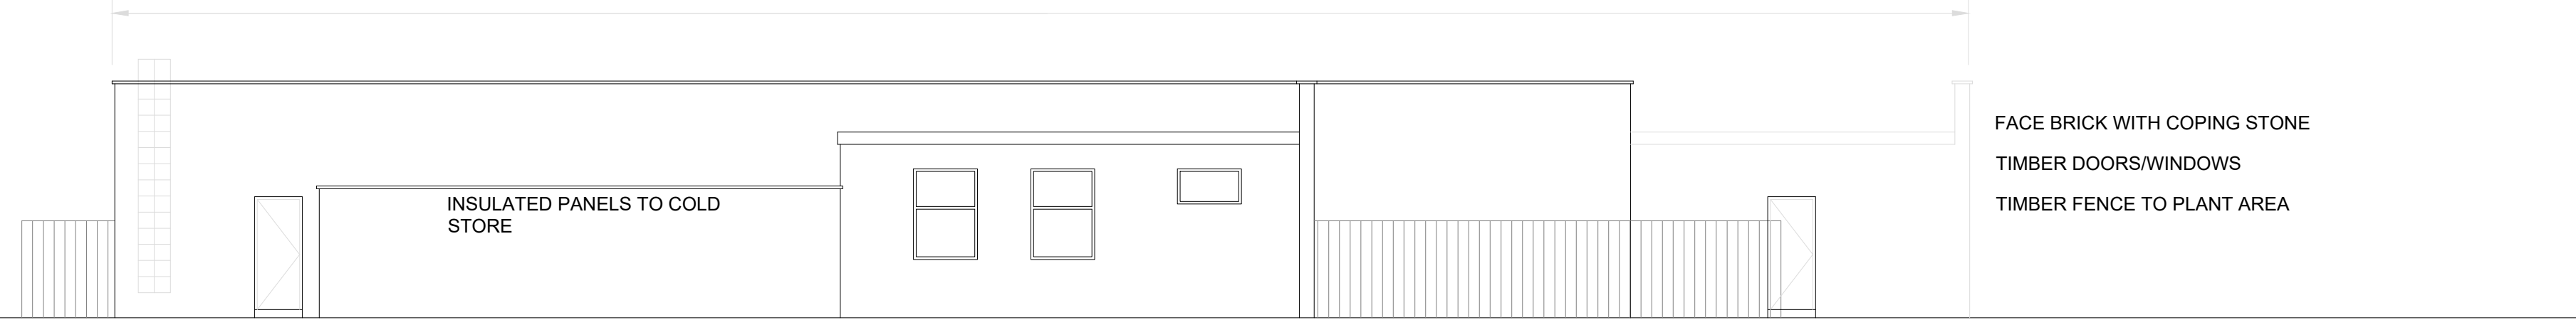


FACE BRICK WITH COPING STONE
TIMBER DOORS/WINDOWS
TIMBER FENCE TO PLANT AREA

Existing North Elevation

Scale 1:100

EXISTING MSA BUILDING

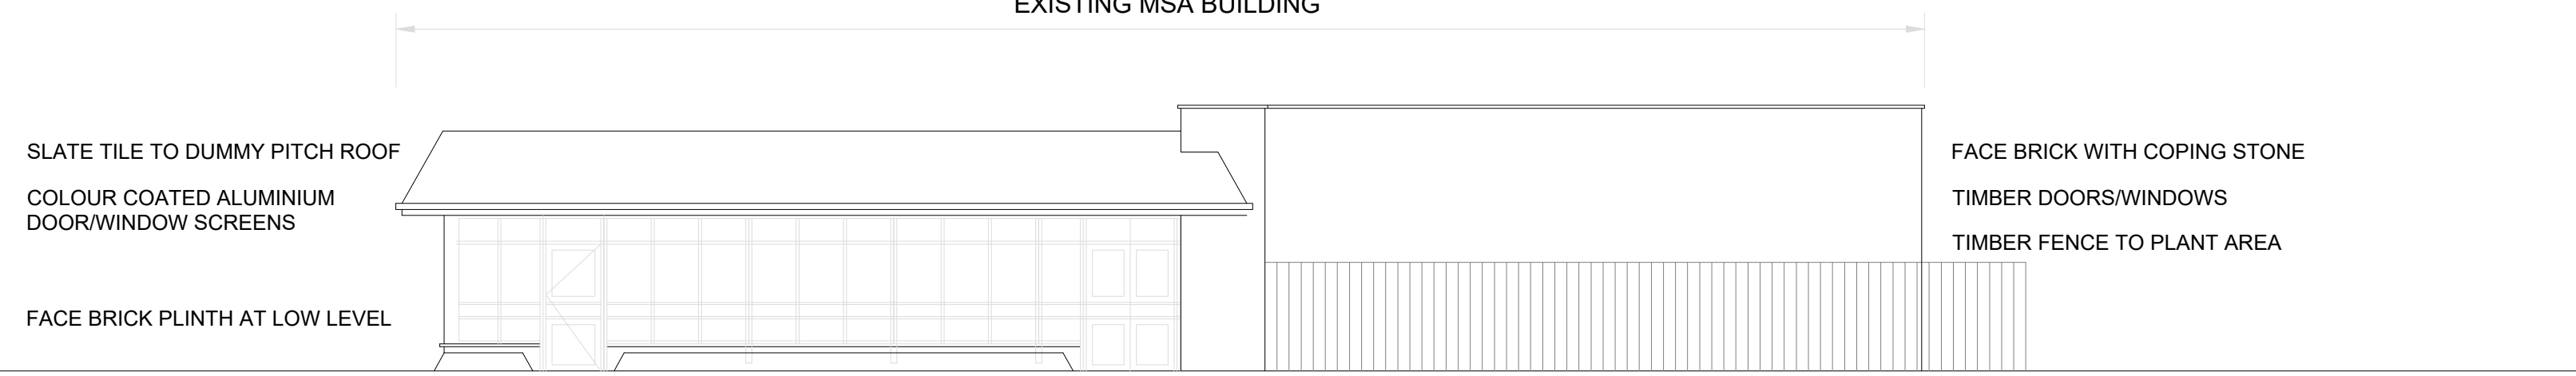


SLATE TILE TO DUMMY PITCH ROOF
COLOUR COATED ALUMINIUM
DOOR/WINDOW SCREENS
FACE BRICK PLINTH AT LOW LEVEL

FACE BRICK WITH COPING STONE
TIMBER DOORS/WINDOWS
TIMBER FENCE TO PLANT AREA

Existing East Elevation

Scale 1:100

EXISTING MSA BUILDING

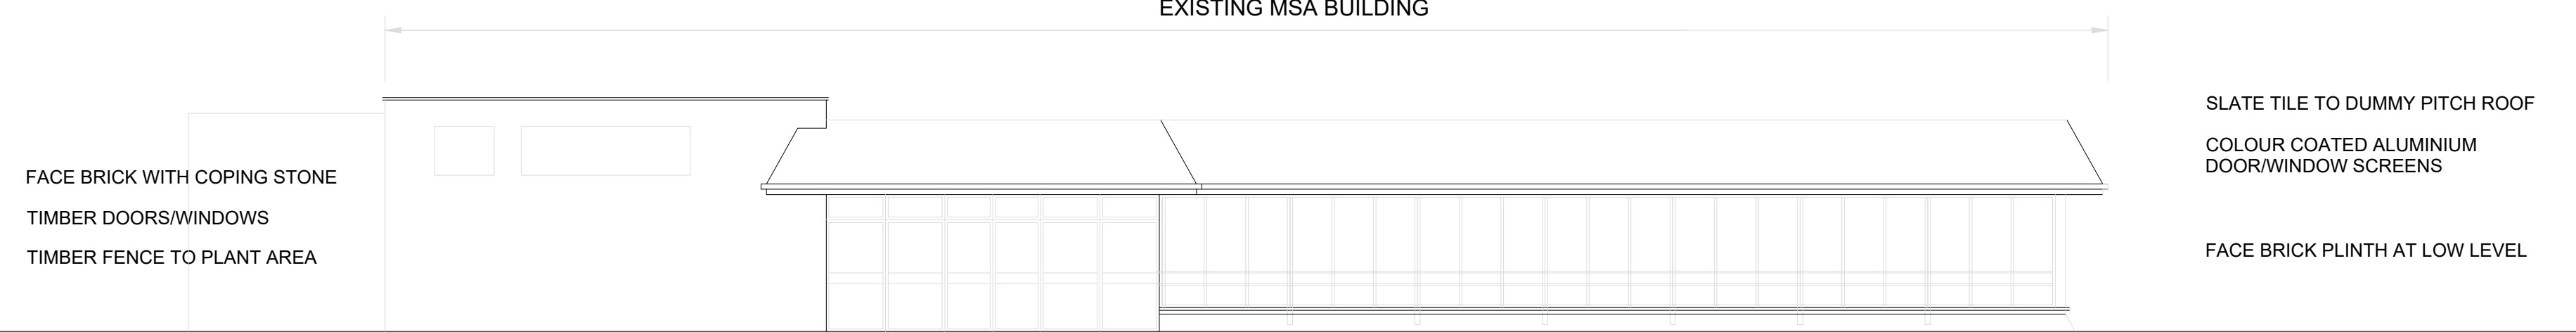


FACE BRICK WITH COPING STONE
TIMBER DOORS/WINDOWS
TIMBER FENCE TO PLANT AREA

SLATE TILE TO DUMMY PITCH ROOF
COLOUR COATED ALUMINIUM
DOOR/WINDOW SCREENS
FACE BRICK PLINTH AT LOW LEVEL

Existing South Elevation

Scale 1:100

EXISTING MSA BUILDING

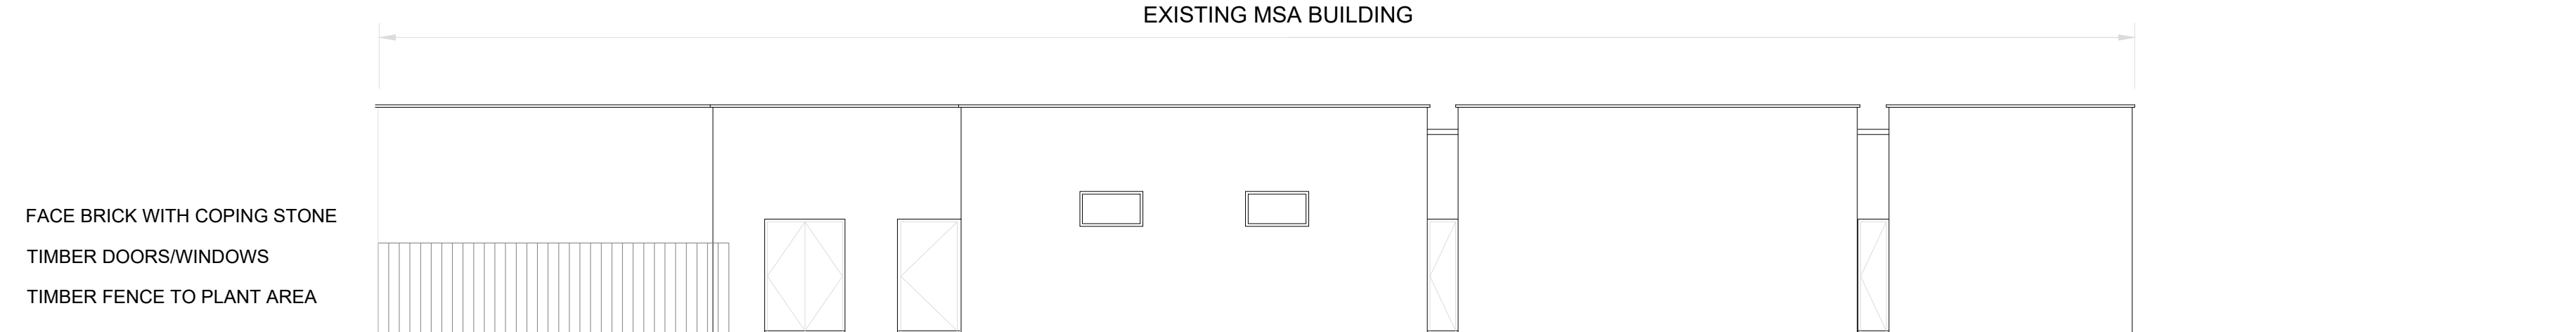

FACE BRICK WITH COPING STONE
TIMBER DOORS/WINDOWS
TIMBER FENCE TO PLANT AREA

Existing West Elevation

Scale 1:100



Rev. No	Date	Revision	Drawn by	Checked

Client



Project

Rownhams North - Proposed
McDonalds DT Scheme

Drawing

Elevations as Existing

ARCHITECTURE
DESIGN
DEVELOPMENT



Studio 3
The Drive
Kettering
NN15 7EX

Scale: 1:100@A1 Date: 19.09.23 SM GLN Drawn by: Checked by:

Job No: Reg No: Rev No:

RC578 | 102 | -