



MINIMUM 350mm END BEARINGS FOR STEEL OVER 4500mm SPAN BETWEEN SUPPORTS PADSTONES TO BE PLACED ON EXISTING WALL AS PER STRUCTURAL ENGINEERS DETAILS. EXISTING STEEL OVER TO BE SUPPORTED AND REMOVED WHEN NECESSARY REPLACE WITH BEAM AS SPECIFIED BY STRUCTURAL ENGINEER. ENCASE IN 2x12.5mm 30MIN FIRE RATED PLASTERBOARD AND FINISH AS APPROPRIATE.

THERMABATE 100 OR SIMILAR CAVITY CLOSER TO ALL WINDOW AND EXTERNAL DOOR REVEALS TO PREVENT THERMAL BRIDGING.

OUTLINE OF 650MM WIDE TRENCH FILL FOUNDATION, MIN DEPTH 1000MM BELOW FINISHED GROUND LEVEL. FINAL DEPTH TO BE DETERMINED AFTER INSPECTION BY BUILDING CONTROL OFFICER.

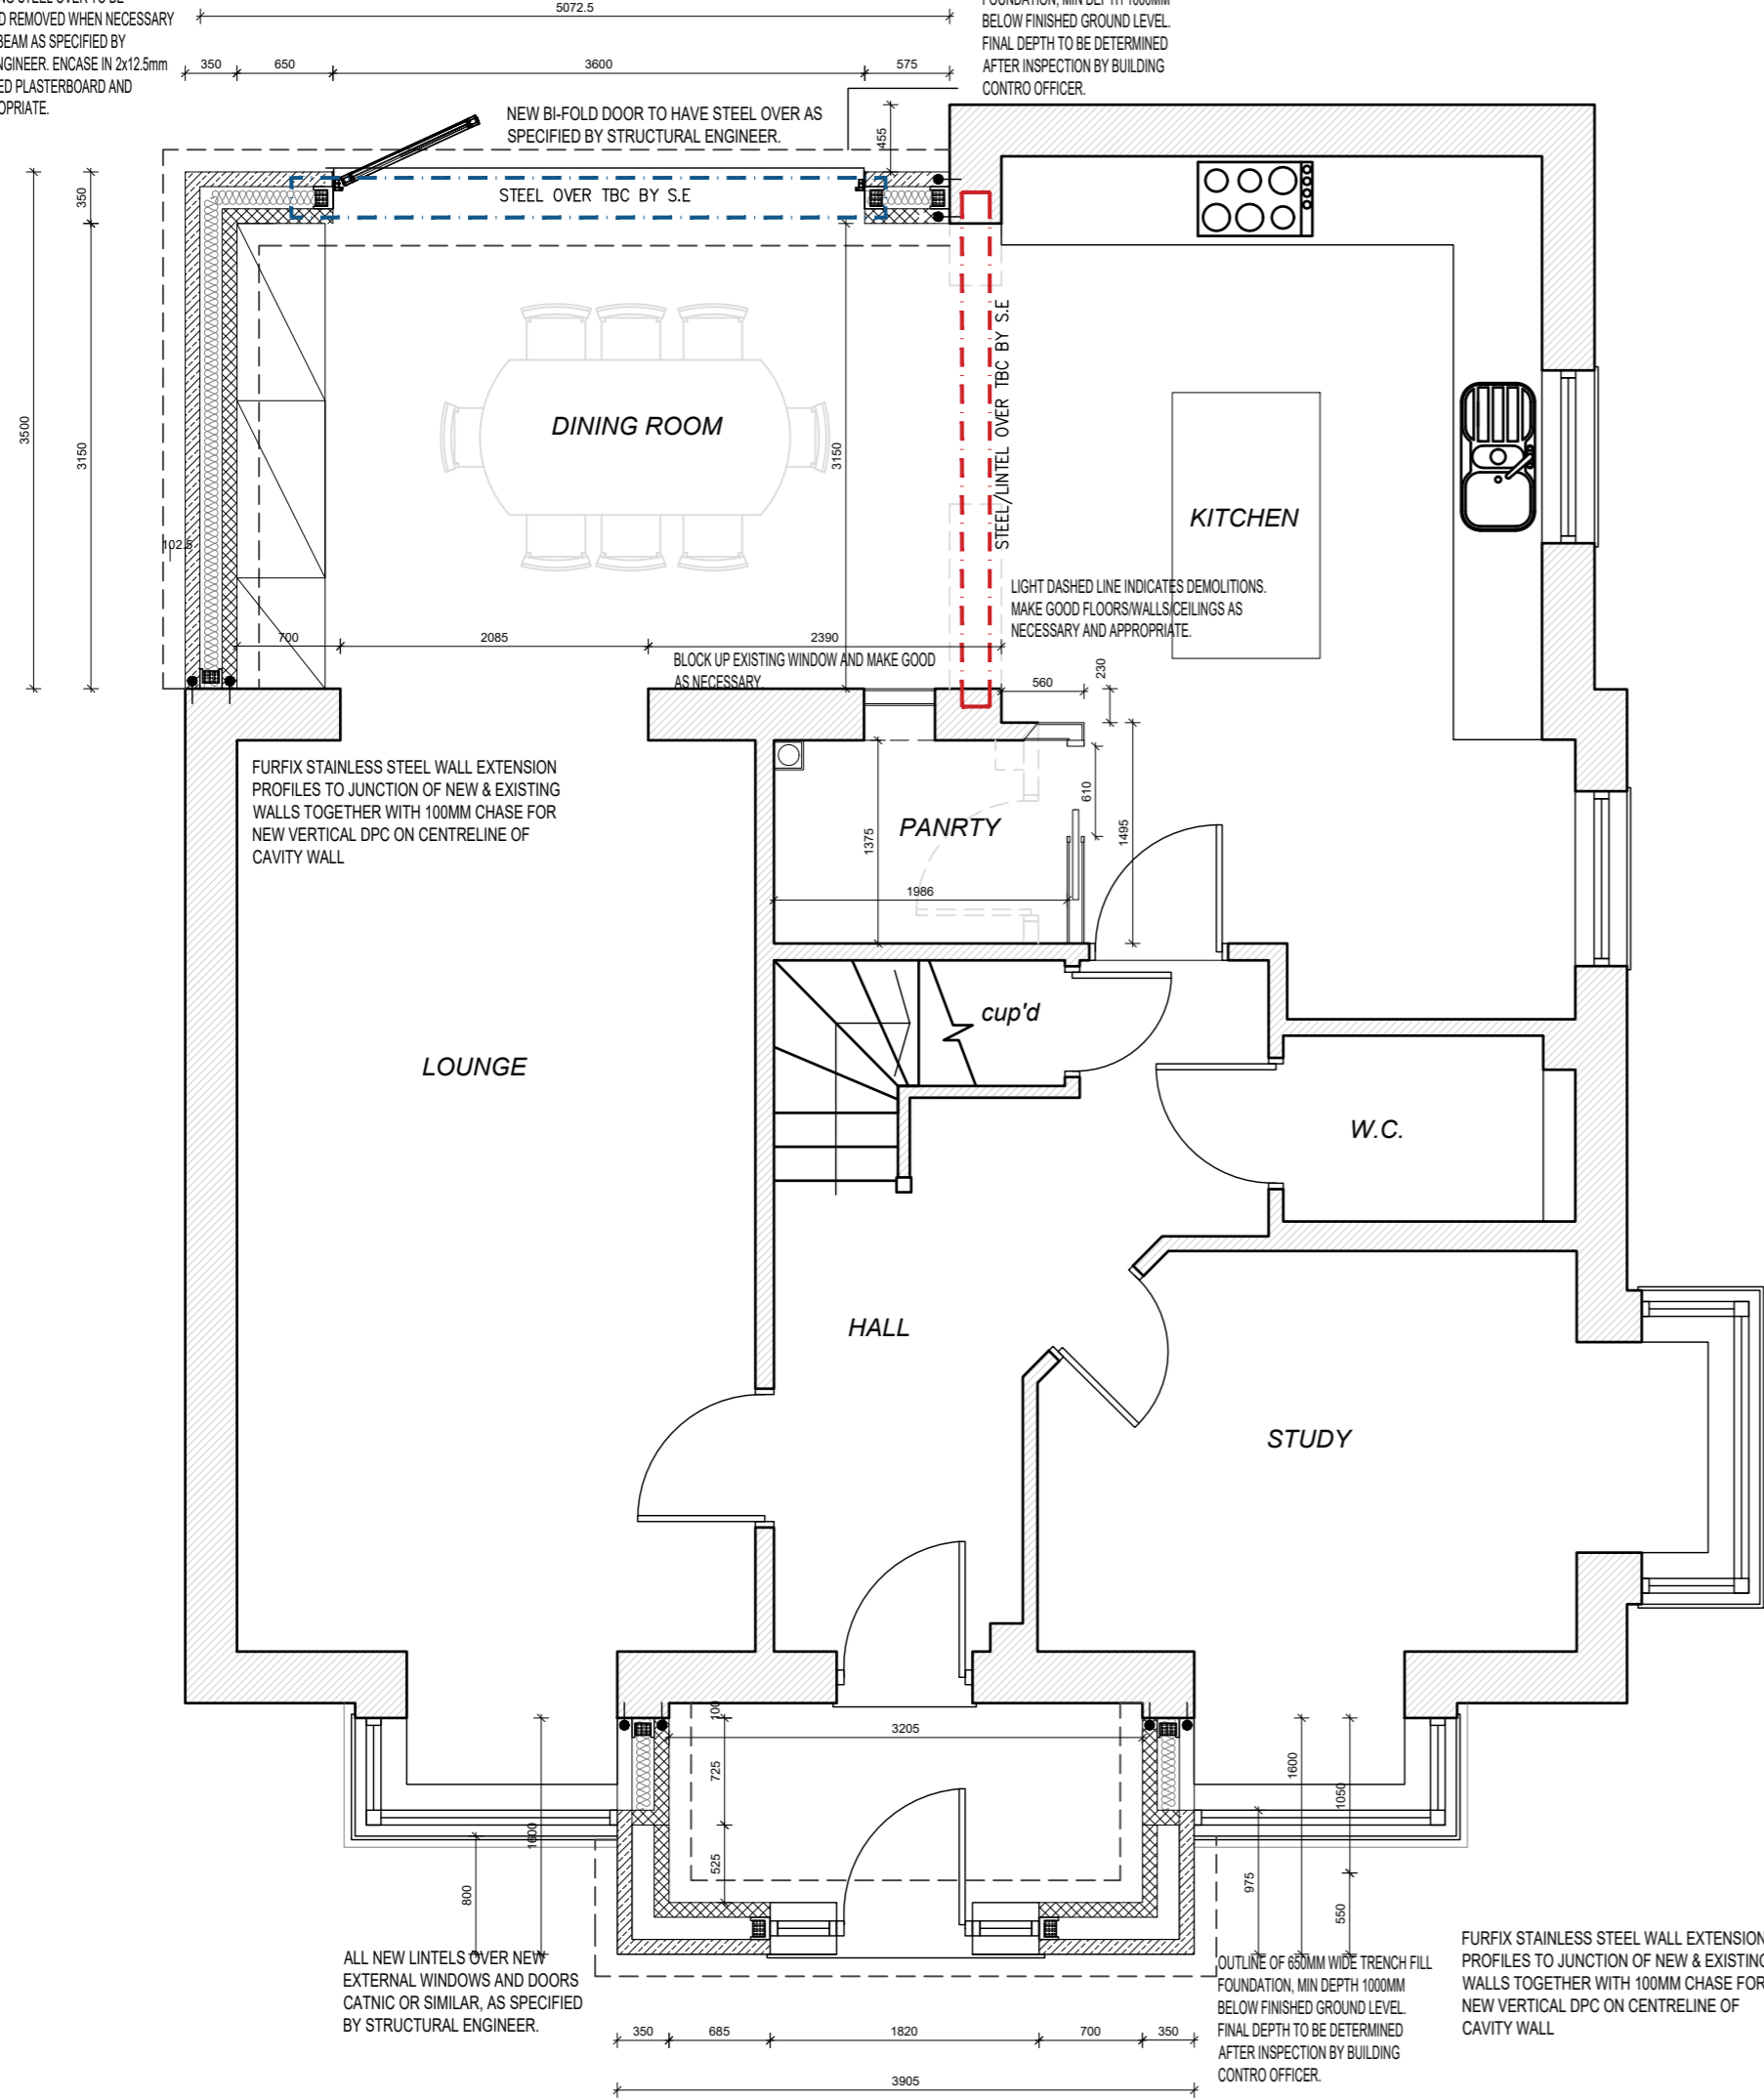

PROPOSED GROUND FLOOR PLAN - 1 : 50

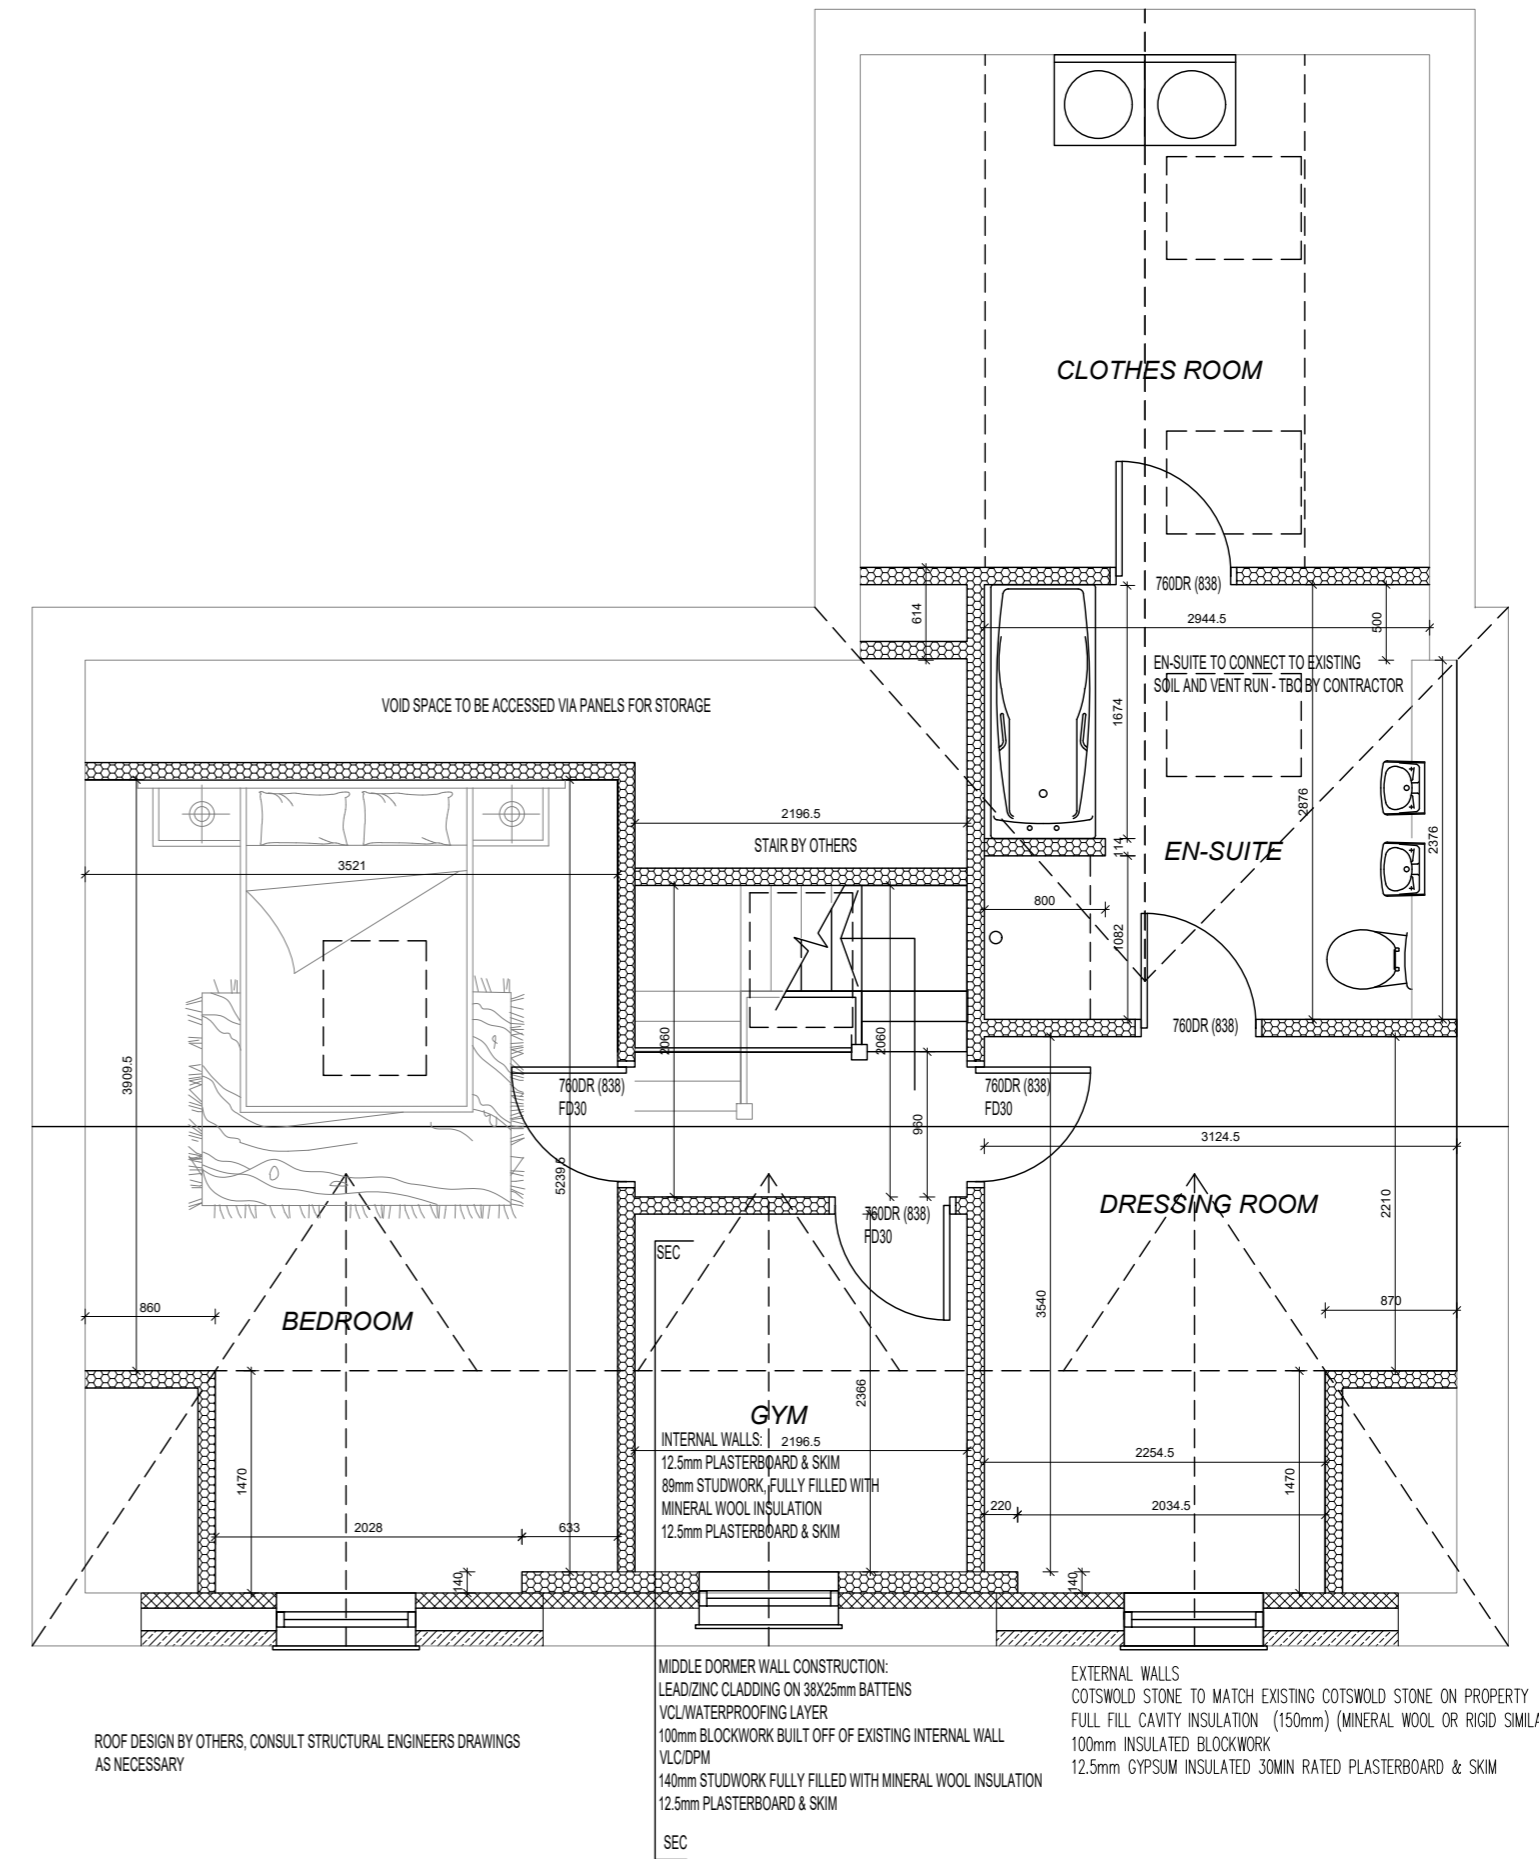

PROPOSED LOFT PLAN - 1 : 50

NOTES:
RESPONSIBILITY IS NOT ACCEPTED FOR ERRORS MADE BY OTHERS IN SCALING FROM THIS DRAWING.
ALL CONSTRUCTION INFORMATION SHOULD BE TAKEN FROM FIGURED DIMENSIONS ONLY
NO WARRANT AS TO THE PRECISION OF THIS DRAWING IS GIVEN NOR SHOULD BE INFERRED
CONSTRUCTION DRAWINGS TO BE READ IN CONJUNCTION WITH SPECIFICATIONS, SCHEDULES AND DRAWINGS FROM STRUCTURAL AND MECHANICAL ENGINEERS.

DRAWING SUBJECT TO STRUCTURAL ENGINEERS DETAILS AND DESIGNS. INCLUDING SPECIALIST ROOF MANUFACTURER DETAILS

CLIENT 91 BUILDERS	SCALE 1:50 @ A2	DATE NOV '20
PROJECT 4, MEADOW SWEET DRIVE	DRAWN DJA	CHECKED DJA
DRAWING TITLE PRELIM GROUND FLOOR PLAN	JOB NUMBER 20351	DRAWING NO. GA04
		REVISION 0

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